

LOCUS MAP NOT TO SCALE



RE-BID SITE IMPROVEMENTS AT GANO ST PARK

HONORABLE
BRETT P. SMILEY
MAYOR

WENDY NILSSON
SUPERINTENDENT OF PARKS

JOHN GONCALVES
CITY COUNCILOR

SHEET SCHEDULE

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- E-1-6 MUSCO ATHLETIC FIELD LIGHTING PLANS
- C1 MUSCO POLE FOUNDATION

IRRIGATION NOTES

1. PIPE AND VALVE LOCATIONS ARE DIAGRAMMATIC, CONTRACTOR SHALL FIELD VERIFY.
2. CONTROL WIRE SHALL BE #14 GAUGE SINGLE STRAND RED, COMMON WIRE SHALL BE #12 GAUGE SINGLE STRAND WHITE, AND SPARE WIRES, INSTALLED WHERE SHOWN, SHALL BE #14 GAUGE SINGLE STRAND BLUE.
3. QUICK COUPLING VALVES SHALL BE INSTALLED ON 1" PVC SWING JOINTS WITH BRASS INSERTS AND STABILIZERS (SEE DETAIL).
4. ROTARY SPRINKLERS SHALL BE INSTALLED ON 1" PVC PREFABRICATED UNITIZED SWING JOINT ASSEMBLIES WITH INTEGRAL O-RINGS.
5. IRRIGATION SYSTEM IS DESIGNED TO SUPPLY 50 GPM MAX FROM NEW 2" SERVICE. SYSTEM TO PRODUCE 70-PSI DYNAMIC PRESSURE AT IRRIGATION CONTRACTOR'S POINT OF CONNECTION DOWN STREAM OF NEW BOOSTER PUMP. CONTRACTOR TO VERIFY WATER PRESSURE AND VOLUME.
6. CONTRACTOR SHALL TEST DYNAMIC PRESSURE BEFORE STARTING WORK. REPORT ANY DEVIATION FROM PRESSURE REQUIRED TO OWNER'S REPRESENTATIVE BEFORE CONTINUING.
7. INSTALL CONTROLLER IN CONCESSIONS MECHANICAL ROOM AS DIRECTED BY OWNER'S REPRESENTATIVE, HARD WIRE TO 120 VOLT BUILDING POWER SUPPLY. ROUTE ZONE AND SPARE WIRES TO CONTROLLER VIA 2" CONDUIT.
8. INSTALL RAIN SENSOR ON EXTERIOR BUILDING WALL WHERE DIRECTED BY OWNER'S REPRESENTATIVE. EXTERIOR RAIN SENSOR WIRING SHALL BE CONTAINED IN 1/2" SCHEDULE PVC ELECTRICAL CONDUIT, SECURED TO OUTSIDE OF BUILDING WALL.
9. COORDINATE LOCATION OF EXISTING AND FUTURE UTILITIES ON SITE AND CONTACT PROPER AUTHORITIES AND UTILITY COMPANIES BEFORE THE START OF WORK.
10. FLUSH LATERAL LINES BEFORE INSTALLING SPRINKLERS.
11. CONTRACTOR MUST PROVIDE PRODUCT SUBMITTALS AS PER THE WRITTEN SPECIFICATIONS TO THE OWNER'S REPRESENTATIVE FOR APPROVAL PRIOR TO ORDERING MATERIAL AND BEGINNING WORK.
12. ONCE APPROVED SUBMITTALS HAVE BEEN RETURNED TO THE CONTRACTOR WORK MAY BEGIN. THE OWNER'S REPRESENTATIVE MUST BE NOTIFIED A MINIMUM OF SEVEN (7) DAYS IN ADVANCE OF WORK TO COORDINATE ON-SITE SUPERVISION AND ADMINISTRATION.
13. SEE IRRIGATION DETAILS AND SPECIFICATIONS FOR ADDITIONAL NECESSARY INFORMATION.
14. CONTRACTOR TO VERIFY PRESSURE AND VOLUME PRIOR TO INSTALLATION.
15. ALL AREAS DISTURBED BY IRRIGATION LINE INSTALLATION TO BE LOAMED AND SEEDED.

DEMOLITION PLAN GENERAL NOTES

1. ALL SITE PREPARATION NECESSARY TO COMPLETE THIS PROJECT IS THE SOLE RESPONSIBILITY OF THE CONTRACTOR.
2. IT IS THE CONTRACTOR'S RESPONSIBILITY TO COORDINATE WITH PROVIDENCE PARKS DEPARTMENT STAFF TO DEVELOP A SUITABLE DEMOLITION PLAN, WHICH WILL MINIMIZE PARK DISTURBANCE AND ALLOW ALL FACILITIES TO REMAIN IN OPERATION DURING THE ENTIRETY OF CONSTRUCTION.
3. UNLESS OTHERWISE NOTED, THE CONTRACTOR IS RESPONSIBLE FOR THE RELOCATION, DEMOLITION, REMOVAL AND DISPOSAL, IN A LOCATION APPROVED BY ALL GOVERNING AUTHORITIES, OF ALL EXISTING SITE ELEMENTS AND STRUCTURES INCLUDING BUT NOT LIMITED TO BITUMINOUS CONCRETE, CEMENT CONCRETE, GRAVEL, CURBS, WALKWAYS, SIDEWALKS, BERMS, FENCES, BOLLARDS, POSTS, PLANTING BEDS, TREES, SHRUBS, UTILITIES, DRAINAGE STRUCTURES AND ALL OTHER STRUCTURES SHOWN WITHIN THE LIMITS, AND WHERE NEEDED, TO ALLOW FOR NEW CONSTRUCTION. ALL ELEMENTS TO BE REMOVED SHALL BE UNDERCUT TO SUITABLE MATERIAL AND BROUGHT TO GRADE WITH SUITABLE COMPACTED FILL MATERIAL PER SPECIFICATIONS.
4. THE CONTRACTOR IS RESPONSIBLE FOR REMOVING ALL DEBRIS FROM THE SITE AND DISPOSING OF THE DEBRIS IN A PROPER AND LEGAL MANNER.
5. THE CONTRACTOR IS SPECIFICALLY CAUTIONED THAT THE LOCATION AND/OR ELEVATION OF EXISTING UTILITIES AND STRUCTURES AS SHOWN ON THESE PLANS ARE BASED ON RECORDS OF VARIOUS UTILITY COMPANIES, AND WHEREVER POSSIBLE, MEASUREMENTS TAKEN IN THE FIELD. THIS INFORMATION IS NOT TO BE RELIED UPON AS BEING EXACT OR COMPLETE. THE LOCATION OF ALL UNDERGROUND UTILITIES AND STRUCTURES SHALL BE VERIFIED IN THE FIELD BY THE CONTRACTOR PRIOR TO THE START OF CONSTRUCTION. THE CONTRACTOR MUST CONTACT THE APPROPRIATE UTILITY COMPANY, ANY GOVERNING PERMITTING AUTHORITY IN THE CITY, AND "DIGSAFE" (1-800-344-7233) AT LEAST 72 HOURS PRIOR TO ANY EXCAVATION WORK IN PREVIOUSLY UNALTERED AREAS TO REQUEST EXACT FIELD LOCATION OF UTILITIES. IT SHALL BE THE RESPONSIBILITY OF THE CONTRACTOR TO RESOLVE CONFLICTS BETWEEN THE PROPOSED UTILITIES AND FIELD-LOCATED UTILITIES AND SHALL REPORT ANY DISCREPANCIES TO THE LANDSCAPE ARCHITECT IMMEDIATELY. THE OWNER ASSUMES NO RESPONSIBILITY FOR DAMAGES INCURRED AS A RESULT OF UTILITIES OMITTED, INCOMPLETELY OR INACCURATELY SHOWN. THE CONTRACTOR SHALL BE RESPONSIBLE FOR MAINTAINING ACCURATE RECORDS OF THE LOCATION AND ELEVATION OF ALL WORK INSTALLED AND EXISTING UTILITIES FOUND DURING CONSTRUCTION FOR THE PREPARATION OF THE AS-BUILT PLAN.
6. THE CONTRACTOR IS RESPONSIBLE FOR MAINTAINING ALL EXISTING UTILITIES IN WORKING ORDER AND FREE FROM DAMAGE DURING THE ENTIRE DURATION OF THE PROJECT. ALL COST RELATED TO THE REPAIR OF UTILITIES SHALL BE THE RESPONSIBILITY OF THE CONTRACTOR. EXCAVATION REQUIRED WITHIN THE PROXIMITY OF EXISTING UTILITY LINES SHALL BE DONE BY HAND. CONTRACTOR SHALL REPAIR ANY DAMAGE TO EXISTING UTILITY LINE OR STRUCTURES INCURRED DURING CONSTRUCTION OPERATIONS AT NO COST TO THE OWNER.
7. THE CONTRACTOR SHALL MAINTAIN CONTINUOUS ACCESS AND OPERATION FOR SURROUNDING FACILITIES, AS DEEMED BY THE OWNER, AT ALL TIMES DURING DEMOLITION OF THE EXISTING FACILITIES.
8. PRIOR TO DEMOLITION OCCURRING, ALL EROSION CONTROL DEVICES AND TREE PROTECTIVE MEASURES ARE TO BE INSTALLED.

EROSION & SEDIMENT CONTROL NOTES

1. THE SITE CONSTRUCTION FOREMAN SHALL BE DESIGNATED AS THE ON-SITE PERSONNEL RESPONSIBLE FOR THE DAILY INSPECTION AND MAINTENANCE OF ALL ESC MEASURES AND SHALL IMPLEMENT ALL NECESSARY MEASURES TO CONTROL EROSION AND PREVENT SEDIMENT FROM LEAVING THE SITE.
2. THE CONTRACTOR SHALL INSTALL ALL ESC MEASURES AS SHOWN ON THE DESIGN PLANS AND AS DETERMINED NECESSARY IN THE FIELD BY OWNER'S REPRESENTATIVE BEFORE ANY CONSTRUCTION ACTIVITIES ARE TO BEGIN. THESE MEASURES SHALL BE CHECKED, MAINTAINED/REPLACED AS NECESSARY DURING THE ENTIRE CONSTRUCTION PERIOD OF THE PROJECT. SUCH MEASURES SHALL REPRESENT THE LIMIT OF WORK. WORKERS SHALL BE INFORMED THAT NO CONSTRUCTION ACTIVITY IS TO OCCUR BEYOND THE LIMIT OF WORK AT ANY TIME THROUGH THE CONSTRUCTION PERIOD.
3. A MINIMUM SURPLUS OF 100 FEET OF EROSION CONTROL BARRIER (SILT FENCE&/OR SILT SOCK) SHALL BE STOCKPILED ONSITE AT ALL TIMES.
4. THE CONTRACTOR SHALL PROTECT THE ADJACENT AREA FROM SEDIMENTATION DURING PROJECT CONSTRUCTION OPERATIONS.
5. A CONSTRUCTION EXIT SHALL BE CONSTRUCTED TO SHED DIRT FROM CONSTRUCTION VEHICLE TIRES. THE CONSTRUCTION EXIT SHALL BE REPLACED/CLEANED AS NEEDED TO MAINTAIN ITS EFFECTIVENESS.
6. THE LIMIT OF ALL CLEARING, GRADING AND DISTURBANCES SHALL BE KEPT TO A MINIMUM WITHIN THE PROPOSED AREA OF CONSTRUCTION. THE CONTRACTOR SHALL PHASE THE SITE WORK IN A MANNER TO MINIMIZE AREAS OF EXPOSED SOIL.
7. IT IS THE CONTRACTOR'S RESPONSIBILITY TO MONITOR LOCAL WEATHER REPORTS DURING CONSTRUCTION AND PRIOR TO SCHEDULING EARTHMOVING OR OTHER CONSTRUCTION ACTIVITIES WHICH WILL LEAVE LARGE DISTURBED AREAS UNSTABILIZED. IF INCLEMENT WEATHER IS PREDICTED, THE CONTRACTOR SHALL USE THEIR BEST PROFESSIONAL JUDGEMENT AND SHALL BE RESPONSIBLE FOR ENSURING THAT NECESSARY EROSION CONTROL DEVICES ARE INSTALLED AND FUNCTIONING PROPERLY TO MINIMIZE EROSION FROM ANY IMPENDING WEATHER EVENTS.
8. SOIL ESC MEASURES SHALL BE INSPECTED AND MAINTAINED ON A WEEKLY BASIS AND AFTER EACH RAINFALL EVENT OF 0.25 INCH OR GREATER DURING CONSTRUCTION TO ENSURE THAT THE ESC MEASURES ARE INTACT AND FUNCTIONING PROPERLY. IDENTIFIED DEFICIENCIES SHALL BE CORRECTED IMMEDIATELY NO LATER THAN 24 HOURS AFTER IDENTIFICATION.

9. SOIL STOCKPILES LEFT OVERNIGHT SHALL BE SURROUNDED ON THEIR PERIMETERS WITH SILT SOCK.
10. DISTURBED AREAS AND SLOPES SHALL NOT BE LEFT UNATTENDED OR EXPOSED FOR EXCESSIVE PERIODS OF TIME SUCH AS THE INACTIVE WINTER SEASON. THE CONTRACTOR SHOULD PROVIDE APPROPRIATE STABILIZATION PRACTICES ON ALL DISTURBED AREAS AS SOON AS POSSIBLE BUT NOT MORE THAN 14 DAYS AFTER THE CONSTRUCTION ACTIVITY IN THAT AREA HAS TEMPORARILY OR PERMANENTLY CEASED. TEMPORARY AREAS HAVING A SLOPE GREATER THAN 3:1 SHALL BE REINFORCED WITH EROSION BLANKETS OR APPROVED EQUAL UNTIL THE SITE IS PROPERLY STABILIZED. TEMPORARY SWALES MAY ALSO BE REQUIRED IF DETERMINED NECESSARY IN THE FIELD BY OWNER'S REPRESENTATIVE.
11. THE CONTRACTOR SHALL CONTAIN ALL SEDIMENT ONSITE. ALL EXITS FROM THE SITE WILL BE SWEEPED AS NECESSARY INCLUDING ANY SEDIMENT TRACKING. PAVED AREAS SHALL BE SWEEPED AS NEEDED TO REMOVE SEDIMENT AND POTENTIAL POLLUTANTS WHICH MAY ACCUMULATE DURING SITE WORK.
12. ACCUMULATED SEDIMENT SHALL BE REMOVED FROM ALL ESC MEASURES AND DISPOSED OF IN A PRE-APPROVED LOCATION BY THE CONTRACTOR.
13. DUST SHALL BE CONTROLLED BY WATERING OR OTHER APPROVED METHODS AS NECESSARY.

GENERAL CONSTRUCTION NOTES

1. INFORMATION FOR THE EXISTING CONDITIONS PLAN WAS OBTAINED FROM GIS, AERIAL IMAGERY, FIELD OBSERVATION, AND PARTIAL SURVEY. ALL EXISTING CONDITIONS ARE TO BE CONSIDERED APPROXIMATE. THIS IS NOT A REGISTERED SURVEY.
2. ANY ERRORS OR DISCREPANCIES ON THE DRAWINGS, SHOP DRAWINGS, AND DETAILS ARE TO BE BROUGHT TO THE ATTENTION OF THE OWNER'S REPRESENTATIVE BEFORE THE WORK HAS COMMENCED.
3. THE CONTRACTOR IS RESPONSIBLE FOR FIELD VERIFICATION OF ALL LOCATIONS AND DIMENSIONS. DISCREPANCIES BETWEEN LAYOUT DIMENSIONS ON PLANS AND ACTUAL MEASUREMENTS IN FIELD ARE TO BE REPORTED TO THE OWNER'S REPRESENTATIVE BEFORE CONSTRUCTION BEGINS.
4. THE CONTRACTOR SHALL NOTIFY THE OWNER'S REPRESENTATIVE PRIOR TO DEMOLITION OR INSTALLATION OF ANY PORTION OF THE SITE WORK.
5. THE CONTRACTOR SHALL STAKE OUT ALL LAYOUTS OF PROPOSED WORK FOR APPROVAL BY THE OWNER'S REPRESENTATIVE PRIOR TO COMMENCING WORK.
6. THE CONTRACTOR SHALL BE RESPONSIBLE FOR ESTABLISHING AND MAINTAINING ALL CONTROL POINTS AND BENCHMARKS DURING CONSTRUCTION INCLUDING BENCHMARK LOCATIONS AND ELEVATIONS AT CRITICAL AREAS. THE LOCATION OF ALL CONTROL POINTS AND BENCHMARKS SHALL BE COORDINATED WITH THE OWNER'S REPRESENTATIVE.
7. UNLESS OTHERWISE SPECIFIED ON THE PLANS AND DETAILS/SPECIFICATIONS, ALL SITE CONSTRUCTION MATERIALS AND METHODOLOGIES ARE TO CONFORM TO THE MOST RECENT VERSION OF THE RHODE ISLAND DEPARTMENT OF TRANSPORTATION STANDARD SPECIFICATIONS (THE RHODE ISLAND DEPARTMENT OF TRANSPORTATION STANDARD SPECIFICATIONS FOR ROAD AND BRIDGE CONSTRUCTION 2015 EDITION).
8. CONSTRUCTION SHALL BE PERFORMED IN ACCORDANCE WITH APPLICABLE LAWS AND REGULATIONS REGARDING NOISE, VIBRATION, DUST, SEDIMENTATION CONTAINMENT, AND TRENCH WORK.
9. THE CONTRACTOR SHALL RESTORE ALL SURFACES EQUAL TO THEIR ORIGINAL CONDITION AFTER CONSTRUCTION IS COMPLETE. AREAS NOT DISTURBED BY CONSTRUCTION SHALL BE LEFT NATURAL. THE CONTRACTOR SHALL TAKE CARE TO PREVENT DAMAGE TO SHRUBS, TREES, AND OTHER LANDSCAPING OR NATURAL FEATURES, WHEREAS THE PLANS DO NOT SHOW ALL LANDSCAPING FEATURES. EXISTING CONDITIONS MUST BE VERIFIED BY THE CONTRACTOR IN ADVANCE OF THE WORK.
10. ALL UNPAVED AREAS DISTURBED BY THE WORK SHALL HAVE A MINIMUM OF 4-INCHES OF LOAM INSTALLED AND SEEDED WITH GRASS SEED AS SHOWN ON THE PLAN AND/OR DIRECTED BY THE LANDSCAPE ARCHITECT. THE CONTRACTOR SHALL BE RESPONSIBLE FOR WATERING ANY LOAM AND SEEDED AREAS UNTIL LAWN GROWTH IS ESTABLISHED AND APPROVED BY THE LANDSCAPE ARCHITECT AND/OR OWNER'S REPRESENTATIVE.
11. THE CONTRACTOR SHALL REGULARLY INSPECT THE PERIMETER OF THE PROPERTY TO CLEAN UP AND REMOVE ANY LOOSE CONSTRUCTION DEBRIS BEFORE IT LEAVES THE SITE. ALL DEMOLITION DEBRIS SHALL BE PROMPTLY REMOVED FROM THE SITE TO AN APPROVED DUMP SITE. ALL TRUCKS LEAVING THE SITE SHALL BE COVERED.
12. CONCRETE TRUCKS SHALL NOT BE WASHED ONSITE. ANY CEMENT OR CONCRETE DEBRIS LEFT IN THE DISTURBED AREA SHALL BE REMOVED BY HAND AT THE CONTRACTOR'S EXPENSE.
13. IF ANY DEVIATION OR ALTERATION OF THE WORK PROPOSED ON THESE DRAWINGS IS REQUIRED, THE CONTRACTOR IS TO IMMEDIATELY CONTACT AND COORDINATE WITH THE LANDSCAPE ARCHITECT AND THE OWNER'S REPRESENTATIVE.
14. AT THE END OF CONSTRUCTION, THE CONTRACTOR SHALL REMOVE ALL CONSTRUCTION DEBRIS AND SURPLUS MATERIAL FROM THE SITE. A THOROUGH INSPECTION OF THE WORK PERIMETER IS TO BE MADE AND ALL DISCARDED MATERIALS, BLOWN OR WATER CARRIED DEBRIS, SHALL BE COLLECTED AND REMOVED FROM THE SITE.
15. THE CONTRACTOR IS RESPONSIBLE FOR SECURING THE SITE FOR THE SAFETY OF THE GENERAL PUBLIC AND TO PROTECT PROPERTY AGAINST VANDALISM AND THEFT.
16. THE CONTRACTOR MUST OBTAIN ALL REQUIRED CITY, STATE AND FEDERAL PERMITS.
17. THE PROVIDENCE PARKS DEPARTMENT ASSUMES NO RESPONSIBILITY IF THE WORK IS NOT INSTALLED AS PER THE PLANS OR IF FIELD CHANGES ARE MADE WITHOUT THE KNOWLEDGE AND APPROVAL OF THE OWNER'S REPRESENTATIVE.

LAYOUT NOTES

1. ALL LINES AND DIMENSIONS ARE PARALLEL OR PERPENDICULAR TO THE LINES FROM WHICH THEY ARE MEASURED UNLESS OTHERWISE INDICATED.
2. STORAGE AREAS FOR CONTRACTOR'S EQUIPMENT AND MATERIALS SHALL BE ON AND WITHIN LIMITS OF WORK AS SHOWN ON THE PLANS AND AS APPROVED BY THE OWNER'S REPRESENTATIVE.
3. CONTRACTOR SHALL VERIFY ALL EXISTING CONDITIONS IN THE FIELD AND REPORT ANY DISCREPANCIES IN THE PLAN TO THE OWNER'S REPRESENTATIVE PRIOR TO STARTING WORK.
4. ALL LAYOUTS FOR WALKS AND PATHS SHALL BE ADEQUATELY STAKED BY THE CONTRACTOR AND APPROVED BY THE OWNER'S REPRESENTATIVE PRIOR TO CONSTRUCTION.
5. ALL PLACEMENT OF SITE FURNISHINGS, BOULDERS, PLAY STRUCTURES AND OUTDOOR FITNESS EQUIPMENT TO BE APPROVED BY LANDSCAPE ARCHITECT PRIOR TO INSTALLATION.

PLANTING NOTES

1. ALL NEW PLANT MATERIALS SHALL CONFORM TO THE MINIMUM GUIDELINES ESTABLISHED FOR NURSERY STOCK PUBLISHED BY THE AMERICAN ASSOCIATION OF NURSERYMEN, INC. IN ADDITION, ALL NEW PLANT MATERIAL FOR THE PROJECT SHALL BE OF SPECIMEN QUALITY.
2. ALL NEW PLANTS TO BE BALLED AND BURLAPPED OR CONTAINER GROWN, UNLESS OTHERWISE NOTED ON THE PLANT LIST.
3. THE CONTRACTOR SHALL SUPPLY ALL NEW PLANT MATERIAL IN QUANTITIES SUFFICIENT TO COMPLETE THE PLANTING SHOWN ON THE DRAWINGS.
4. ANY PROPOSED SUBSTITUTIONS OF PLANT SPECIES SHALL BE MADE WITH PLANTS OF EQUIVALENT OVERALL FORM, HEIGHT, BRANCHING HABIT, FLOWER, LEAF, COLOR, FRUIT AND CULTURE, AND ONLY AFTER WRITTEN APPROVAL OF THE LANDSCAPE ARCHITECT.
5. ALL NEW PLANTS SHALL BE TAGGED AND APPROVED BY THE LANDSCAPE ARCHITECT AT THE NURSERY PRIOR TO DIGGING OR DELIVERY TO THE SITE.
6. CONTRACTOR SHALL LOCATE AND VERIFY ALL EXISTING UTILITY LINES PRIOR TO PLANTING AND SHALL REPORT ANY CONFLICTS TO THE LANDSCAPE ARCHITECT.
7. STAKE LOCATIONS OF ALL PROPOSED PLANTING FOR APPROVAL BY THE LANDSCAPE ARCHITECT PRIOR TO THE COMMENCEMENT OF PLANTING. INDIVIDUAL STAKES SHALL BE PLACED FOR TREES AND SHRUBS. EDGE OF PLANTING BEDS SHALL BE PAINTED. NOTIFY LANDSCAPE ARCHITECT 24 HOURS PRIOR TO DESIRED APPROVAL.
8. ALL NEW PLANTS SHALL BE SUPPLIED AND INSTALLED DURING THE PERIODS OF APRIL 1 - JUNE 15 AND/OR SEPTEMBER 1 - NOVEMBER 15 PER SPECIFICATIONS.
9. PREPARE ALL INDIVIDUAL TREE PITS AND SHRUB PLANTING BEDS TO A MINIMUM DEPTH OF EIGHTEEN INCHES (18") WITH SPECIFIED PLANTING MIX: 50% SCREENED TOPSOIL, 40% EXISTING SOIL AND 10% COMPOST. BLEND COMPOST INTO TOP 4" OF SOIL. PLANTING MIX SHALL BE FREE OF LUMPS, STONES, PLANTS, ROOTS, AND OTHER FOREIGN MATTER.
10. ALL SHRUB BEDS AND INDIVIDUAL TREE PITS SHALL RECEIVE THREE (3) INCHES OF BARK MULCH PER SPECIFICATIONS. PERENNIAL AND GROUNDCOVER BEDS SHALL RECEIVE TWO INCHES (2"). PROVIDE LANDSCAPE ARCHITECT WITH SAMPLE FOR APPROVAL.
11. ALL BURLAP, TWINE AND WIRE SHALL BE COMPLETELY REMOVED OR CUT AWAY AT TIME OF INSTALLATION.
12. PRUNE TREES IN ACCORDANCE WITH THE SPECIFICATIONS.
13. PLANT WARRANTY SHALL BE FOR ONE FULL GROWING SEASON FROM THE TIME OF SUBSTANTIAL COMPLETION.
14. LANDSCAPE CONTRACTOR SHALL BE RESPONSIBLE FOR REPLACING ALL DAMAGED, STOLEN, DEAD, DECLINING OR LOST MATERIAL UNTIL COMPLETION OF MAINTENANCE PERIODS OR GUARANTEE PERIODS.
15. IF NO IRRIGATION SYSTEM IS PLANNED, AN APPROPRIATE WATERING SCHEDULE SHALL BE ESTABLISHED BY THE LANDSCAPE CONTRACTOR FOR ALL PLANT MATERIAL BASED UPON PLANT SPECIES REQUIREMENTS AND PROVIDED IN WRITING TO THE LANDSCAPE ARCHITECT AND OWNER FOR REVIEW AND APPROVAL. THE APPROVED SCHEDULE SHOULD BE FOLLOWED UNTIL COMPLETION OF PLANT MAINTENANCE PERIODS OR WARRANTY PERIODS.
16. ALL VEGETATION AND DEBRIS SHALL BE REMOVED FROM PROPOSED PLANTING AREAS PRIOR TO PLANTING AND BACKFILLING. CONTRACTOR SHALL REMOVE ALL WEEDS AND DEBRIS FROM SITE AS WORK PROGRESSES AND UNTIL COMPLETION OF PLANT MAINTENANCE PERIODS OR WARRANTY PERIODS.
17. ALL AREAS TO BE SEEDED OR SODDED SHALL RECEIVE SIX INCHES (6") OF LOAM, MEASURED AFTER INSTALLATION, PRIOR TO SEEDING.
18. ALL EXISTING LAWN AREAS DESIGNED TO REMAIN SHALL BE AERATED, FERTILIZED AND OVERSEEDED, AS DIRECTED BY THE LANDSCAPE ARCHITECT.
19. IN ADDITION TO LOCATIONS DEFINED FOR SEED ON THE PLANTING PLAN, THE CONTRACTOR SHALL BE RESPONSIBLE FOR SEEDING ANY DISTURBED AREAS.
20. A DETAILED PLANT MAINTENANCE MANUAL SHALL BE ESTABLISHED BY THE LANDSCAPE CONTRACTOR FOR ALL PLANT MATERIAL BASED UPON PLANT SPECIES REQUIREMENTS AND PROVIDED IN WRITING TO THE LANDSCAPE ARCHITECT AND OWNER FOR REVIEW AND APPROVAL. INFORMATION THEREIN SHALL INCLUDE REQUIRED PRUNING SCHEDULE, FERTILIZING AND PROPOSED INTEGRATED PEST MANAGEMENT (IPM) AS NECESSARY. THE APPROVED MAINTENANCE SHOULD BE FOLLOWED UNTIL COMPLETION OF PLANT MAINTENANCE PERIODS OR WARRANTY PERIODS.
21. LANDSCAPE CONTRACTOR IS RESPONSIBLE FOR MAINTAINING CLOSE COORDINATION WITH OWNER, GENERAL CONTRACTOR, RELATED SUBCONTRACTORS, LANDSCAPE ARCHITECT, AND ALL SITE WORK RELATED ITEMS.



PROVIDENCE
PARKS DEPARTMENT
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STAMP

PROJECT:

Re-Bid Site Improvements at Gano St Park 87 Fremont St Providence, RI 02906

REVISIONS:

Date Issued For:

NORTH ARROW

SCALE

DRAWING INFO

DATE ISSUED: 01/16/25
PROJECT NO: GSPK.24.01
DRAWN BY: SH, II
CHECKED BY: MG

SHEET TITLE

Cover Sheet

L-1

1 OF 19



PROVIDENCE PARKS DEPARTMENT
 DALRYMPLE BOATHOUSE
 ROGER WILLIAMS PARK
 PROVIDENCE, RI 02905



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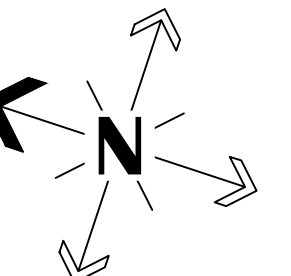
PROJECT:

Re-Bid Site Improvements at Gano St Park
 87 Fremont St
 Providence, RI 02906

REVISIONS:

Date Issued For:

NORTH ARROW



SCALE

0 20 40' 80'



SCALE: 1"=40'

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DATE ISSUED: 01/16/25
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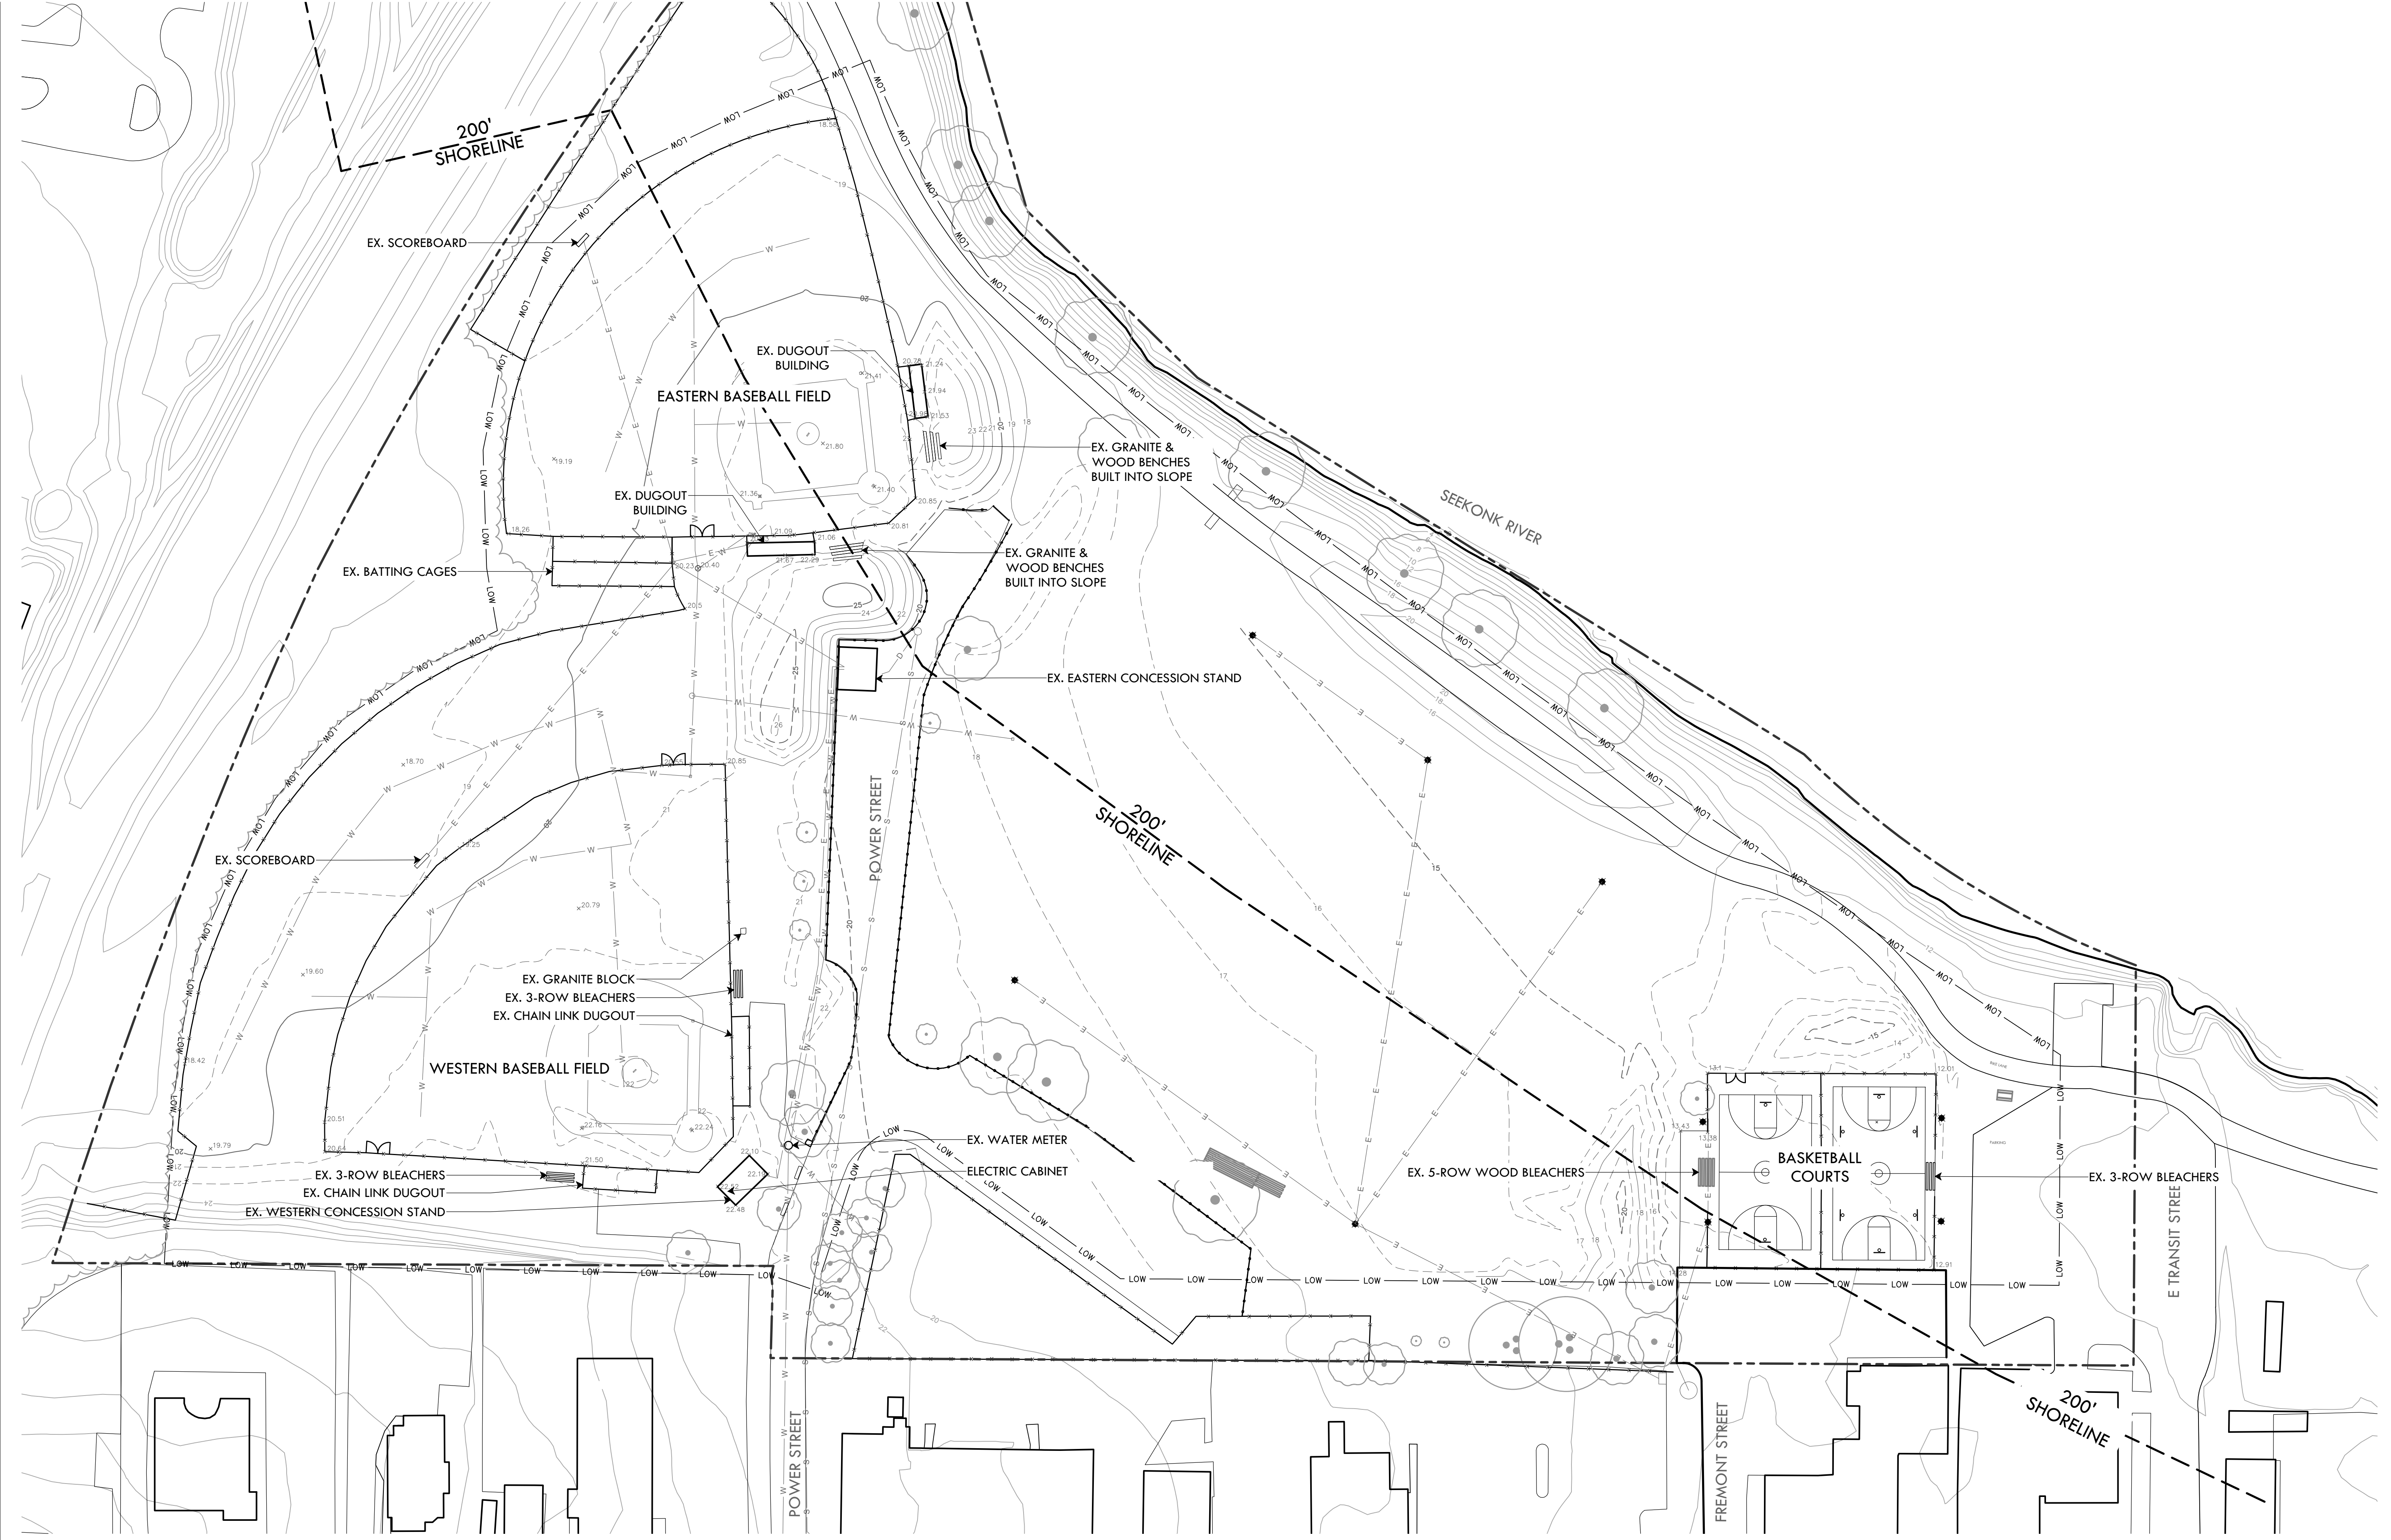
SHEET TITLE

Existing Conditions Plan

L-2

2 OF 19

FILE: GSPK24.01 - REBID.dwg



EXISTING CONDITIONS LEGEND

- LOW — LOW — LIMIT OF WORK (BASE BID) * EXISTING ATHLETIC FIELD LIGHTING - - - - - EXISTING CONTOUR
- - - - - PROPERTY LINE ———— EXISTING CHAIN LINK (CL) FENCE — S — S — EXISTING SEWER
- E — E — EXISTING ELECTRIC -97.96 EXISTING GRADE — W — W — EXISTING WATER



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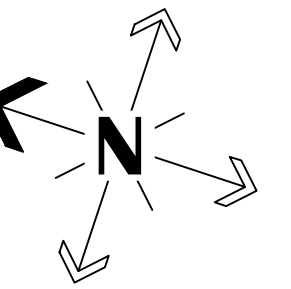
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Re-Bid Site Improvements at Gano St Park
87 Fremont St
Providence, RI 02906


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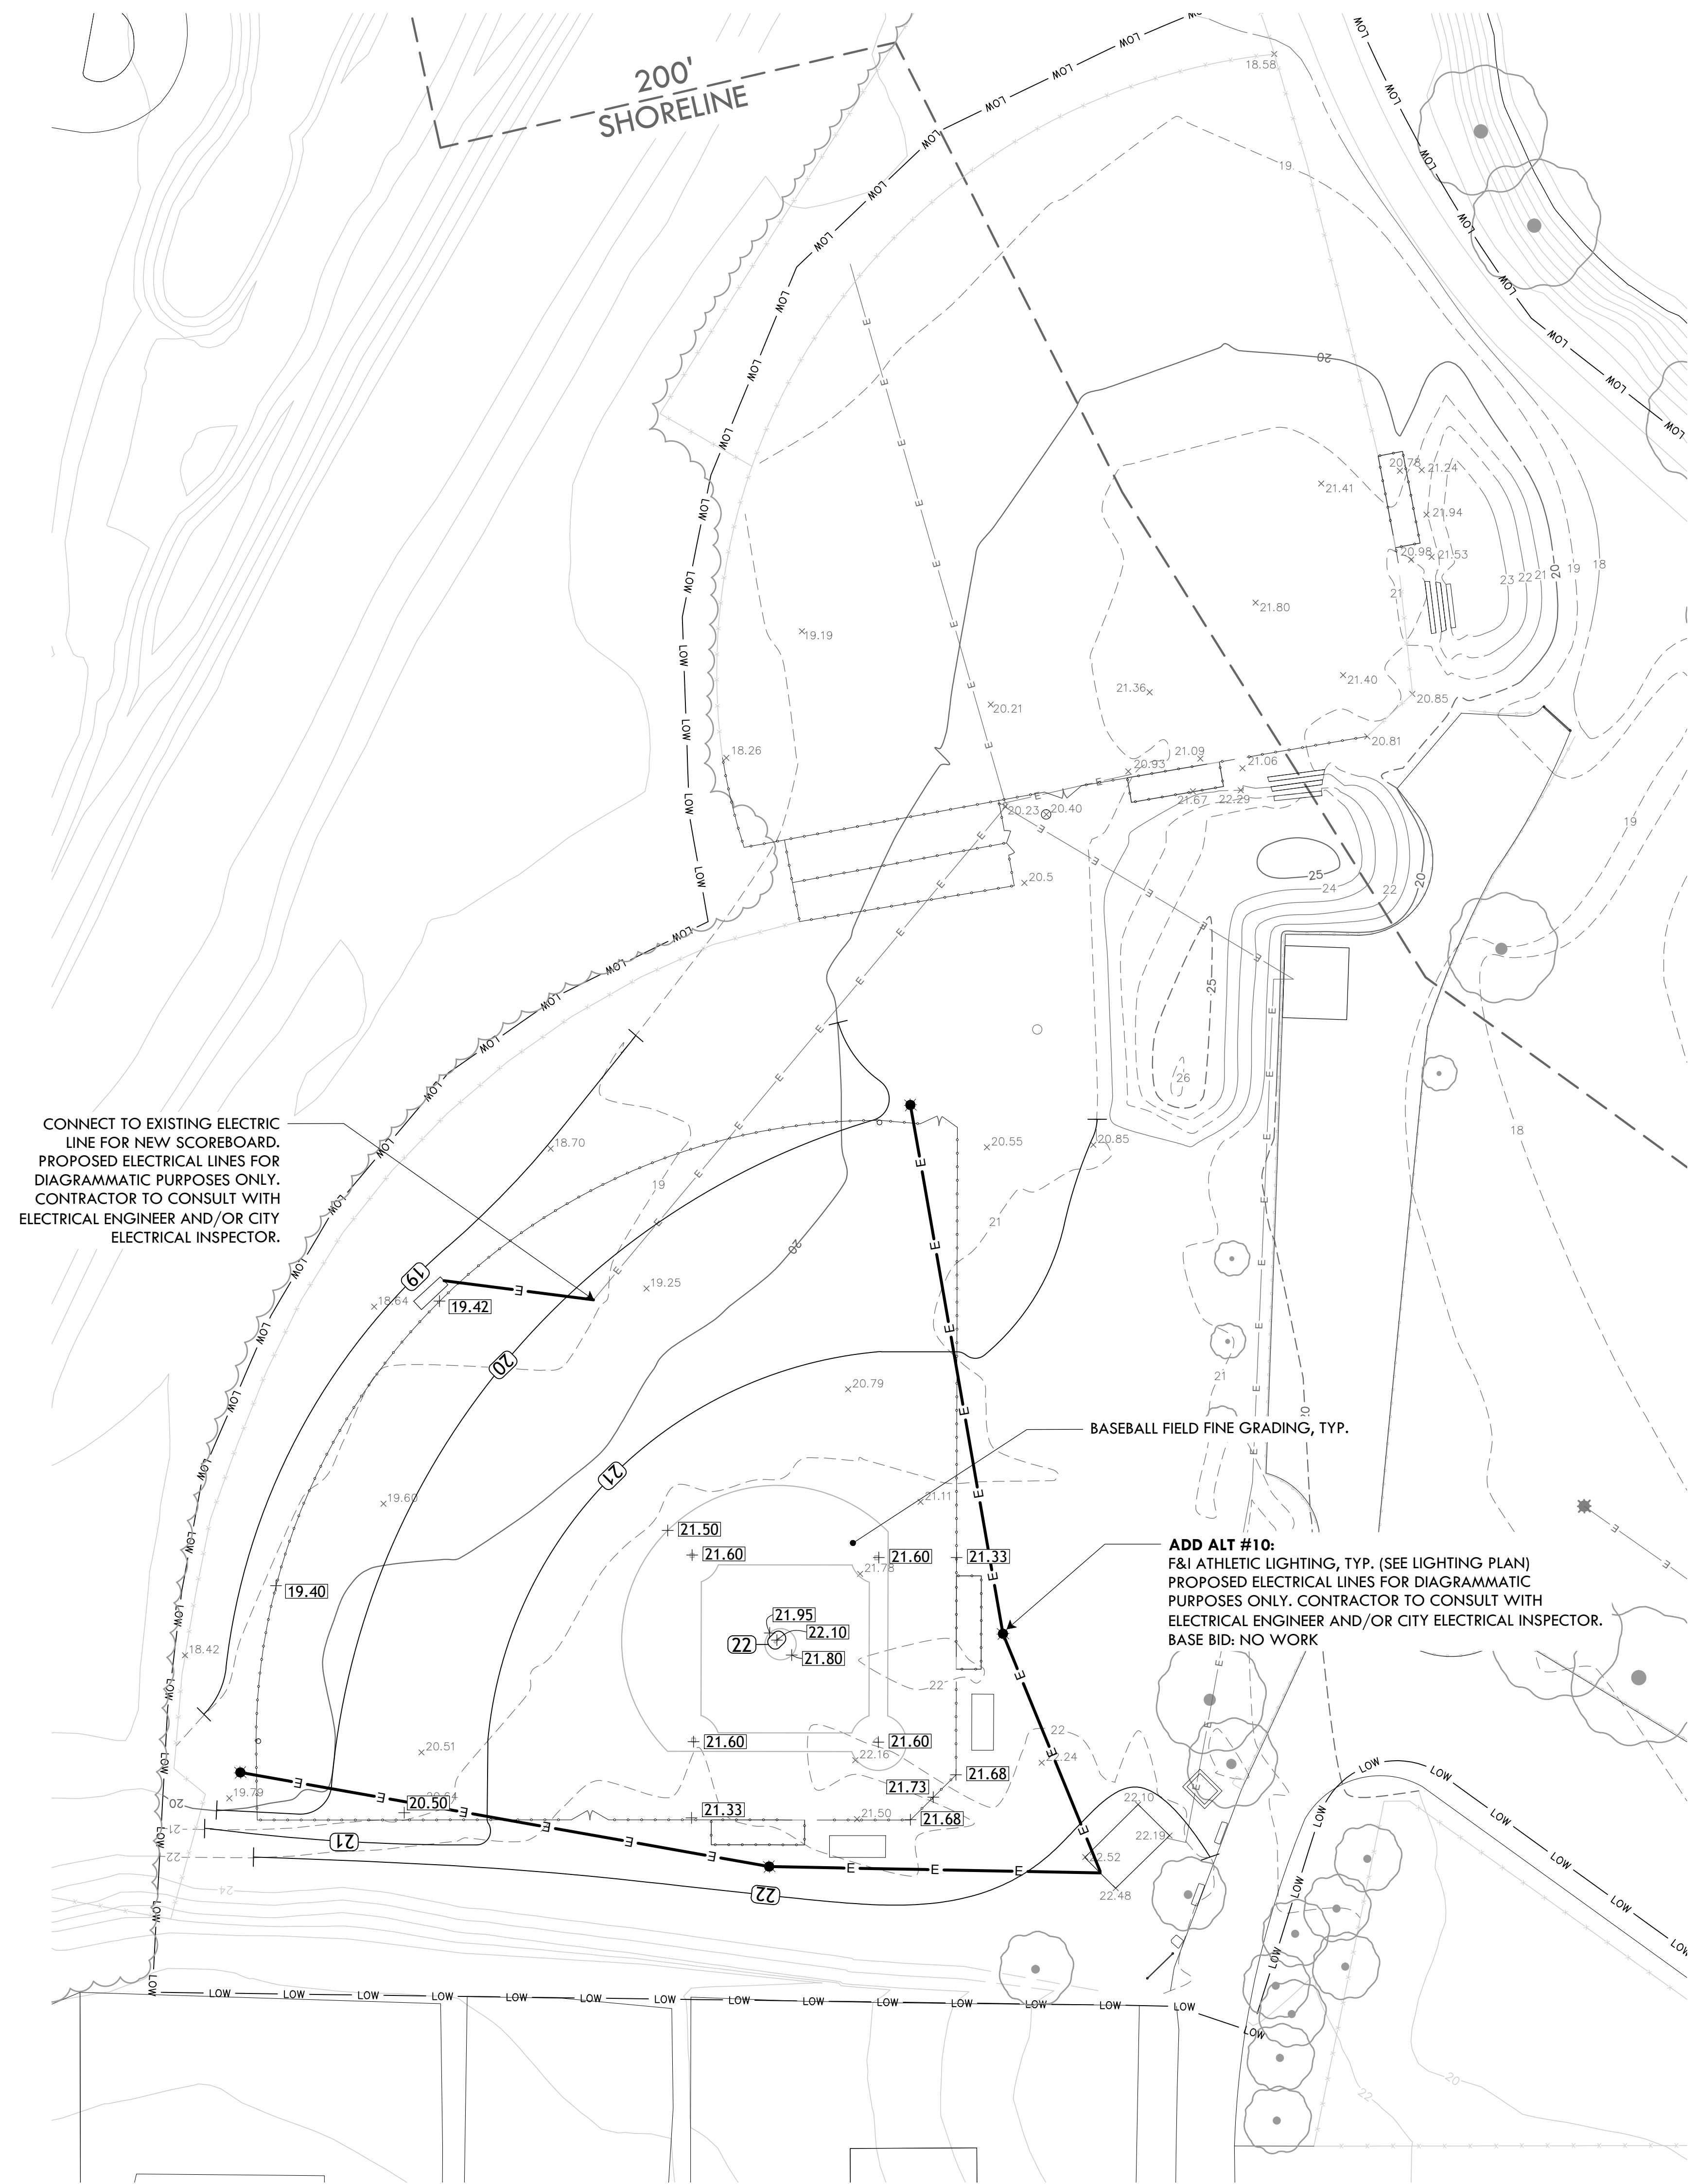
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Grading & Utility Plan

L-4

4 OF 19

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GRADING & UTILITY LEGEND



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| x97.96 | EXISTING GRADE | | PROPOSED ELECTRICAL LINES |
| +97.83 | PROPOSED GRADE | | EXISTING ELECTRICAL LINES |
| -88- | EXISTING CONTOUR | | |
| 99 | PROPOSED CONTOUR | | |

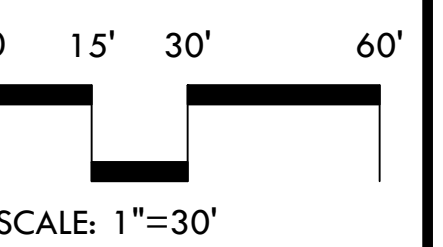NOTES:

METER AND BACK FLOW MUST BE ACCESSIBLE AT ALL TIMES.


CONTRACTOR SHALL CARRY ALL COST FOR FEES AND CHARGES BY PROVIDENCE WATER SUPPLY BOARD.

COST ASSOCIATED WITH TRAFFIC CONTROL SHALL BE PAID FOR BY THE CONTRACTOR.

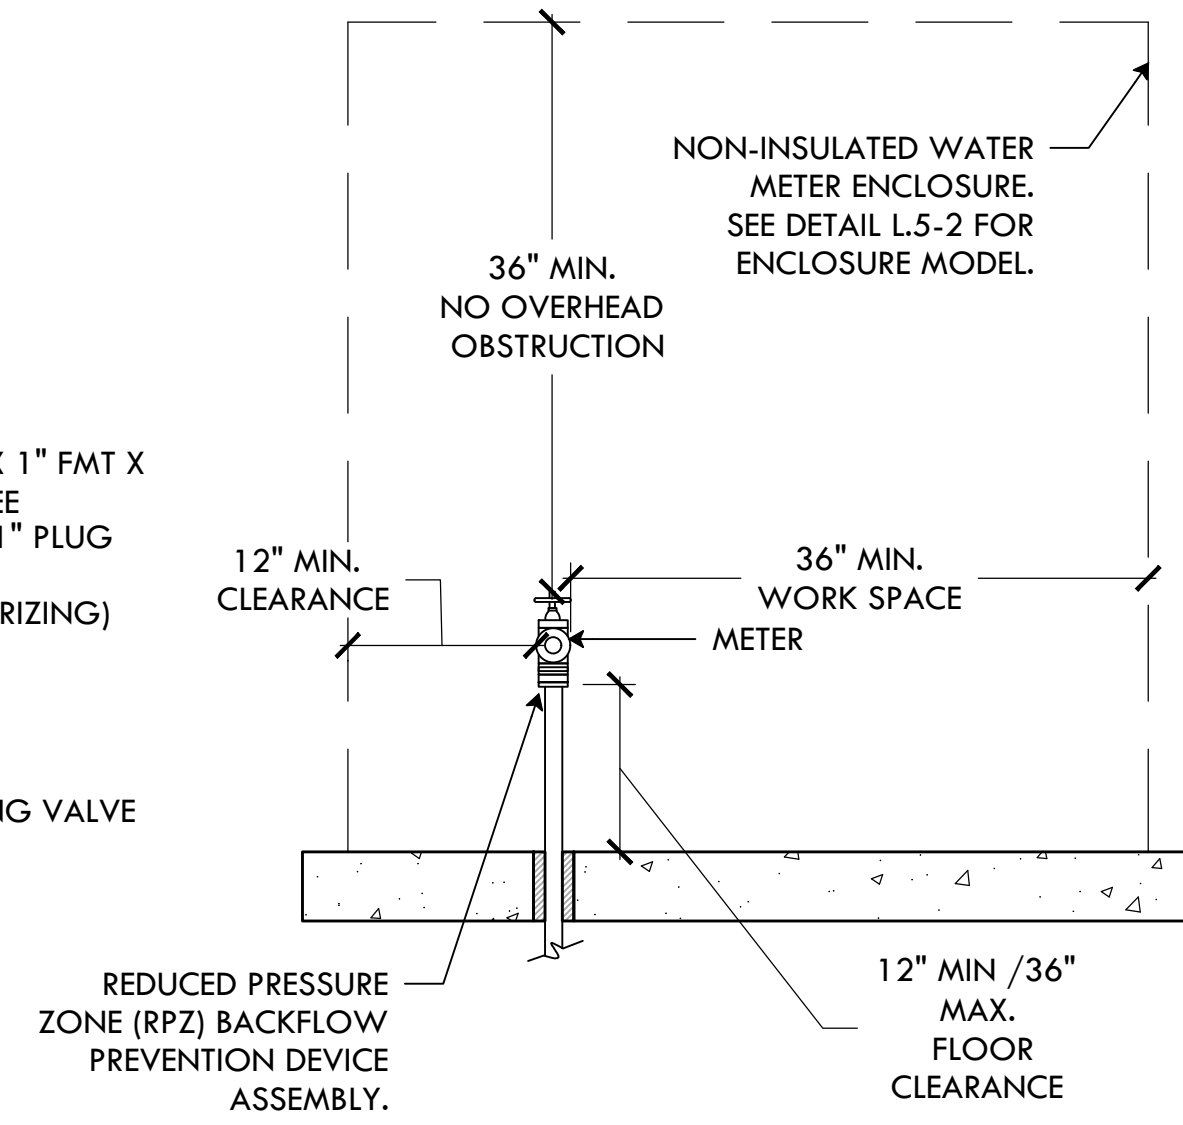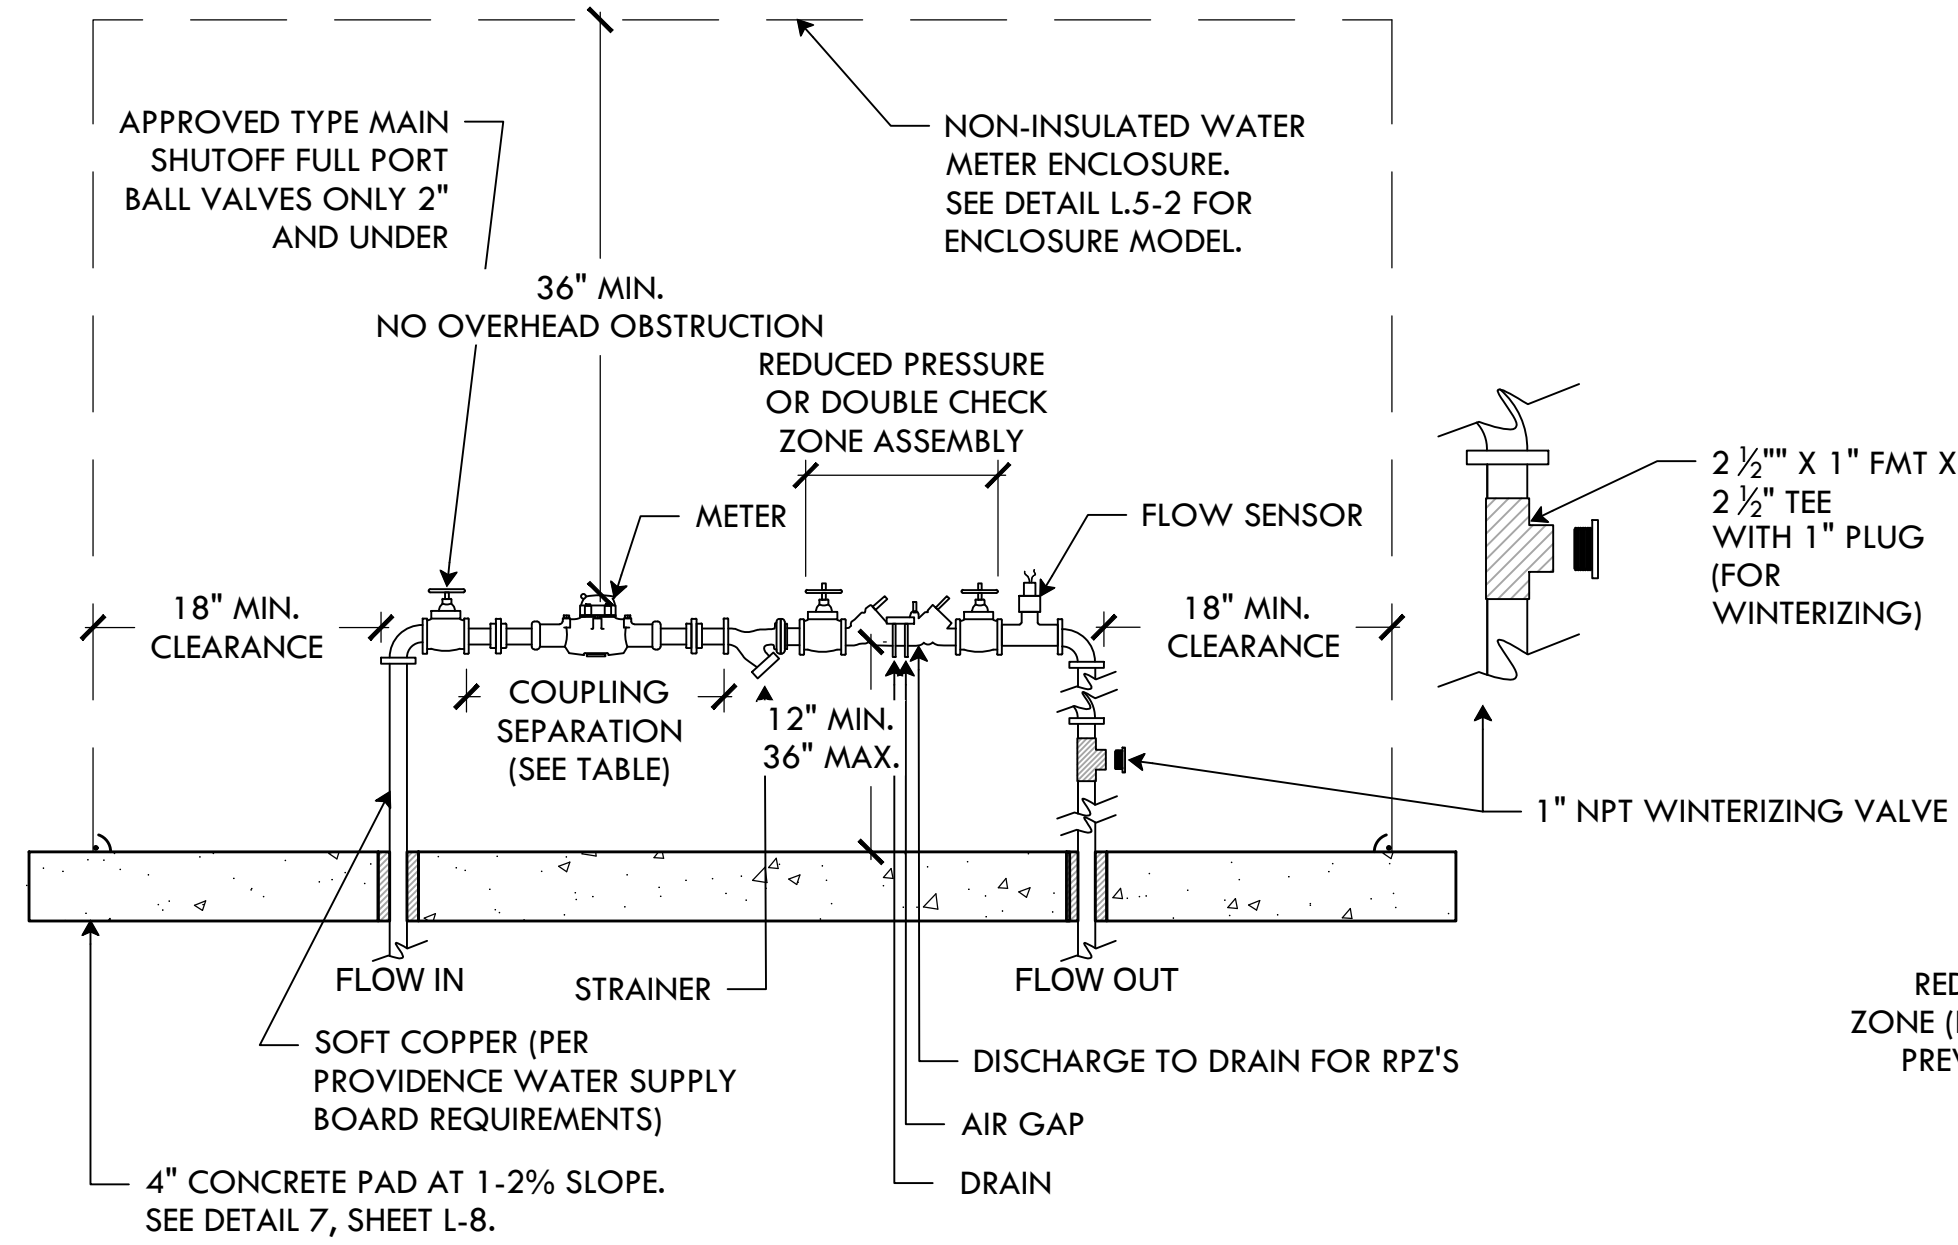


1 WATER METER
NTS


TOP VIEW

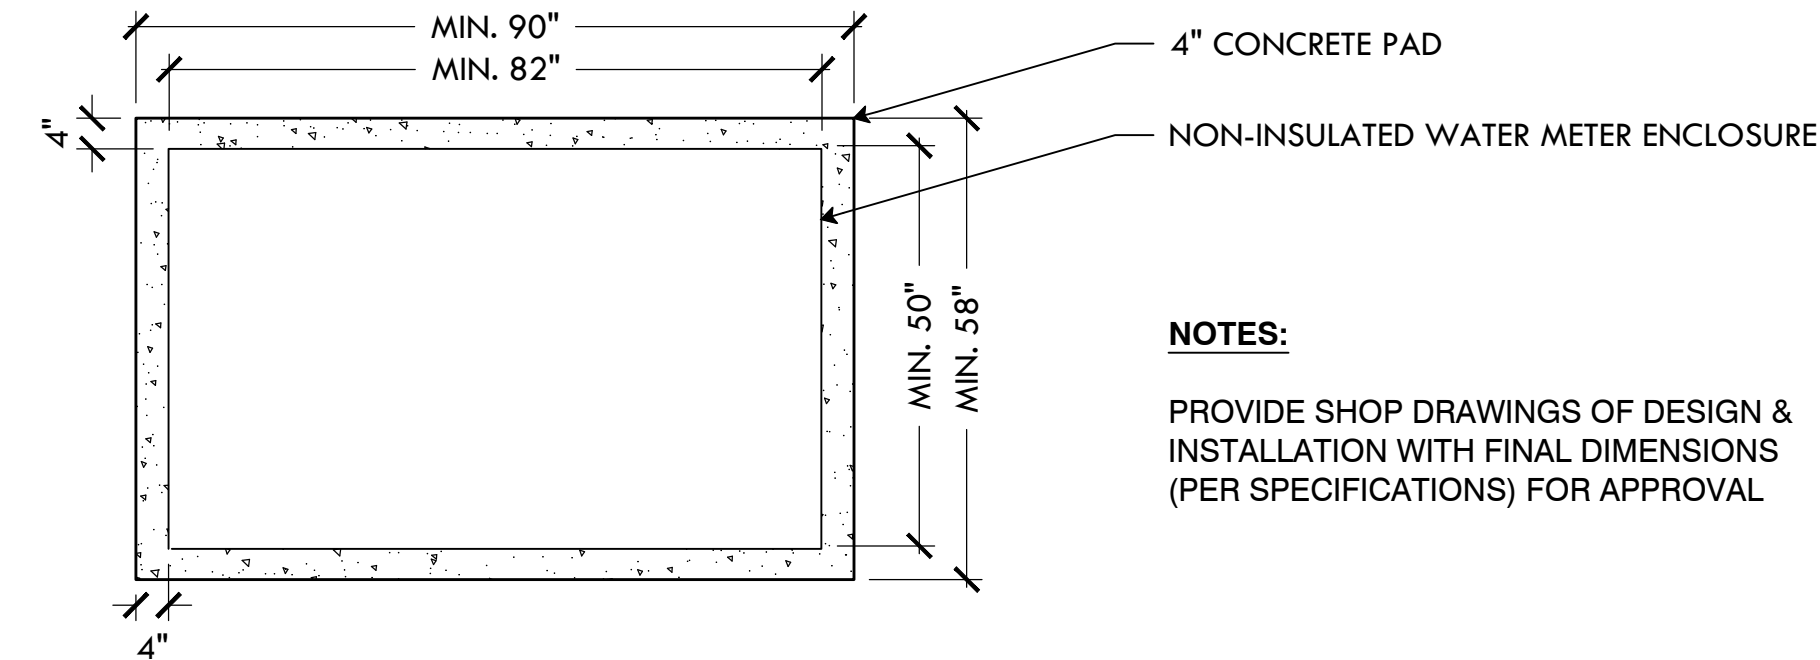

FRONT VIEW


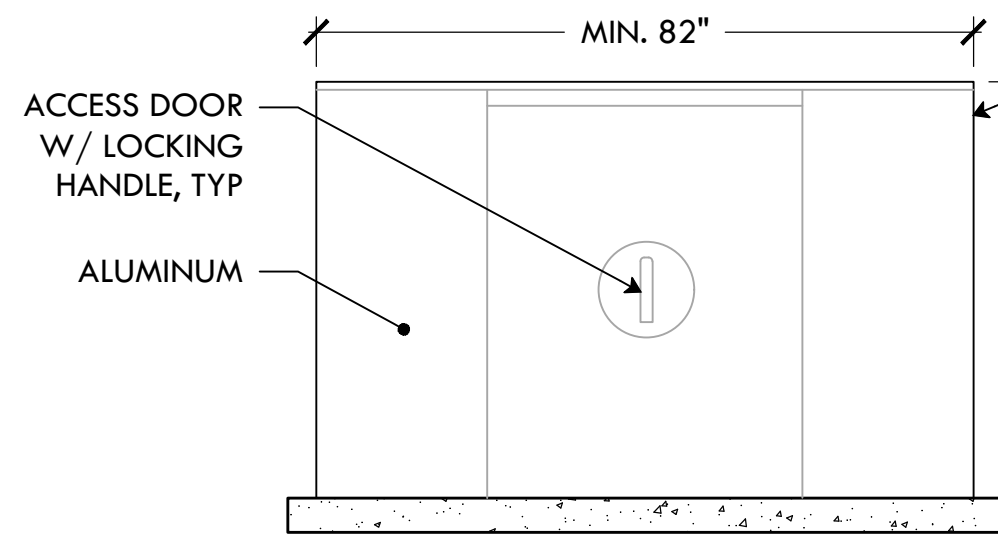


SIDE VIEW

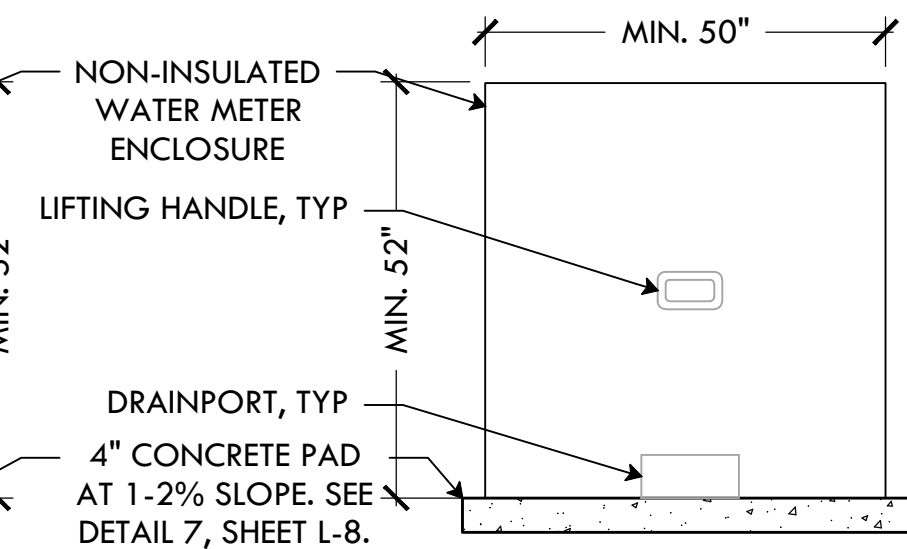

2 WATER METER ENCLOSURE
NTS

IRRIGATION LEGEND

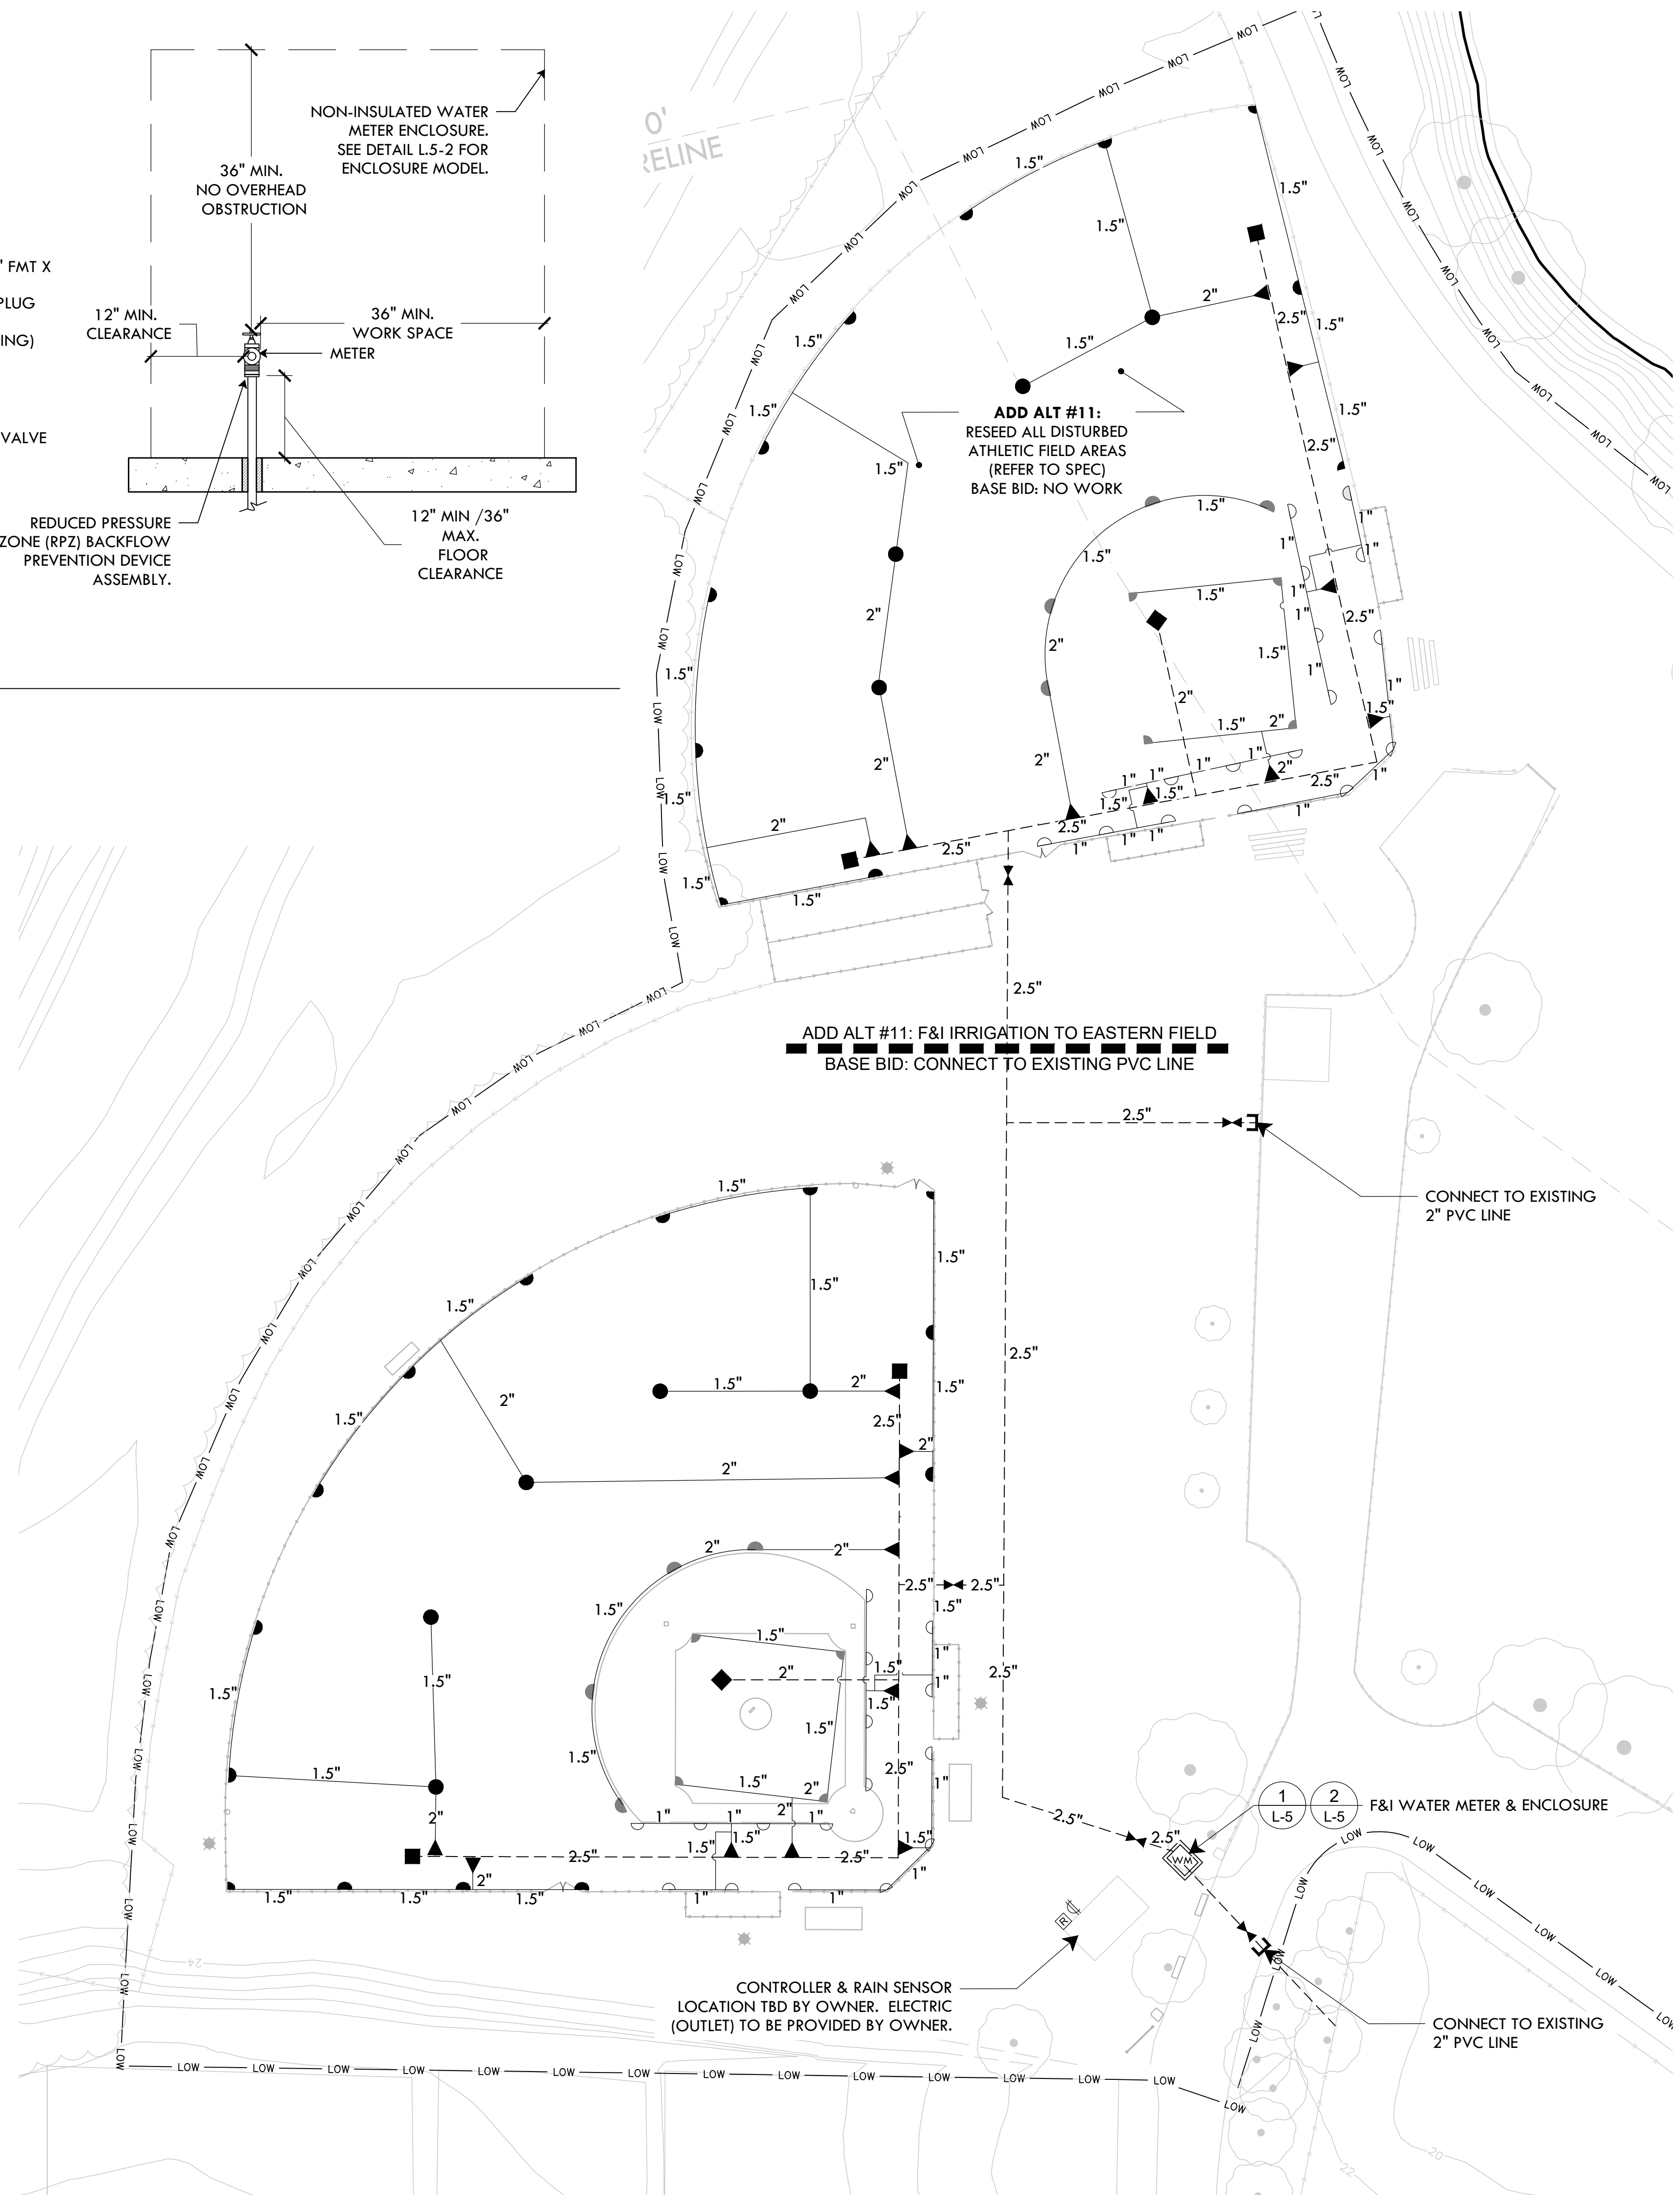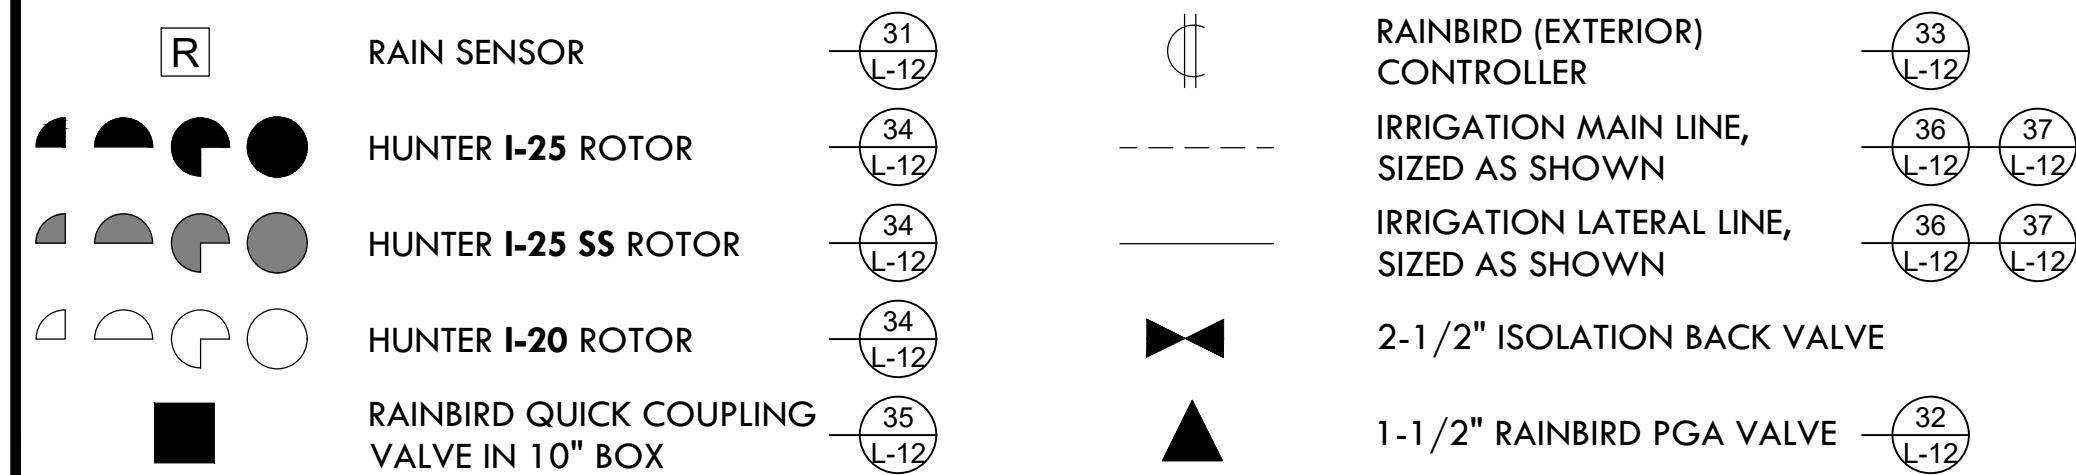

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DALRYMPLE BOATHOUSE
ROGER WILLIAMS PARK
PROVIDENCE, RI 02905





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PROJECT:
Re-Bid Site Improvements at Gano St Park
87 Fremont St
Providence, RI 02906

REVISIONS:
Date Issued For:



DRAWING INFO
DATE ISSUED: 01/16/25
PROJECT NO: GSPK.24.01
DRAWN BY: SH, II
CHECKED BY: MG
SHEET TITLE
Irrigation Plan

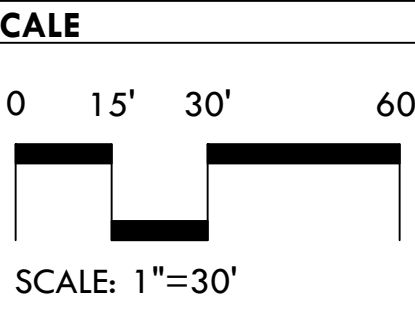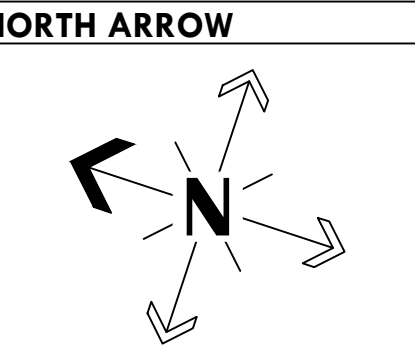

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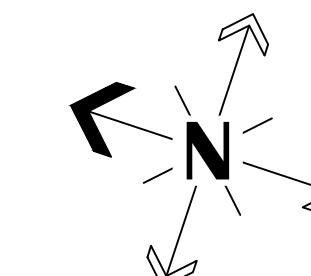
PROJECT:

Re-Bid Site Improvements at Gano St Park
87 Fremont St
Providence, RI 02906

REVISIONS:


Date Issued For:

NORTH ARROW



SCALE

0 10' 40' 80'

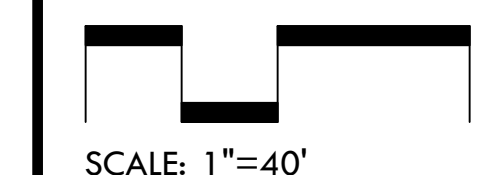


SCALE: 1"=40'

DRAWING INFO

DATE ISSUED: 01/16/25
PROJECT NO: GSPK.24.01
DRAWN BY: SH, II
CHECKED BY: MG

SHEET TITLE

Materials Plan

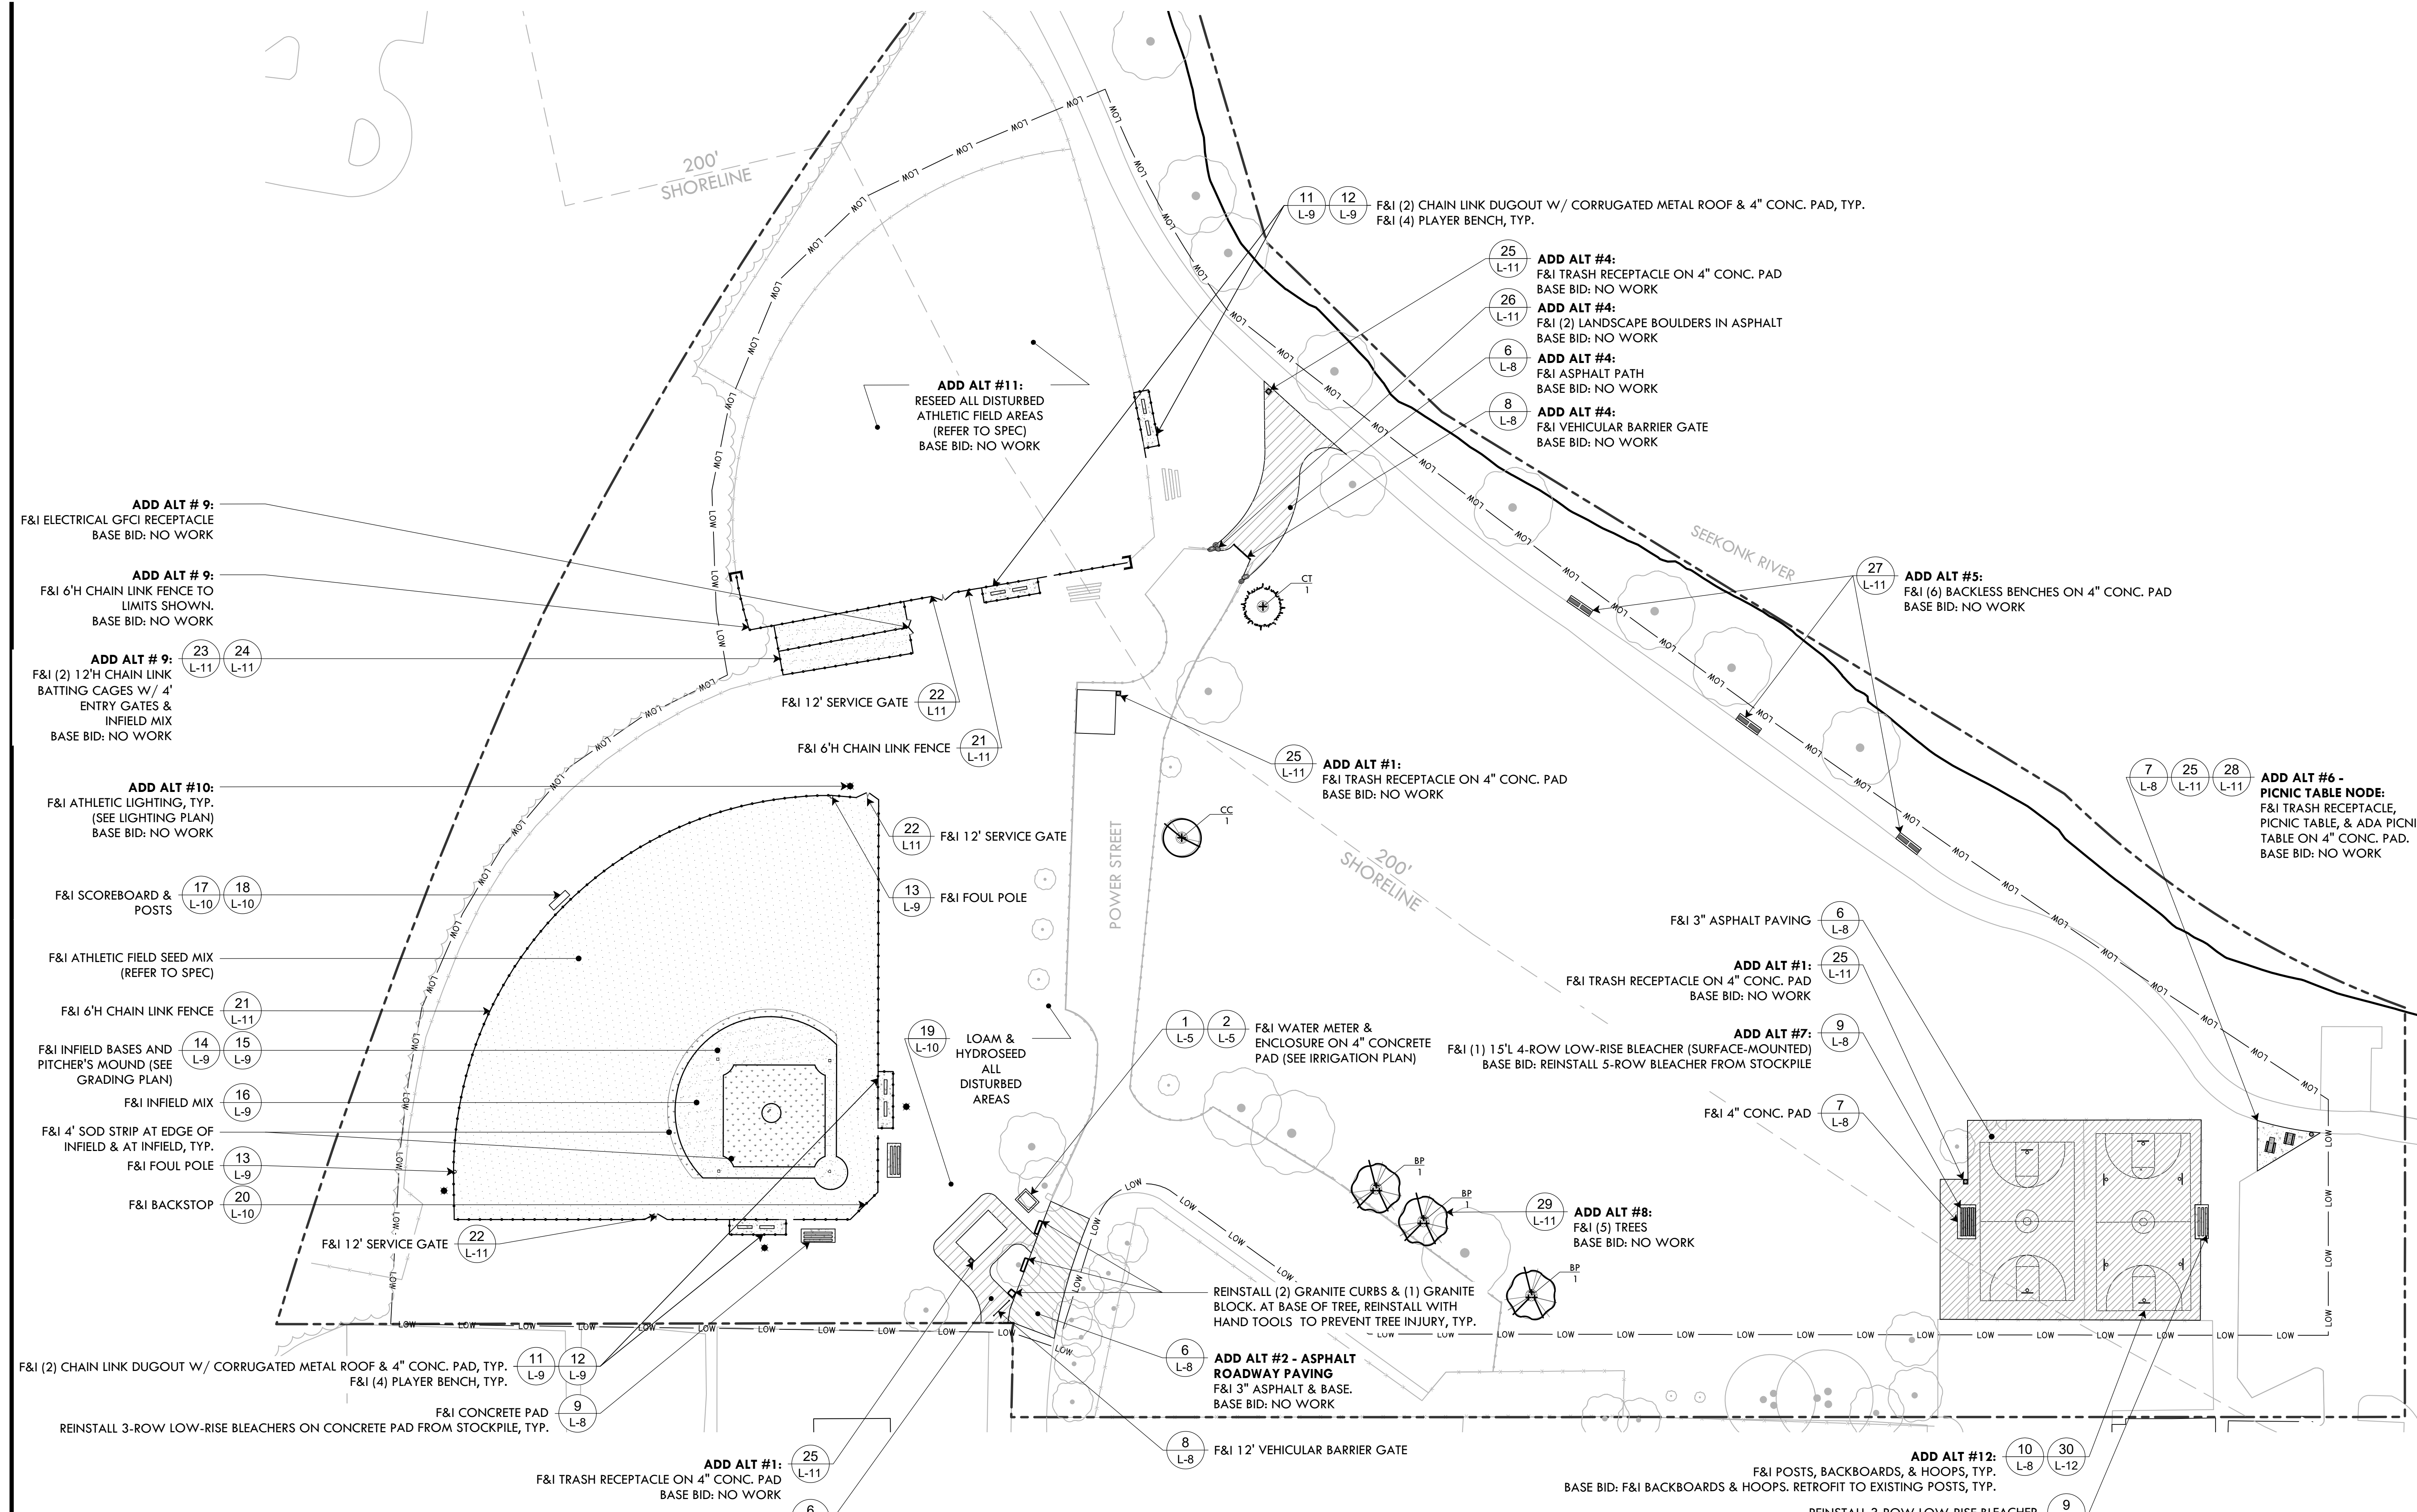

ADD ALT # 9:
F&I ELECTRICAL GFCI RECEPTACLE
BASE BID: NO WORK

ADD ALT # 9:
F&I 6'H CHAIN LINK FENCE TO LIMITS SHOWN.
BASE BID: NO WORK

ADD ALT # 9:
F&I (2) 12'H CHAIN LINK BATTING CAGES W/ 4' ENTRY GATES & INFIELD MIX
BASE BID: NO WORK

ADD ALT #10:
F&I ATHLETIC LIGHTING, TYP. (SEE LIGHTING PLAN)
BASE BID: NO WORK

F&I SCOREBOARD & POSTS (17, 18)

F&I ATHLETIC FIELD SEED MIX (REFER TO SPEC)

F&I 6'H CHAIN LINK FENCE (21)

F&I INFIELD BASES AND PITCHER'S MOUND (SEE GRADING PLAN) (14, 15)

F&I INFIELD MIX (16)

F&I 4' SOD STRIP AT EDGE OF INFIELD & AT INFIELD, TYP. (13)

F&I FOUL POLE (13)

F&I BACKSTOP (20)

F&I (2) CHAIN LINK DUGOUT W/ CORRUGATED METAL ROOF & 4" CONC. PAD, TYP. (11, 12)
F&I (4) PLAYER BENCH, TYP. (9)

F&I CONCRETE PAD (9)
REINSTALL 3-ROW LOW-RISE BLEACHERS ON CONCRETE PAD FROM STOCKPILE, TYP. (8)

ADD ALT #1:
F&I TRASH RECEPTACLE ON 4" CONC. PAD
BASE BID: NO WORK (25)

ADD ALT #3 - CONCESSION ASPHALT PAVING:
F&I 3" ASPHALT & BASE.
BASE BID: LOAM & HYDROSEED (6)

ADD ALT #11:
RESEED ALL DISTURBED ATHLETIC FIELD AREAS (REFER TO SPEC)
BASE BID: NO WORK

(11, 12) F&I (2) CHAIN LINK DUGOUT W/ CORRUGATED METAL ROOF & 4" CONC. PAD, TYP.
F&I (4) PLAYER BENCH, TYP.

ADD ALT #4:
F&I TRASH RECEPTACLE ON 4" CONC. PAD
BASE BID: NO WORK (25)

ADD ALT #4:
F&I (2) LANDSCAPE BOULDERS IN ASPHALT
BASE BID: NO WORK (26)

ADD ALT #4:
F&I ASPHALT PATH
BASE BID: NO WORK (6)

ADD ALT #4:
F&I VEHICULAR BARRIER GATE
BASE BID: NO WORK (8)

ADD ALT #5:
F&I (6) BACKLESS BENCHES ON 4" CONC. PAD
BASE BID: NO WORK (27)

ADD ALT #6 - PICNIC TABLE NODE:
F&I TRASH RECEPTACLE, PICNIC TABLE, & ADA PICNIC TABLE ON 4" CONC. PAD.
BASE BID: NO WORK (7, 25, 28)

ADD ALT #1:
F&I TRASH RECEPTACLE ON 4" CONC. PAD
BASE BID: NO WORK (25)

F&I WATER METER & ENCLOSURE ON 4" CONCRETE PAD (SEE IRRIGATION PLAN) (1, 2)

F&I (1) 15'L 4-ROW LOW-RISE BLEACHER (SURFACE-MOUNTED)
BASE BID: REINSTALL 5-ROW BLEACHER FROM STOCKPILE (9)

F&I 3" ASPHALT PAVING (6)

ADD ALT #1:
F&I TRASH RECEPTACLE ON 4" CONC. PAD
BASE BID: NO WORK (25)

F&I 4" CONC. PAD (7)

F&I 4" CONC. PAD (7)

ADD ALT #8:
F&I (5) TREES
BASE BID: NO WORK (29)

REINSTALL (2) GRANITE CURBS & (1) GRANITE BLOCK. AT BASE OF TREE, REINSTALL WITH HAND TOOLS TO PREVENT TREE INJURY, TYP.

ADD ALT #2 - ASPHALT ROADWAY PAVING:
F&I 3" ASPHALT & BASE.
BASE BID: NO WORK (6)

F&I 12' VEHICULAR BARRIER GATE (8)

ADD ALT #12:
F&I POSTS, BACKBOARDS, & HOOPS, TYP.
BASE BID: F&I BACKBOARDS & HOOPS. RETROFIT TO EXISTING POSTS, TYP. (10, 30)




REINSTALL 3-ROW LOW-RISE BLEACHER FROM STOCKPILE ON 4" CONC. PAD (9)

MATERIALS LEGEND

	4" POURED CONCRETE PAD		ATHLETIC FIELD SEED MIX
	3" ASPHALT PAVING		4" CLAY INFIELD MIX
	LOAM & HYDROSEED ALL DISTURBED AREAS		SOD
F&I	FURNISH & INSTALL	*	ATHLETIC LIGHTING (REFER TO ENGINEERING PLAN)

ADD ALT #8: PLANTING LEGEND & TREE SCHEDULE


KEY	QTY	BOTANICAL NAME Common Name	SIZE	NOTES
BN	3	<i>Betula populifolia</i> 'Whitespire' Grey Birch	12-14'	CLUMP
CC	1	<i>Carpinus caroliniana</i> American Hornbeam	2.5-3" Cal	2.5" MIN.
CT	1	<i>Chamaecyparis thyoides</i> Atlantic White Cedar	10-12' H	

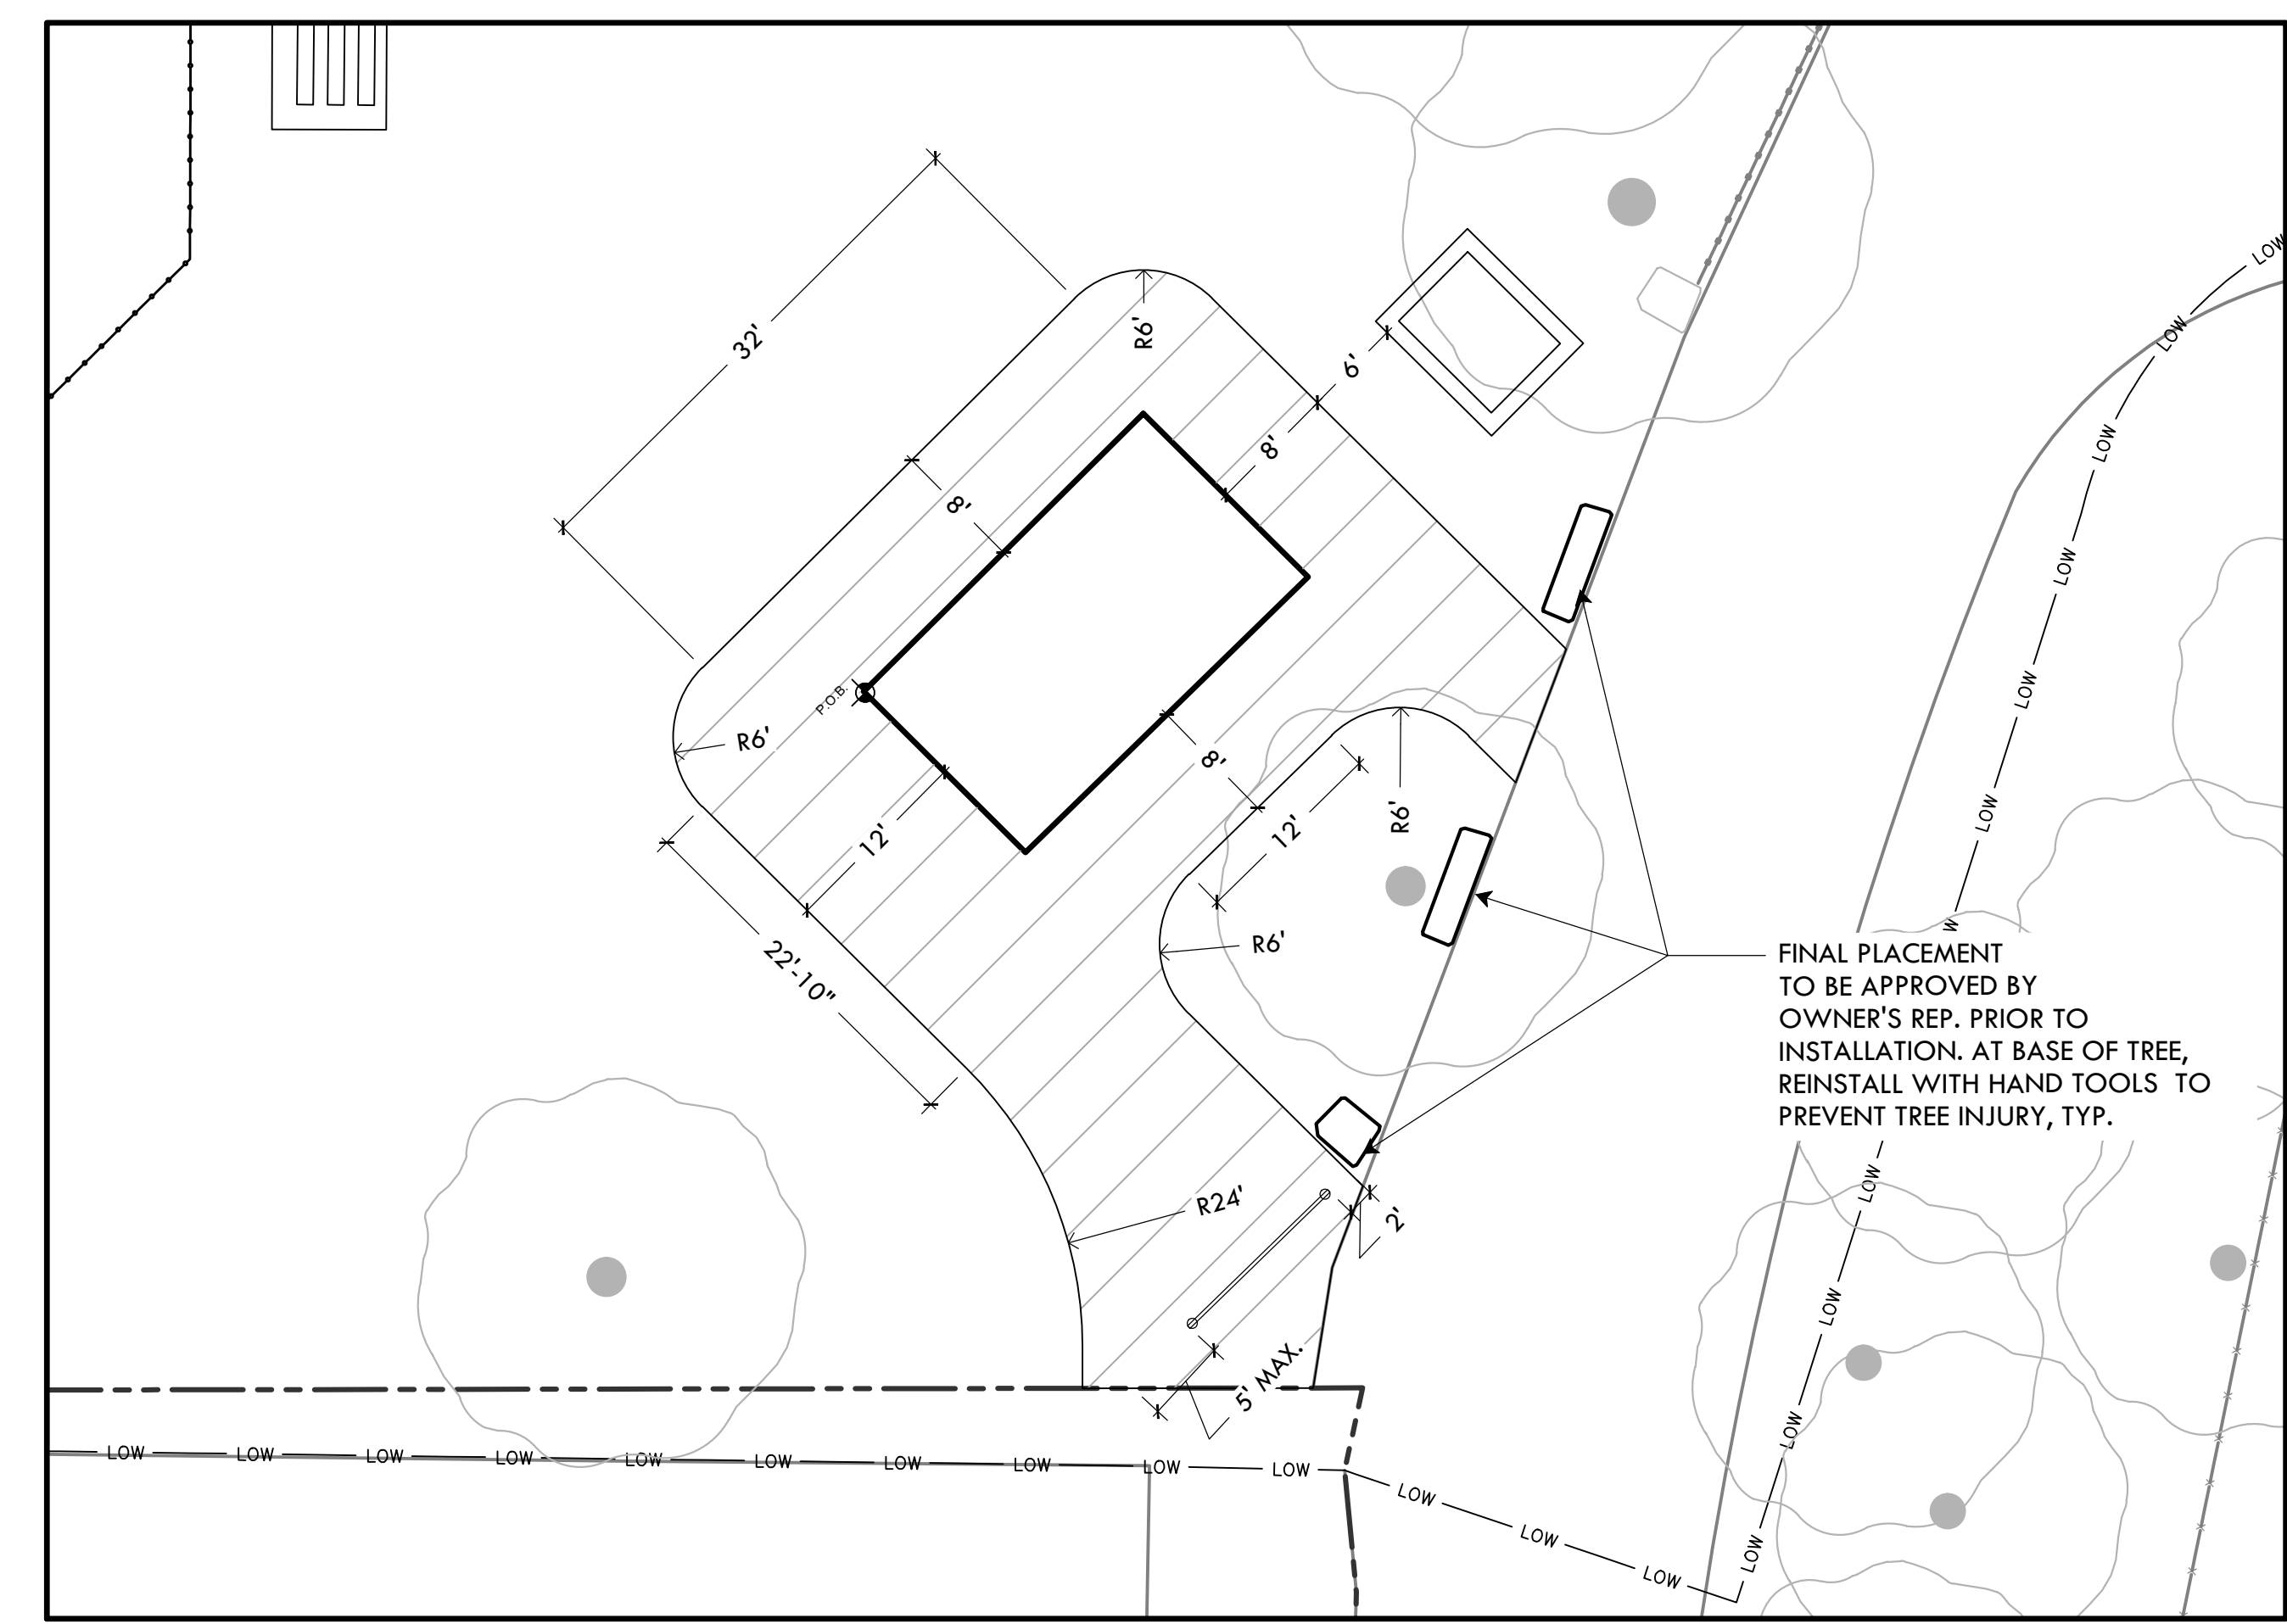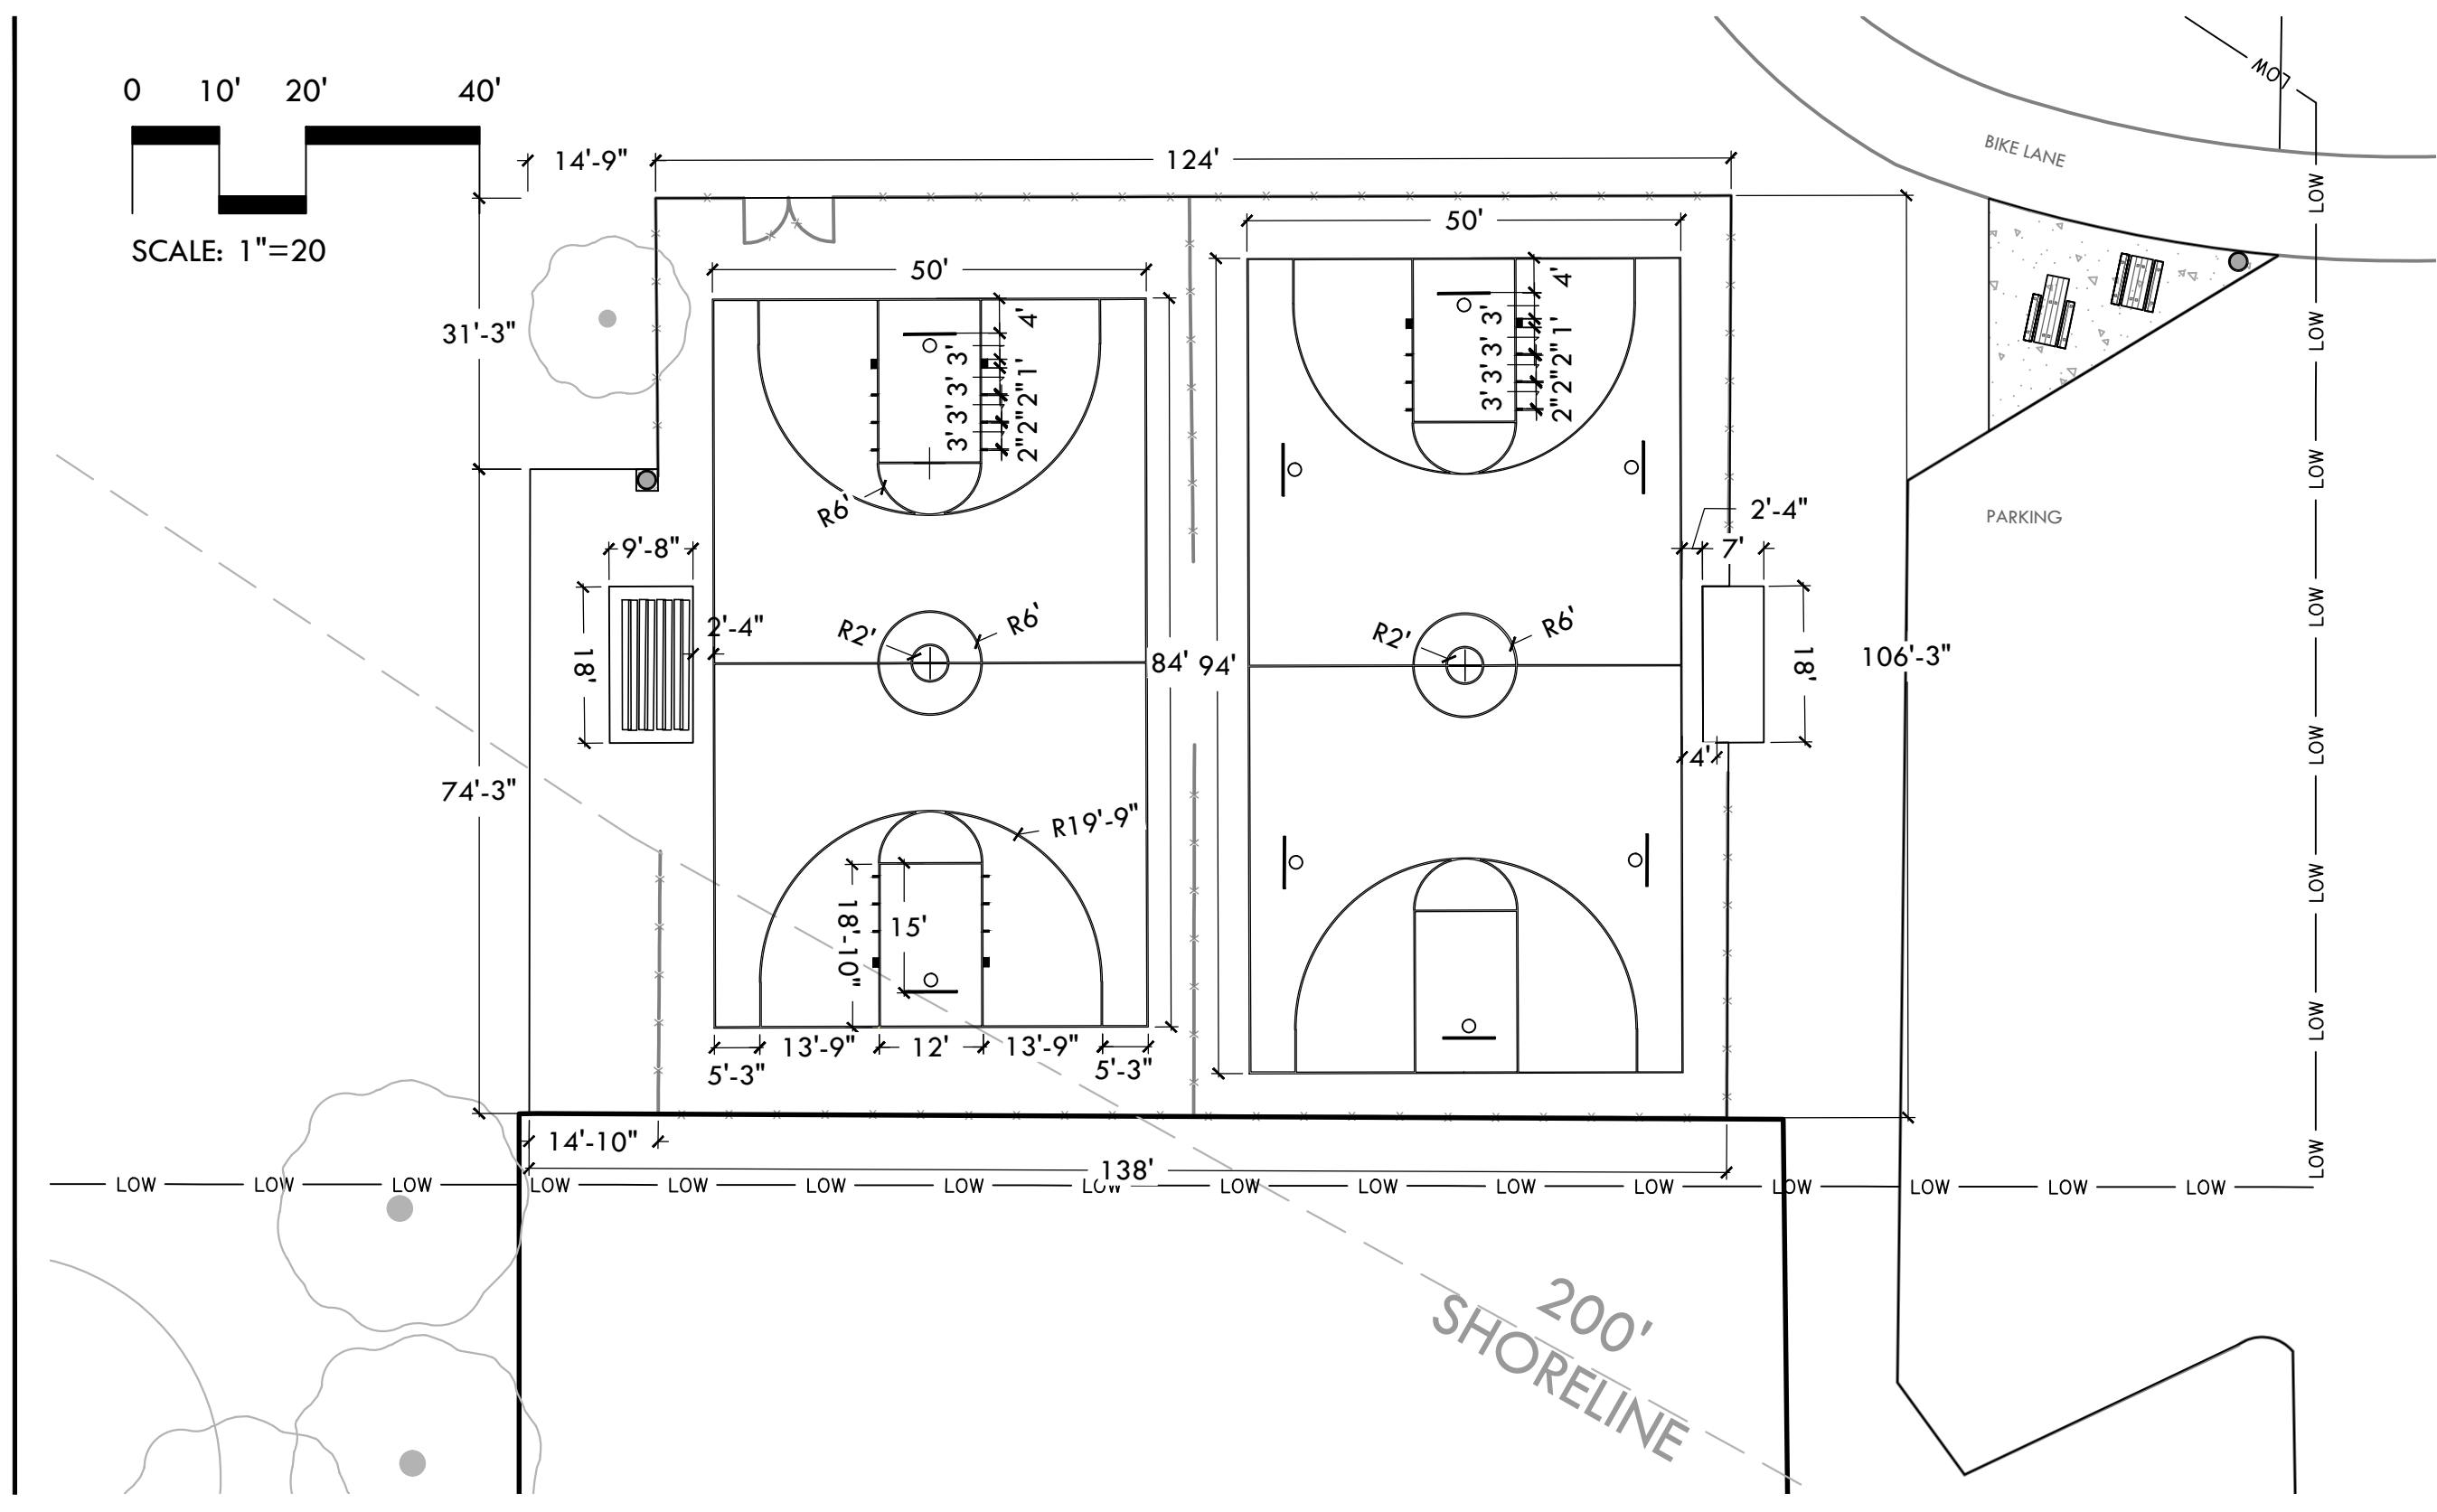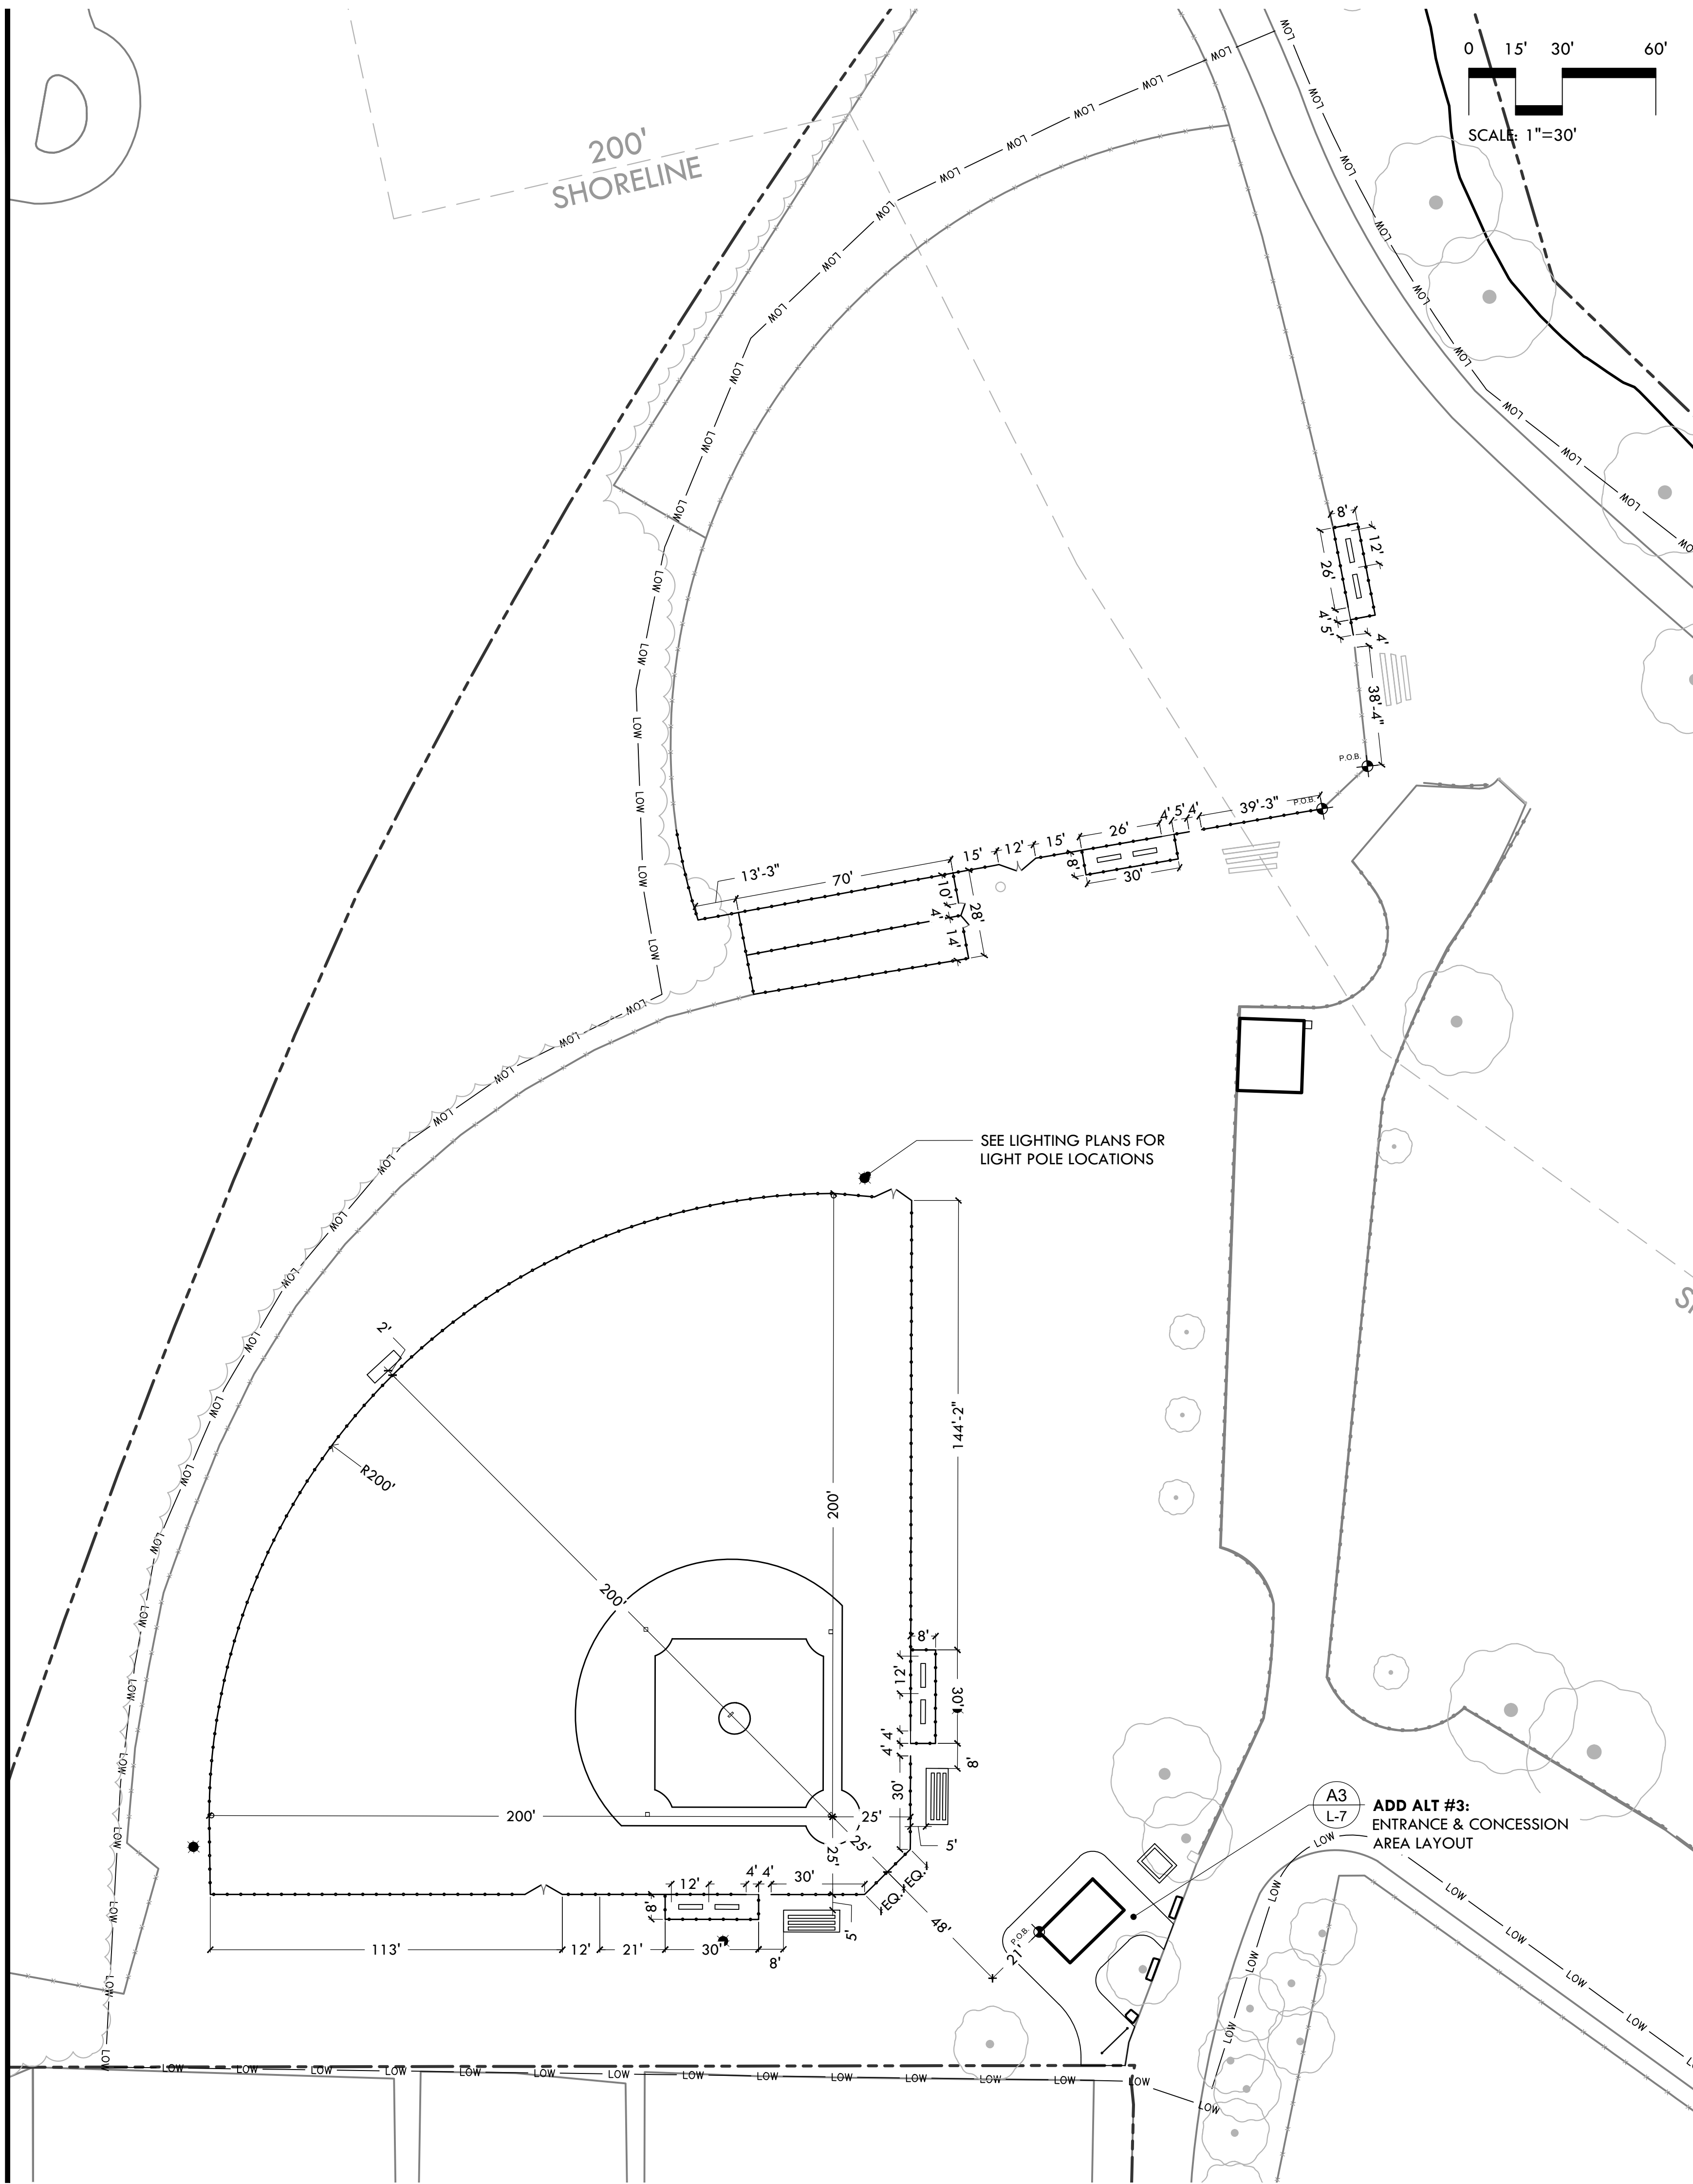

A3 ADD ALT #3: ENTRANCE & CONCESSION AREA LAYOUT
SCALE: 1"=10'

LAYOUT LEGEND

- POINT OF BEGINNING
- CENTERLINE
- DIMENSION

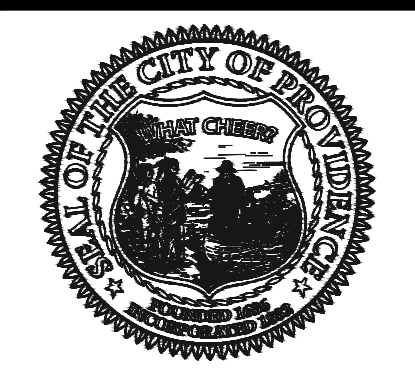

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DALRYMPLE BOATHOUSE
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PROVIDENCE, RI 02905




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87 Fremont St
Providence, RI 02906

REVISIONS:
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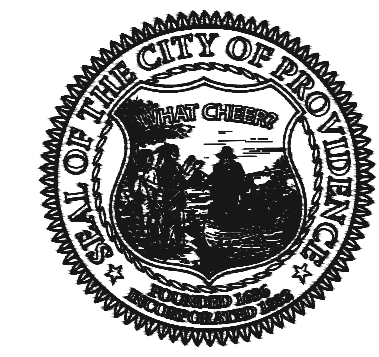


SCALE

DRAWING INFO
DATE ISSUED: 01/16/25
PROJECT NO: GSPK.24.01
DRAWN BY: SH, II
CHECKED BY: MG

SHEET TITLE
Layout Plan

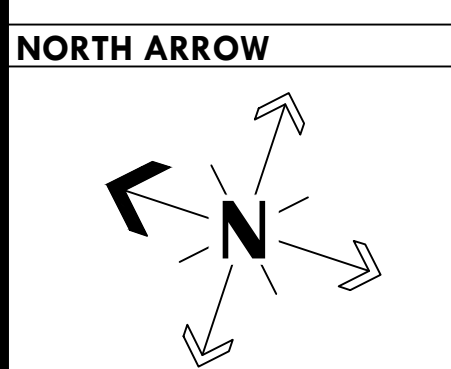L-7



STAMP

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Re-Bid Site Improvements at Gano St Park
87 Fremont St
Providence, RI 02906

REVISIONS:
Date Issued For:

NORTH ARROW


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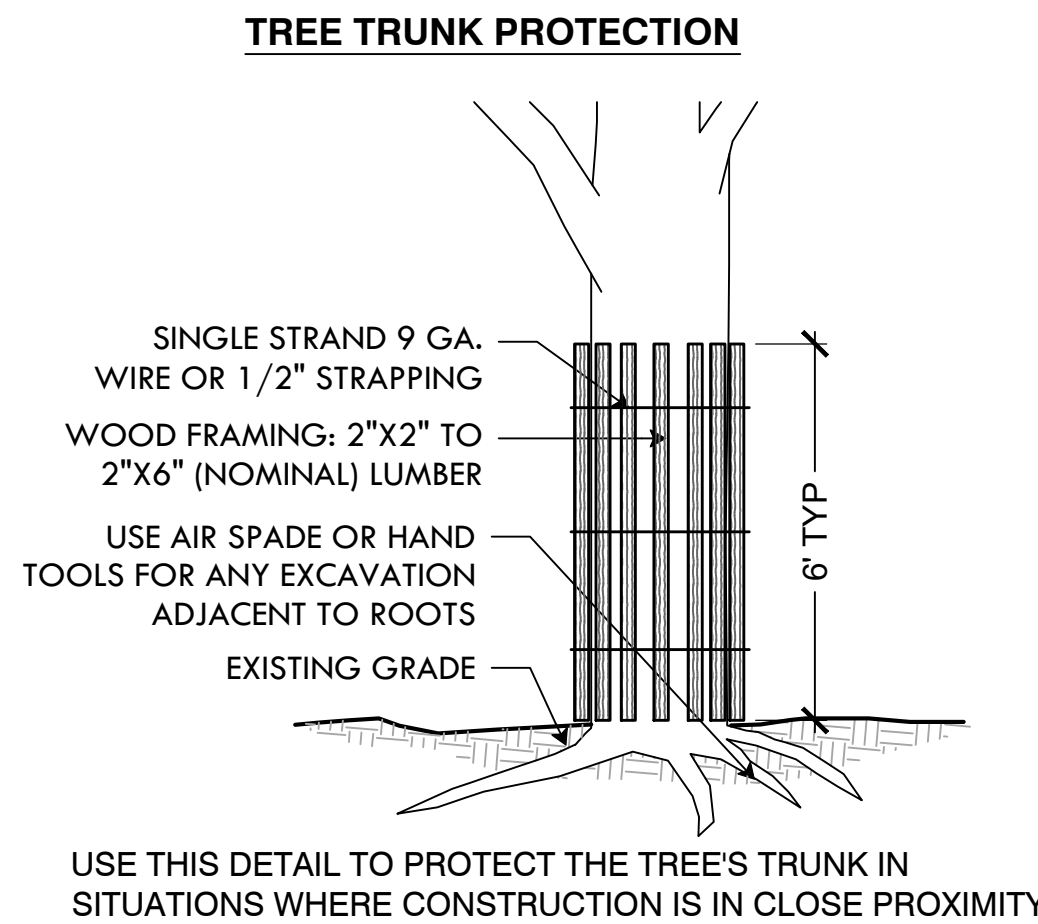
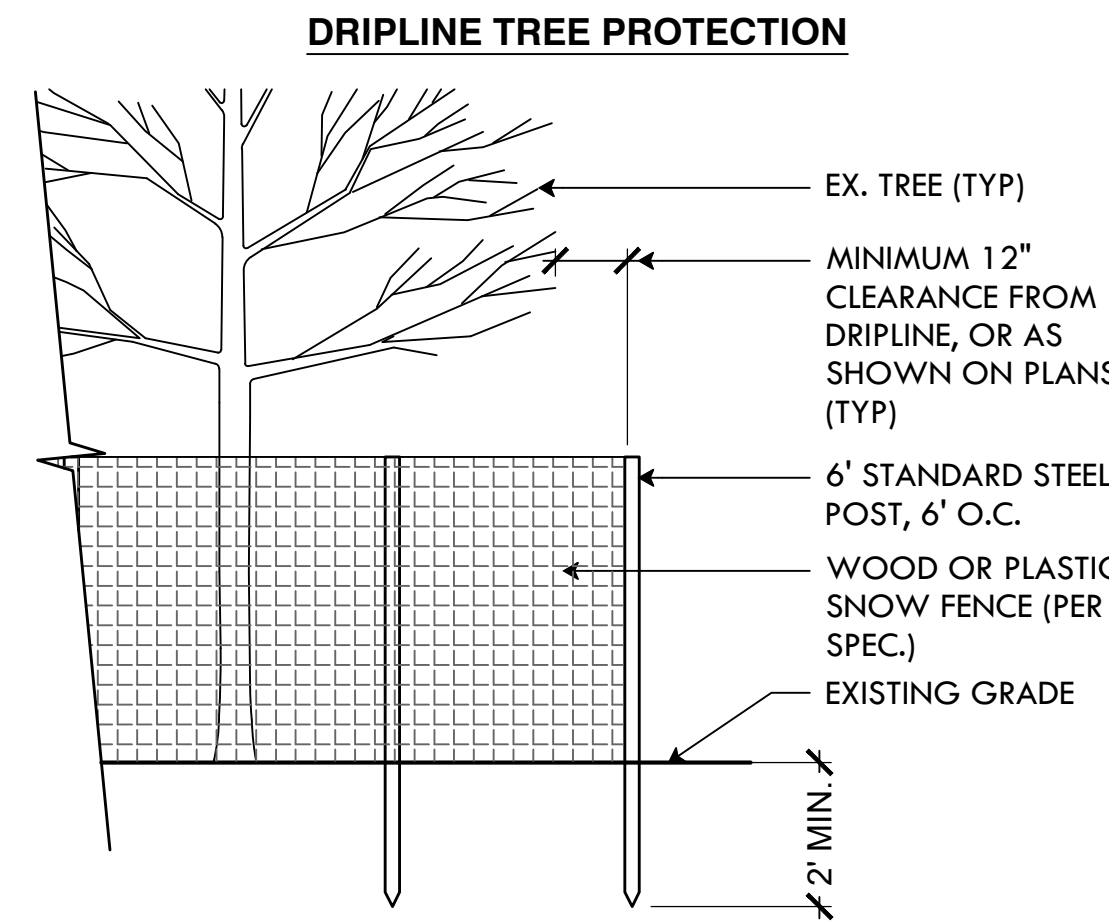
SHEET TITLE

Construction Details 1





- NOTES:
- DISTURBED AREAS SHALL NOT EXTEND BEYOND THE SAWCUT.
 - CLEAN SAWED JOINTS WITH COMPRESSED AIR
 - APPLY JOINT SEAL MATERIAL FILLING FROM THE BOTTOM UP
 - THE HOT-SEAL MATERIAL SHALL COMPLETELY FILL THE SAWCUT SUCH THAT AFTER COOLING THE LEVEL OF THE SEALER WILL NOT BE GREATER 1/8" BELOW THE PAVEMENT SURFACE
 - CARE SHALL BE TAKEN DURING SEALING TO INSURE THAT THE FINAL APPEARANCE WILL PRESENT A NEAT LINE

5 ASPHALT SAW CUT
NTS

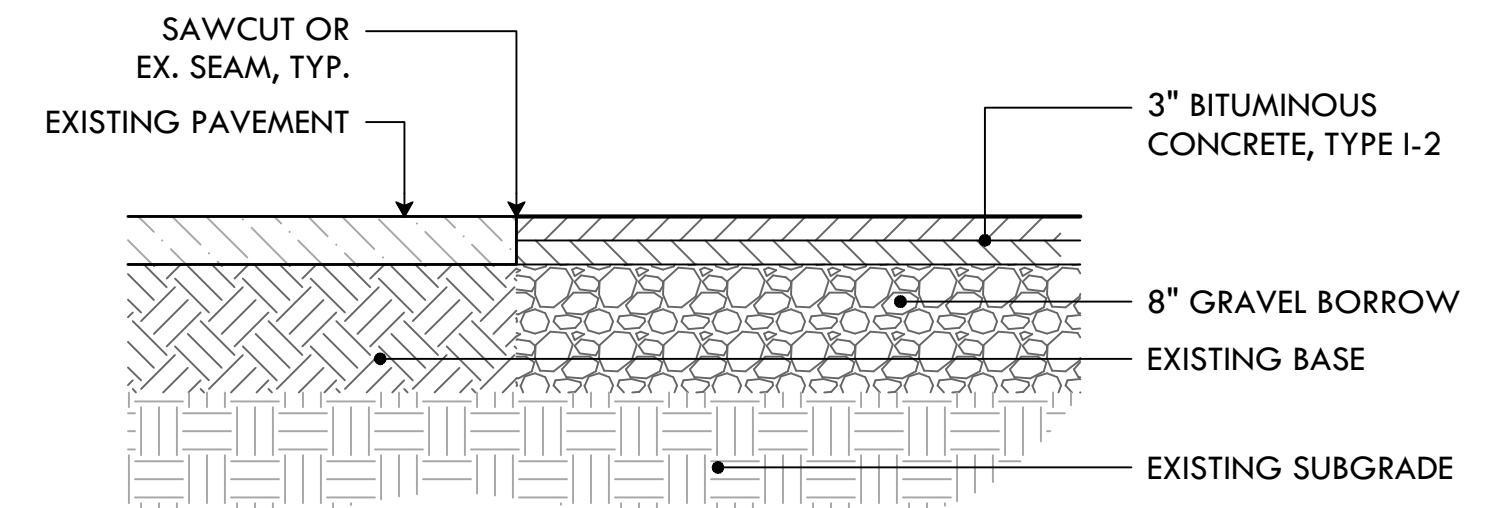


4 TREE PROTECTION DEVICES
NTS

USE THIS DETAIL TO PROTECT THE TREE'S TRUNK IN SITUATIONS WHERE CONSTRUCTION IS IN CLOSE PROXIMITY

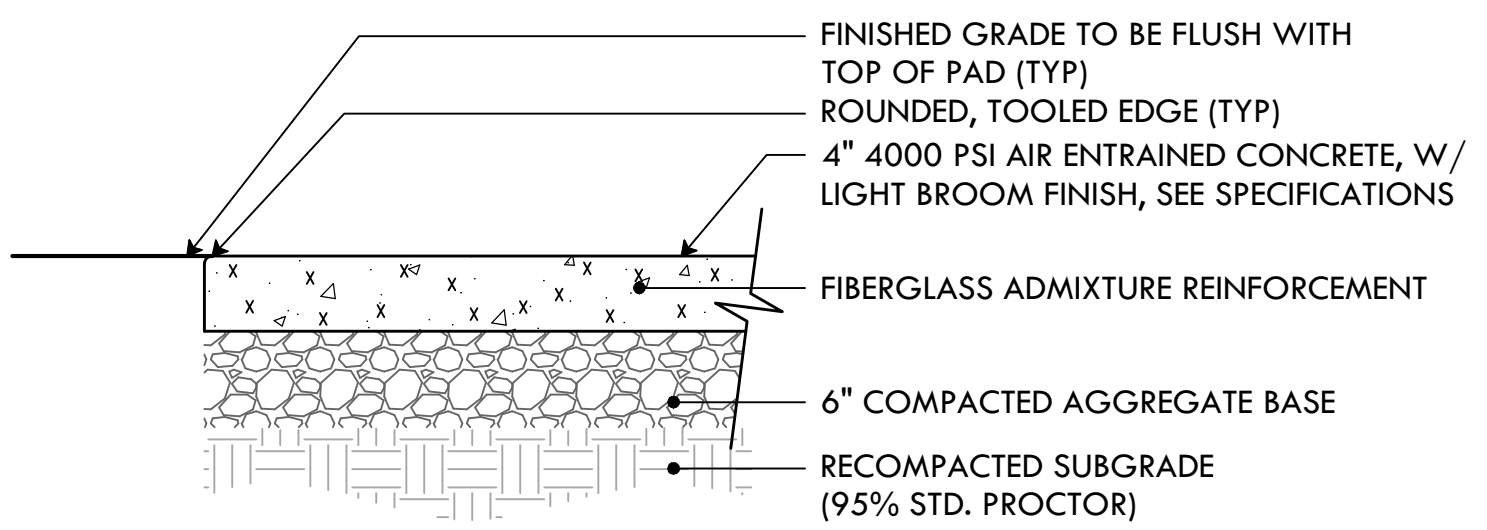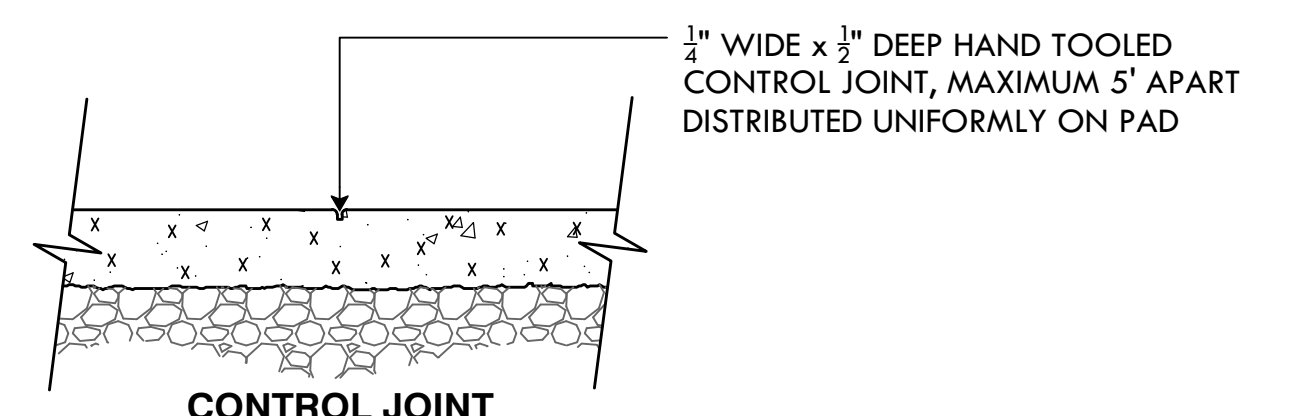

7 4" CONCRETE PAD
NTS


8 12' VEHICULAR BARRIER GATE
NTS

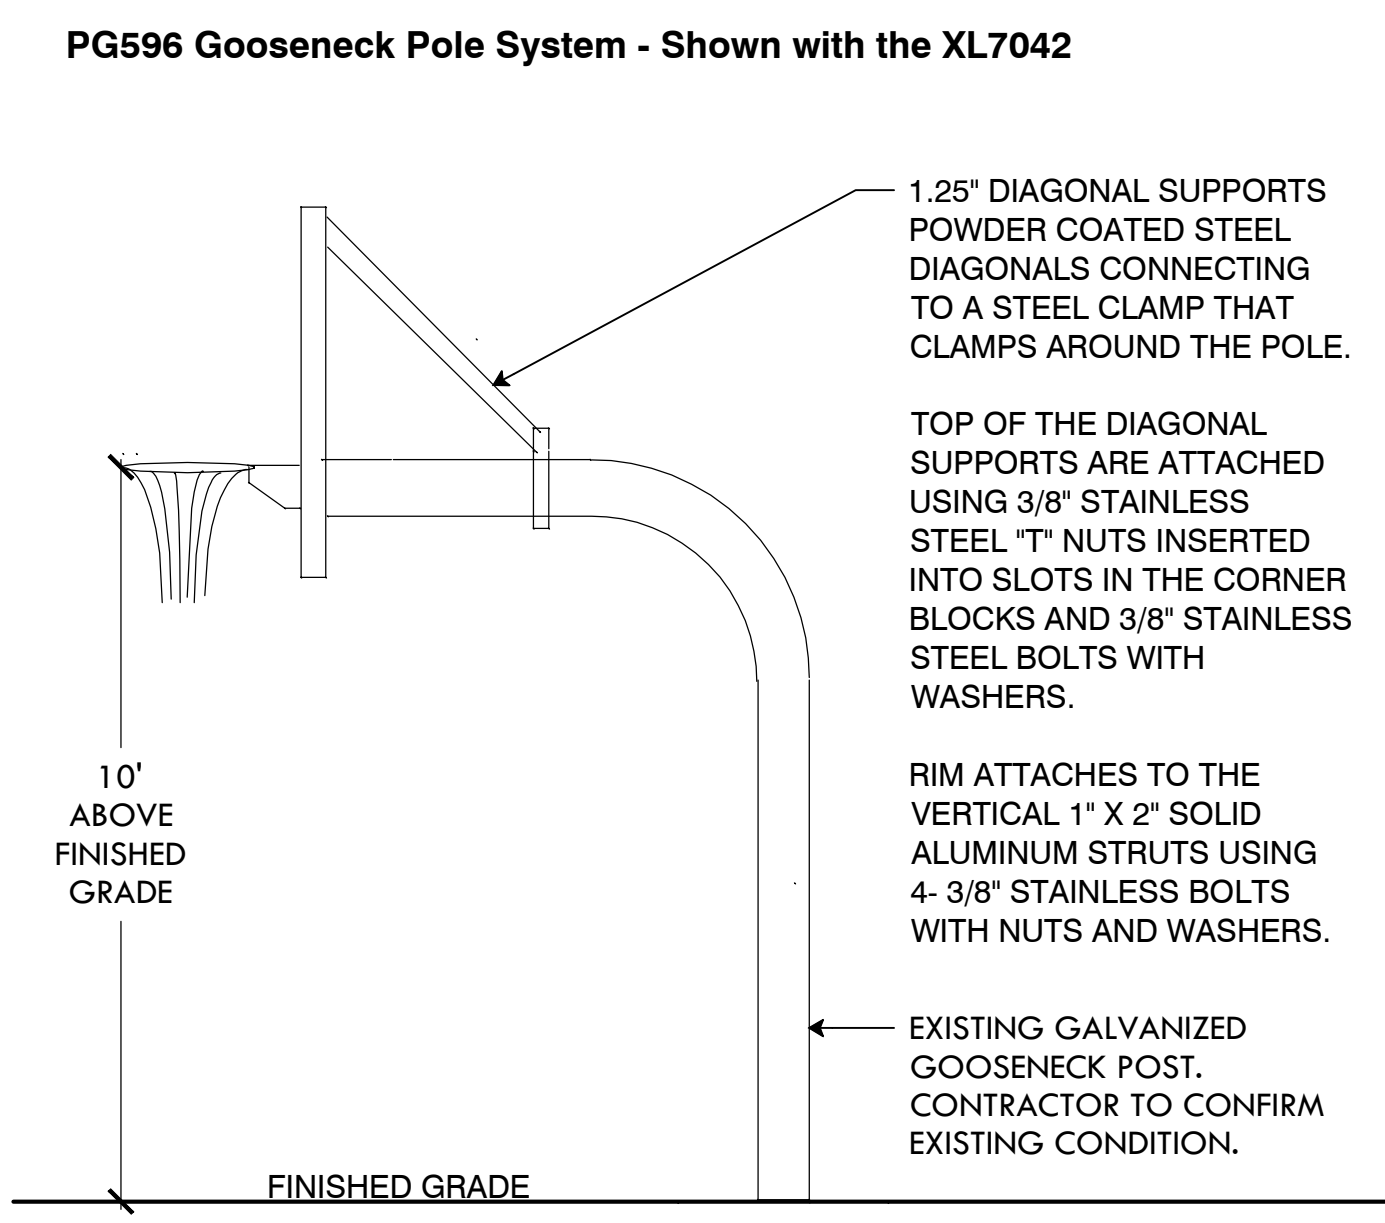


PG596 Gooseneck Pole System - Shown with the XL7042

- NOTES:
- XL7048, XL7043 AND XL7036 ATTACHED TO THE POLE USING 4 3/8" STAINLESS STEEL BOLTS; 2 THROUGH EACH 1" X 2" SOLID ALUMINUM UPRIGHT SUPPORTS (KT000) AT A HEIGHT WHICH PUTS THE RIM AT 10'.
 - TOP OF THE DIAGONAL SUPPORTS ARE ATTACHED USING 3/8" STAINLESS STEEL "T" NUTS INSERTED INTO SLOTS IN THE CORNER BLOCKS AND 3/8" STAINLESS STEEL BOLTS WITH WASHERS.
 - RIM ATTACHES TO THE VERTICAL 1" X 2" SOLID ALUMINUM STRUTS USING 4- 3/8" STAINLESS BOLTS WITH NUTS AND WASHERS.
 - EXISTING GALVANIZED GOOSENECK POST. CONTRACTOR TO CONFIRM EXISTING CONDITION.


10 TRUEBOUNCE BASKETBALL BACKBOARD & RIM
NTS

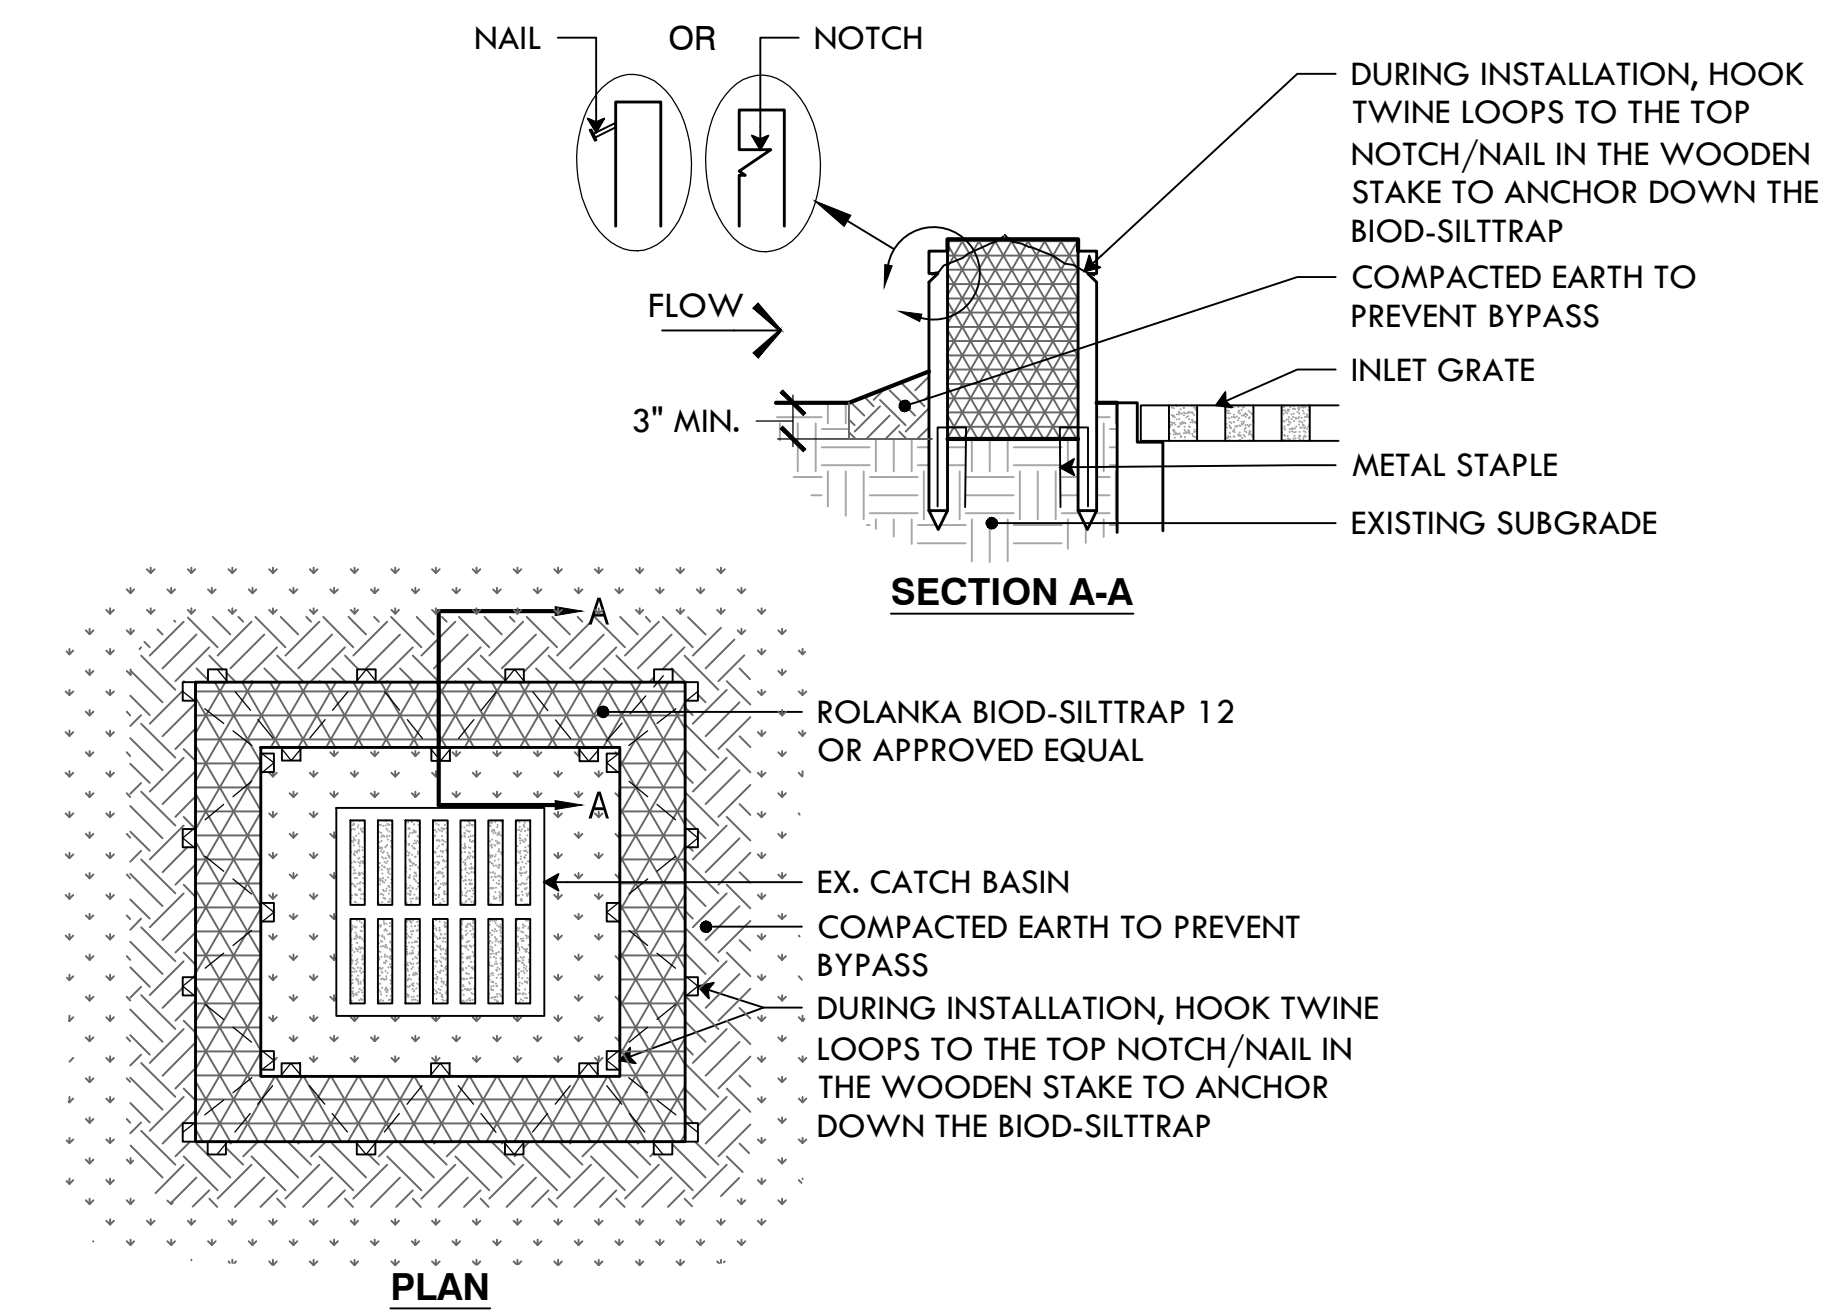


3 SILT SOCK/COMPOST FILTER SOCK EROSION CONTROL
NTS

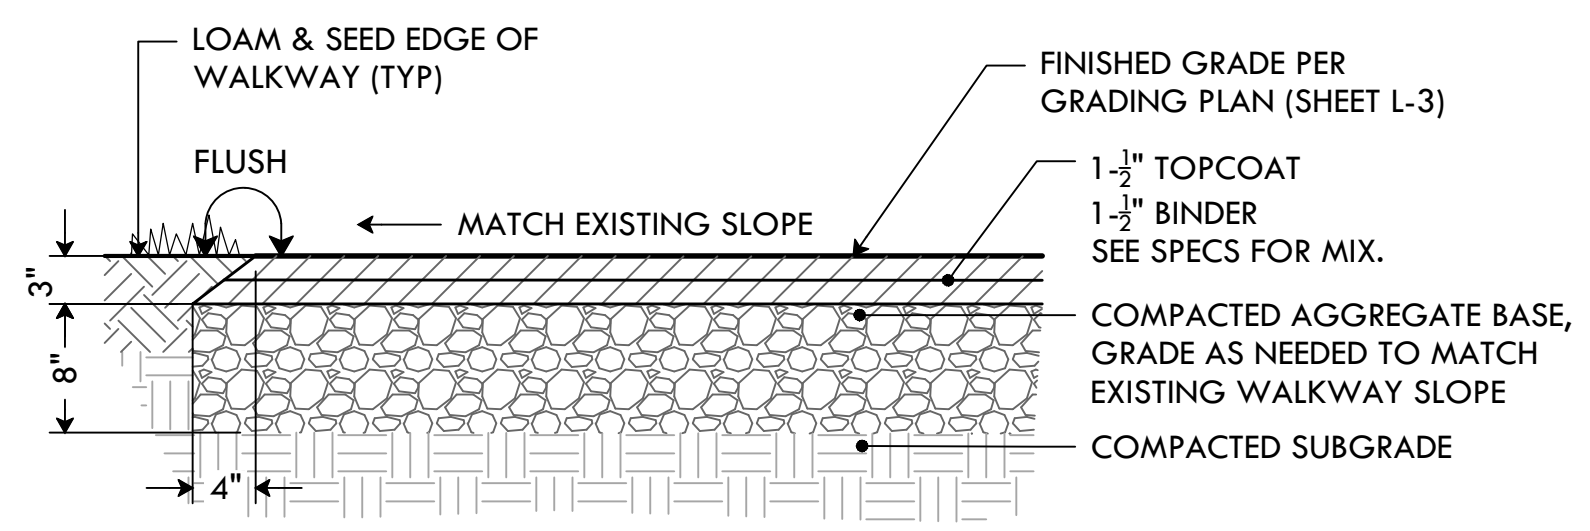


6 3" ASPHALT PAVEMENT
NTS

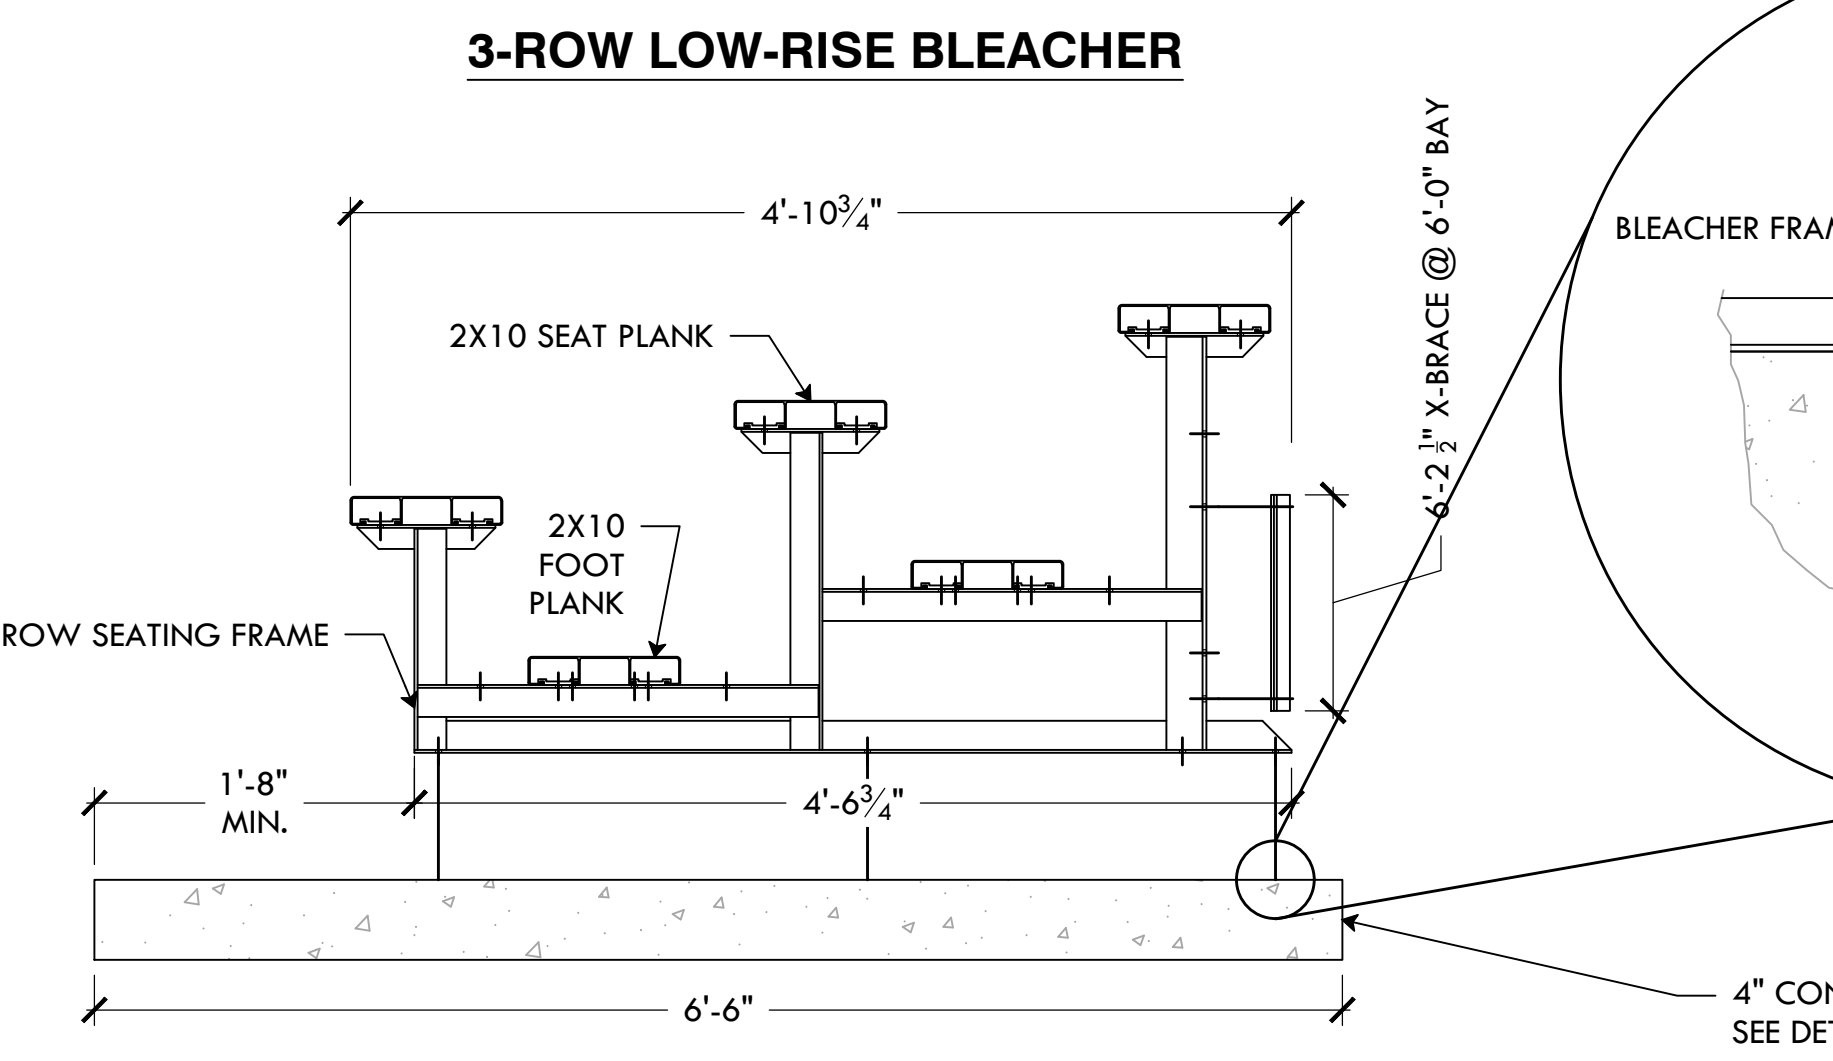


9 15'L LOW-RISE BLEACHER
NTS

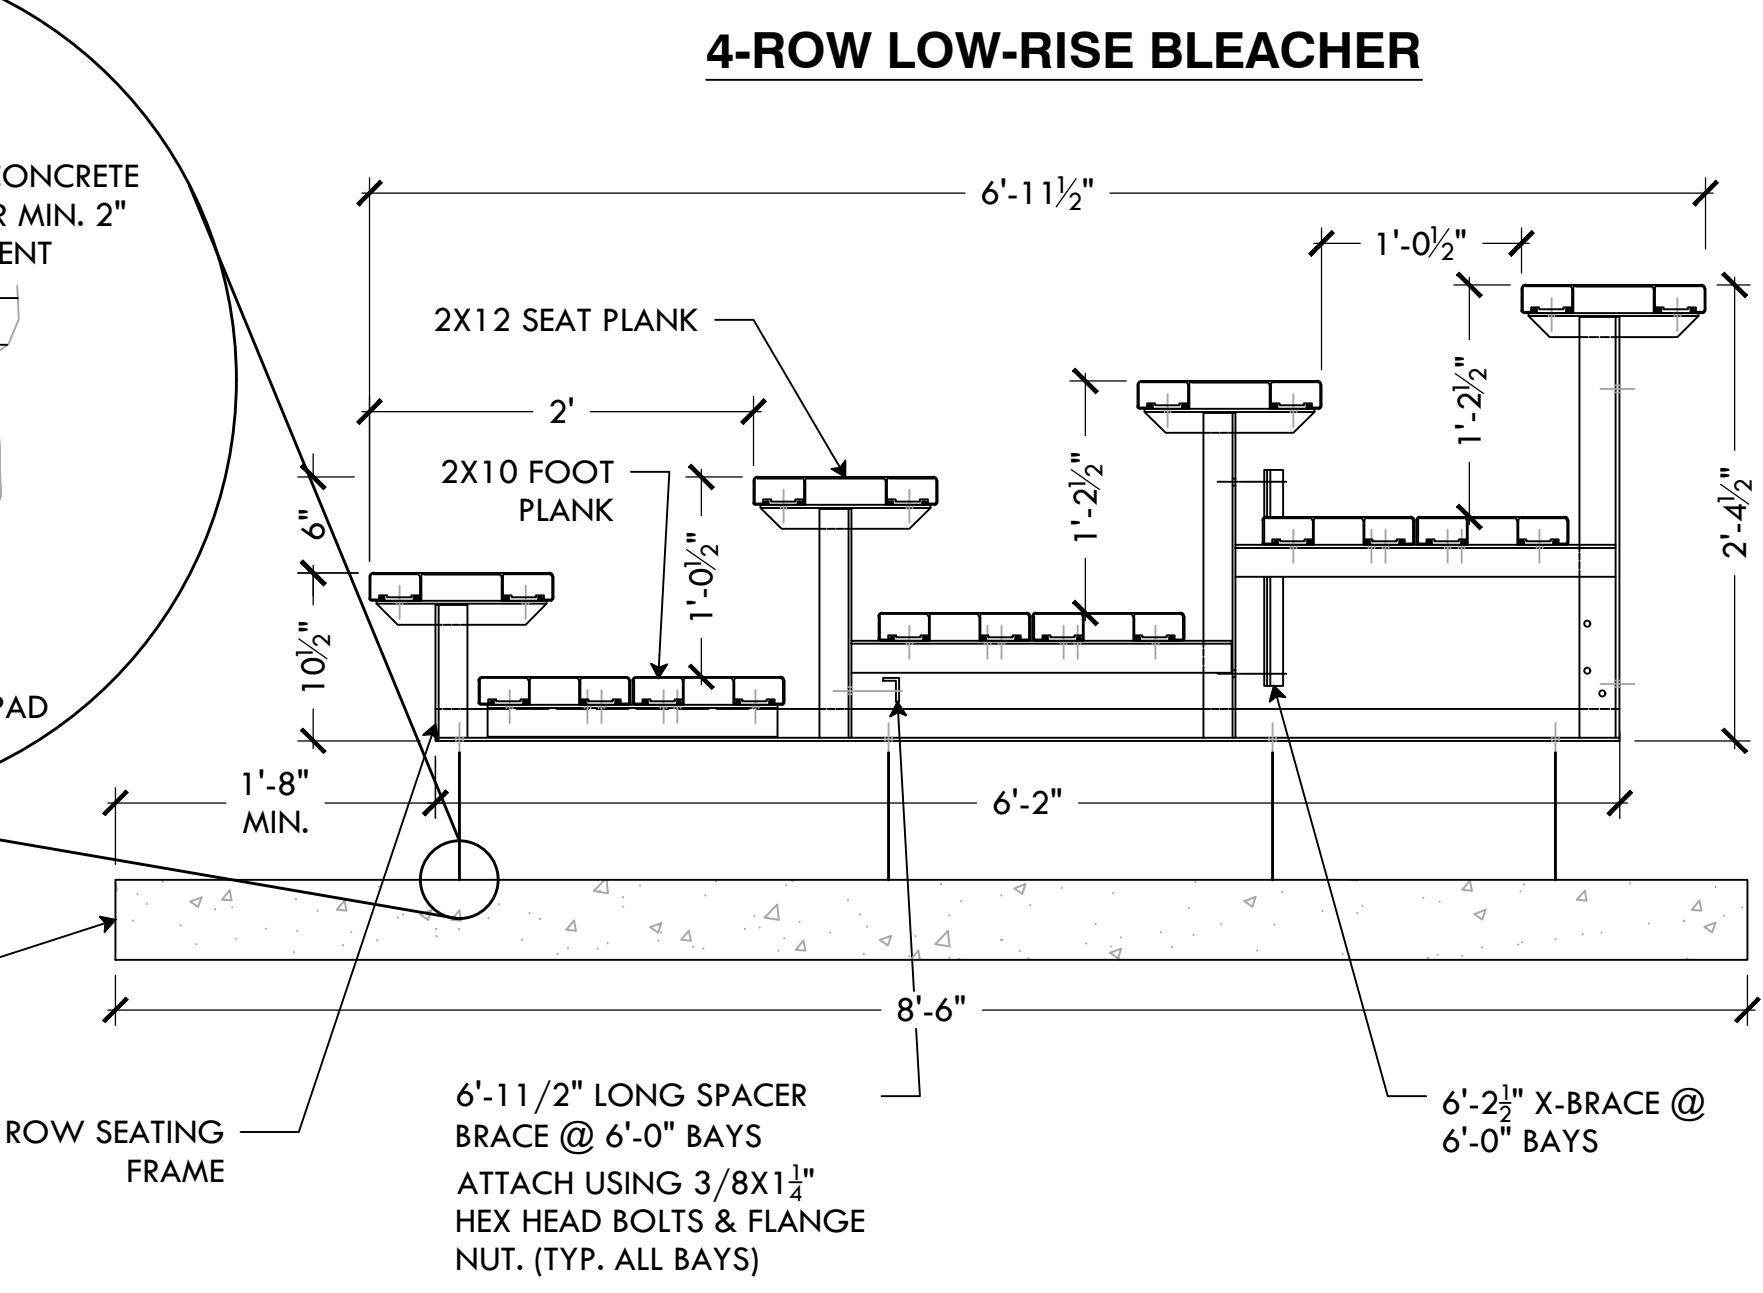


7 4" CONCRETE PAD
NTS

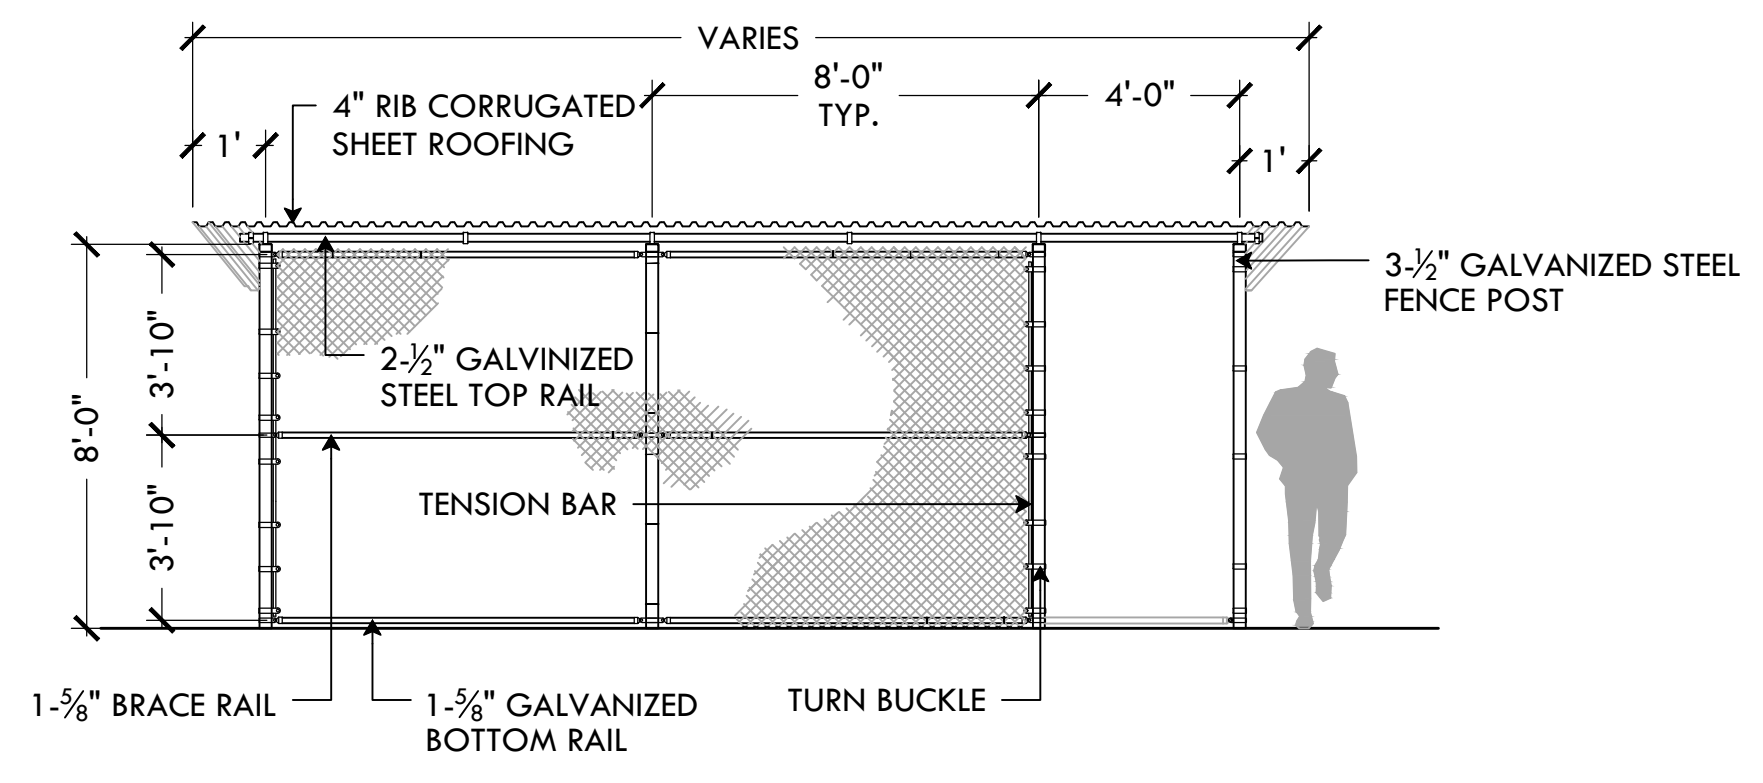

- NOTES:**
- 1) FOOTING WIDTH TO BE (4)X POST WIDTH, MINIMUM DEPTH 36".
 - 2) HEIGHT IN FRONT OF THE DUGOUT WILL BE 8' ABOVE GRADE ELEVATION.
 - 3) ALL POSTS, RAILS, BRACES, AND ACCESSORIES SHALL BE GALVANIZED STEEL WITH A PROTECTED ZINC COATING.

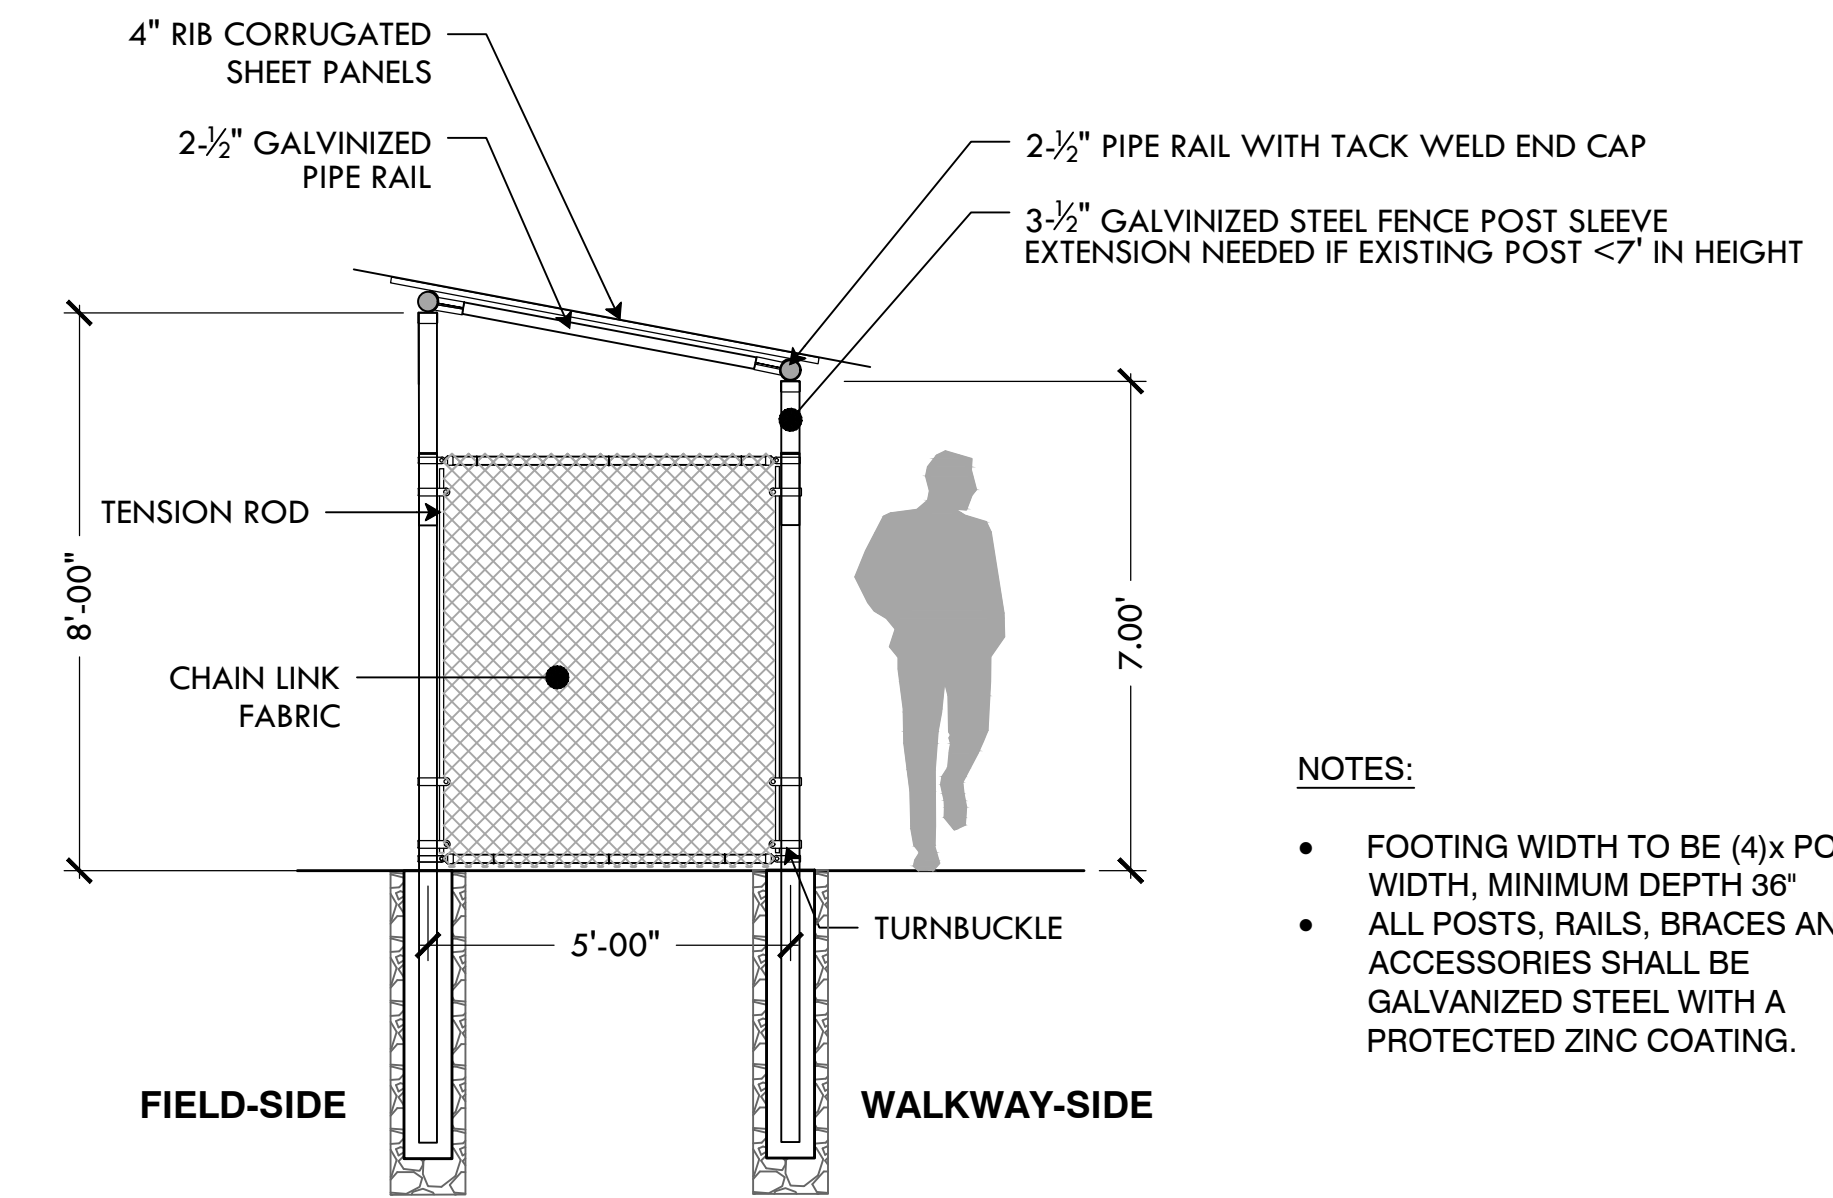


- NOTES:**
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 - ALL POSTS, RAILS, BRACES AND ACCESSORIES SHALL BE GALVANIZED STEEL WITH A PROTECTED ZINC COATING.

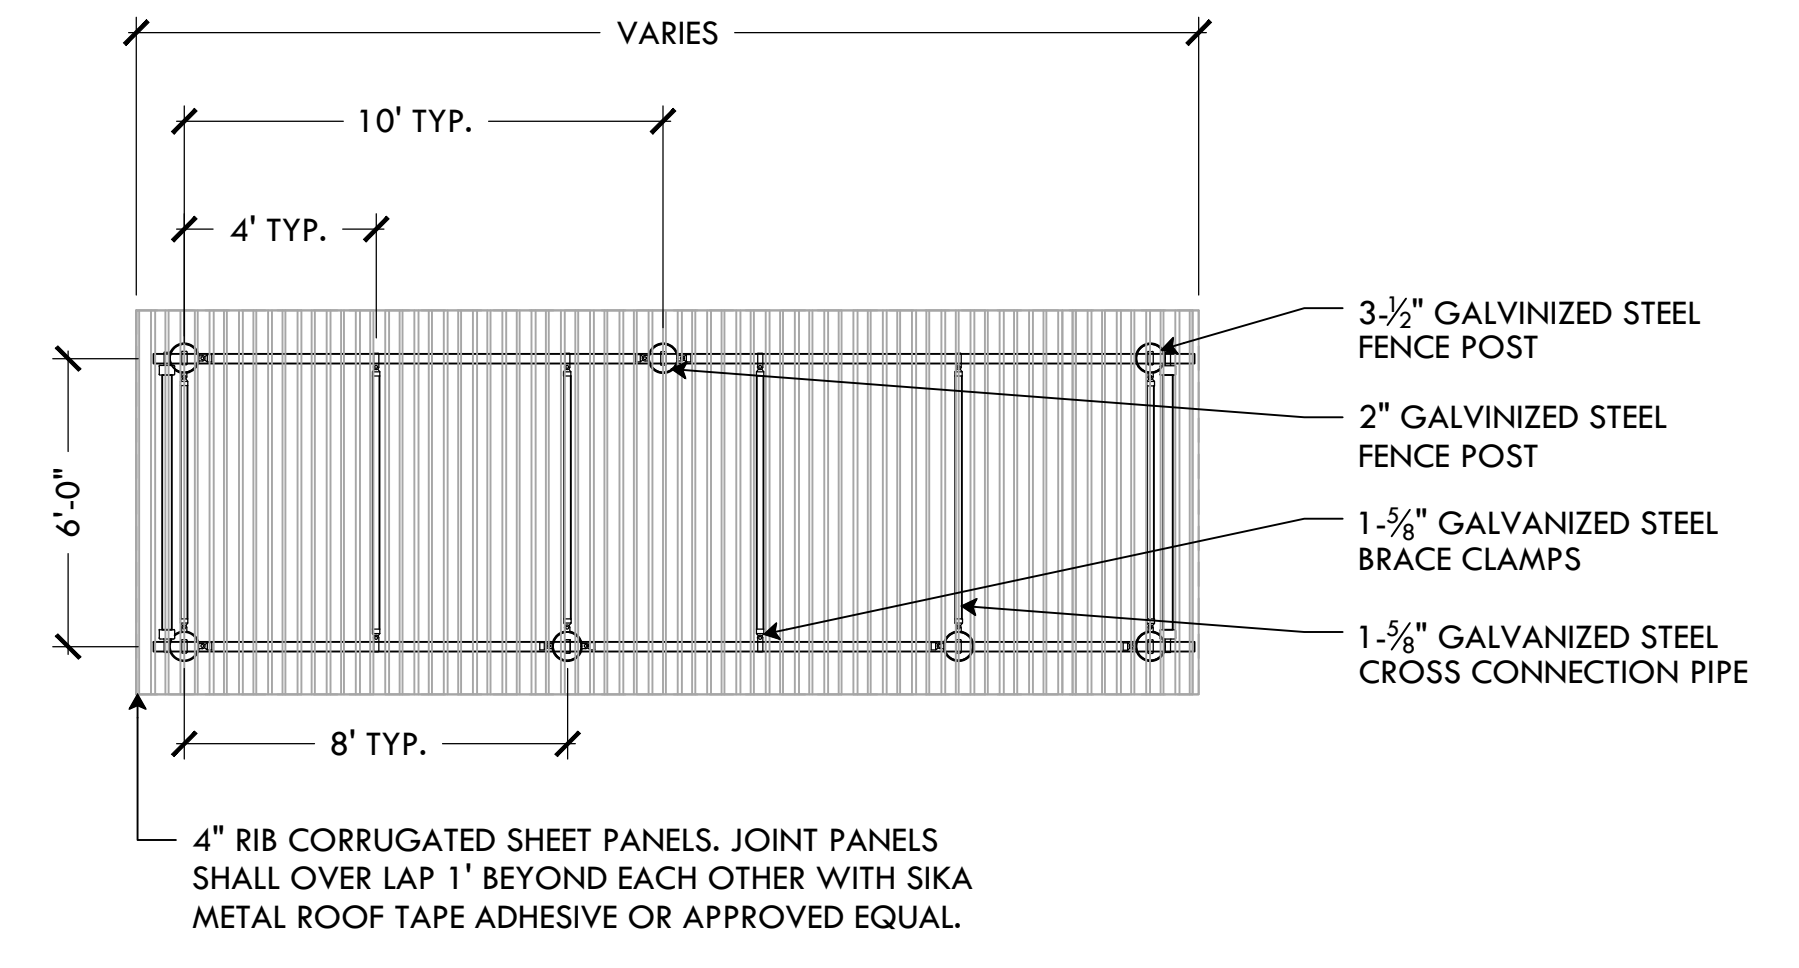


- NOTES:**
- 1) FOOTING WIDTH TO BE (4)X POST WIDTH, MINIMUM DEPTH 36".
 - 2) ALL POSTS, RAILS, BRACES, AND ACCESSORIES SHALL BE GALVANIZED STEEL WITH A PROTECTED ZINC COATING.


11 DUGOUT W/ CORRUGATED ROOF
NTS

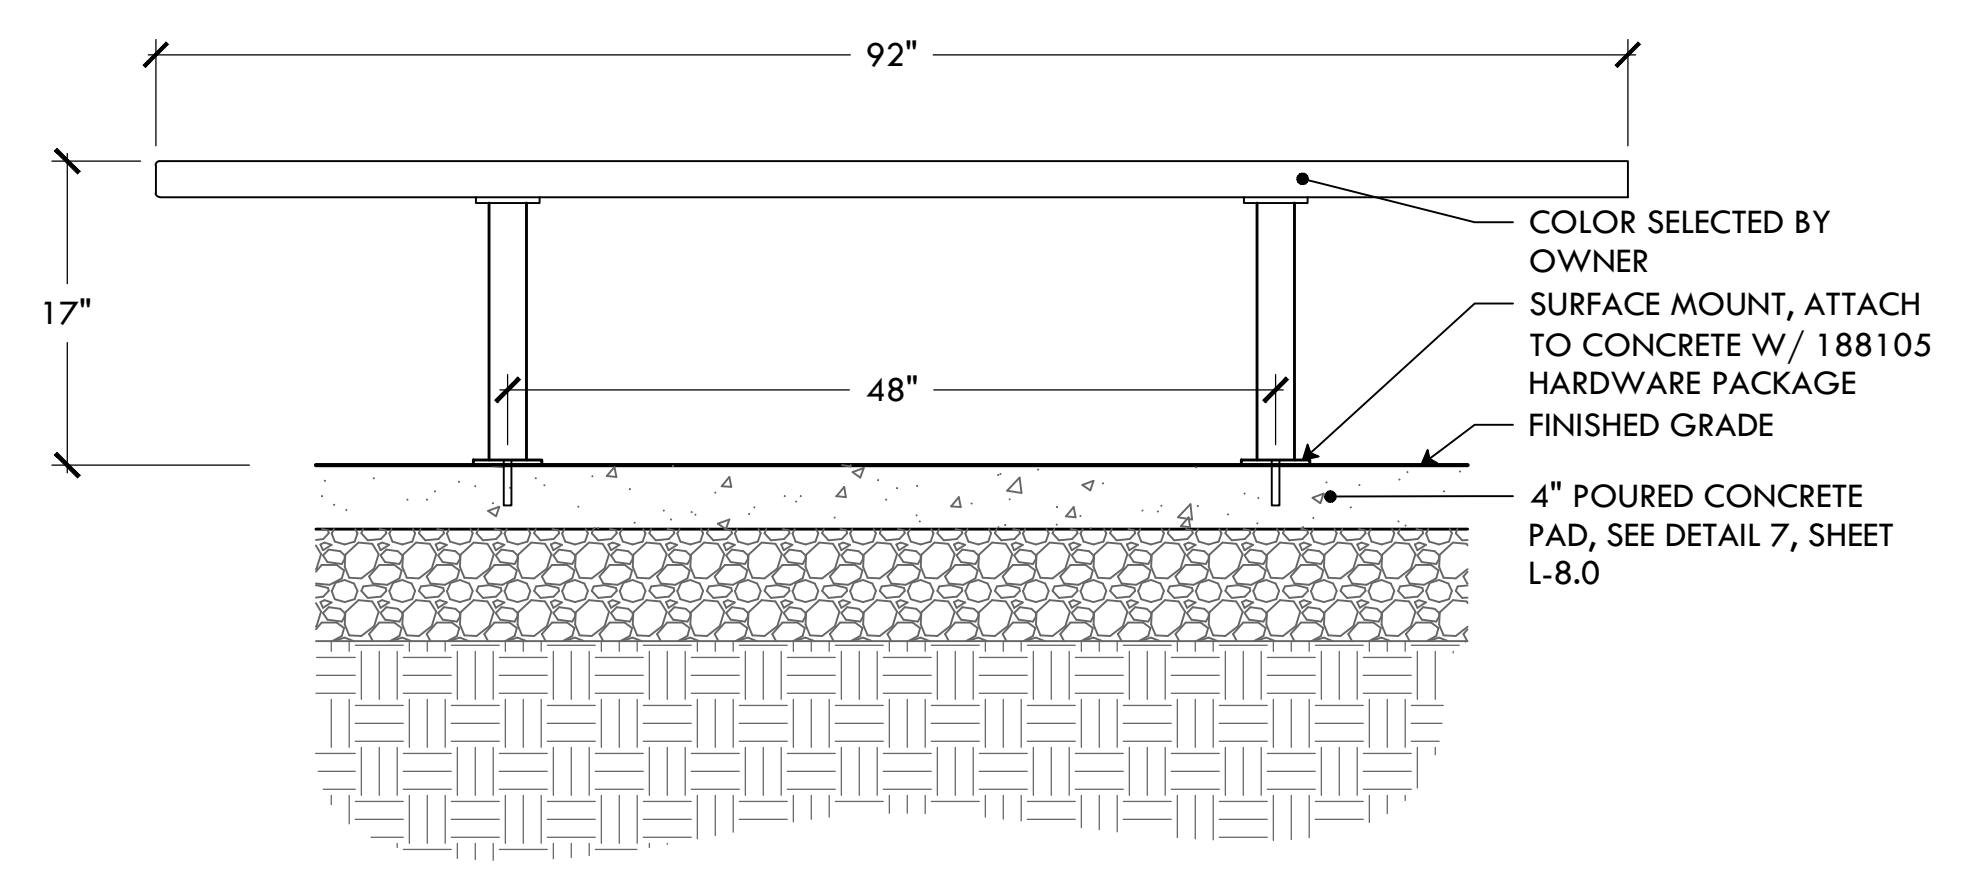

12 DUGOUT BENCH
NTS

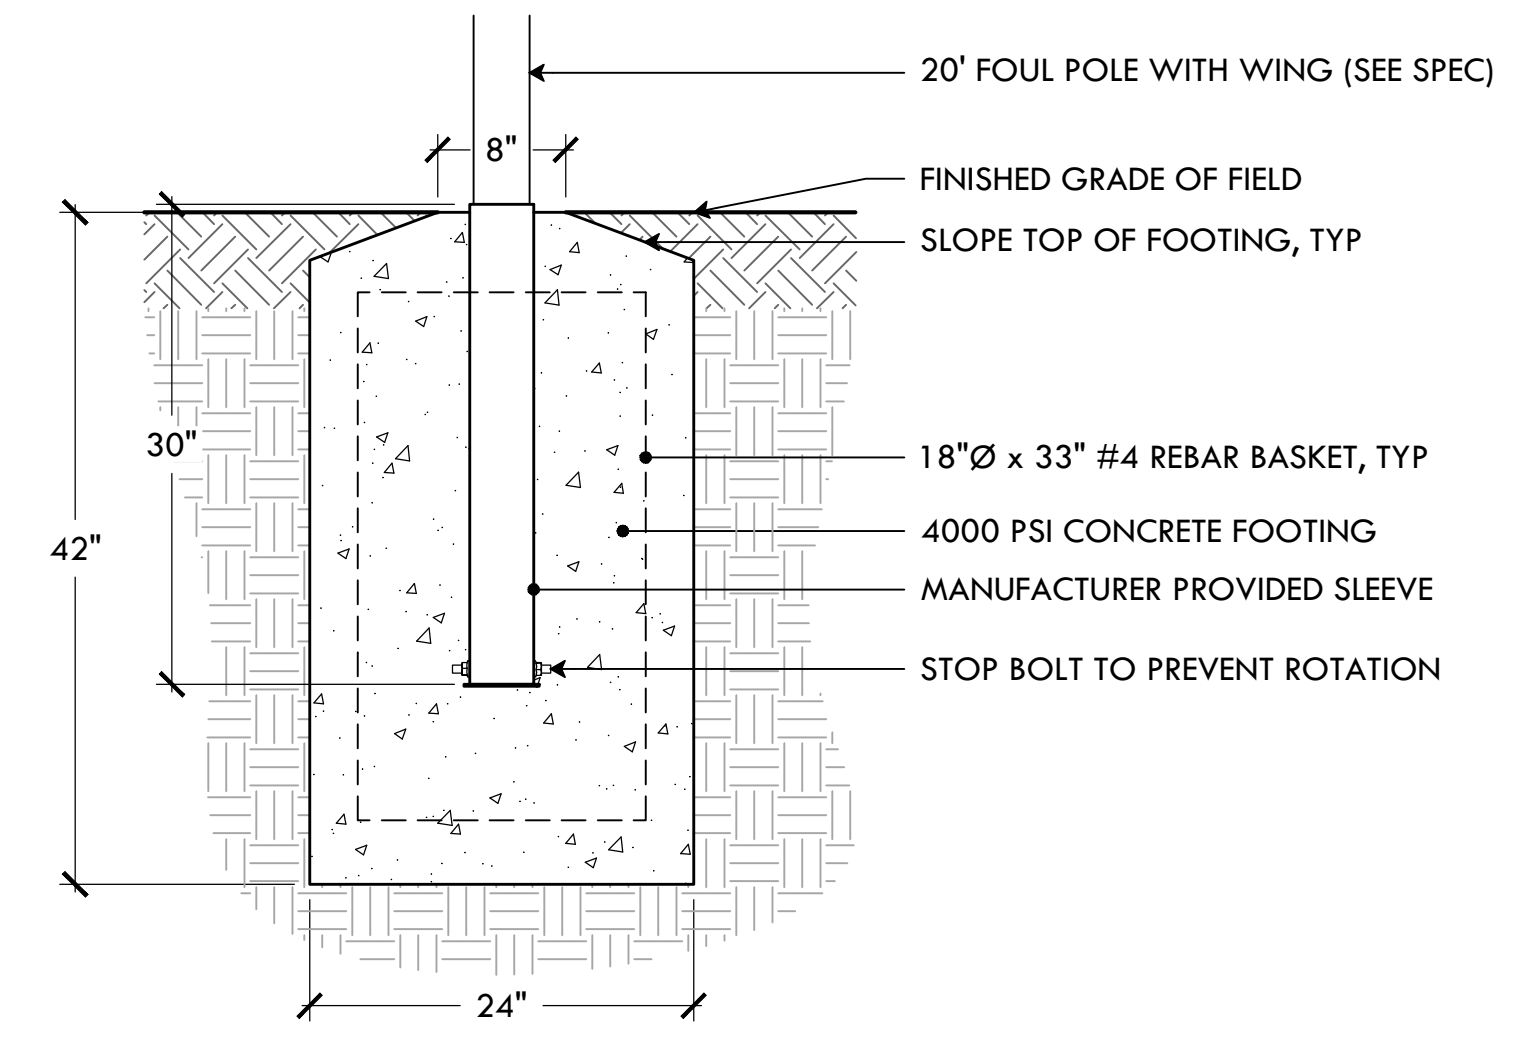


13 FOUL POLE FOOTING
NTS

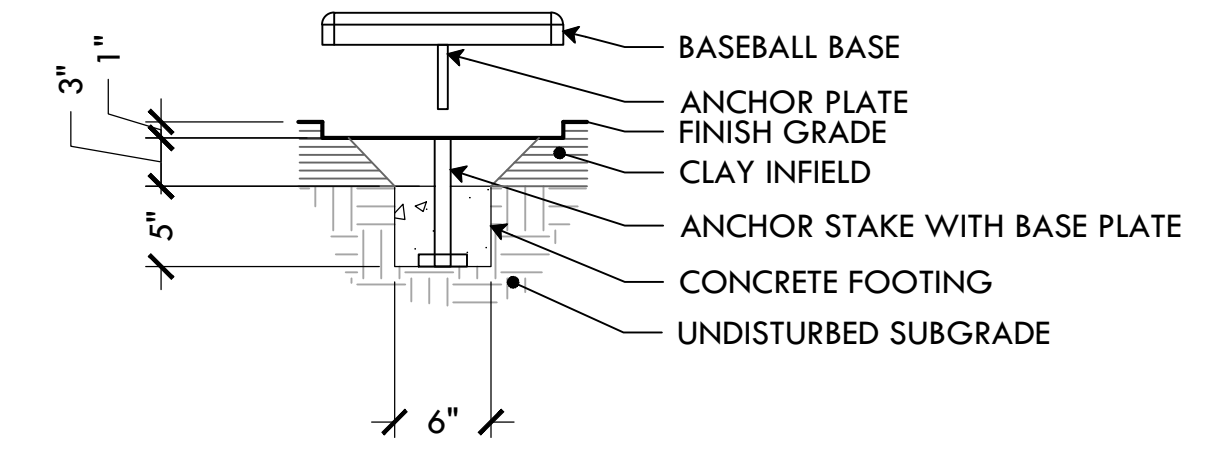


- NOTES:**
1. DETAIL DOES NOT APPLY TO HOME PLATE.
 2. CONCRETE ANCHOR FOOTING SHALL HAVE MIN. 24 HOURS FOR CURING PROCESS PRIOR TO INSTALLING ANCHOR STAKE & BASE.
 3. BASEBALL DIAMOND TO BE LEVEL BEFORE EXCAVATING FOOTING LOCATION.
 4. EXCAVATE FOOTING LOCATION MIN. DEPTH 9" FROM GROUND LEVEL. TOP EDGE OF THE ANCHOR STAKE SHALL BE MIN 1" BELOW FINISH GRADE LEVEL. ANCHOR STAKE SHALL BE PERPENDICULAR TO LEVEL GROUND.
 5. FILL IN THE HOLE BY TAMPING SOIL SOLIDLY AROUND ANCHOR STAKE FOOTING. ALLOW AN AREA THE SIZE OF THE BASE TO BE 1" BELOW THE GROUND LEVEL. POSITION BASE OVER FOOTING, INSTALL INTO PLACE WITH ANCHOR STAKE SLIDING INTO ANCHOR PLATE ON THE BACKSIDE OF BASE. THE TOP OF THE BASE PLATE SHALL BE 2" HIGHER THAN THE LEVEL GRADE.

14 BASEBALL BASE PLATE
NTS

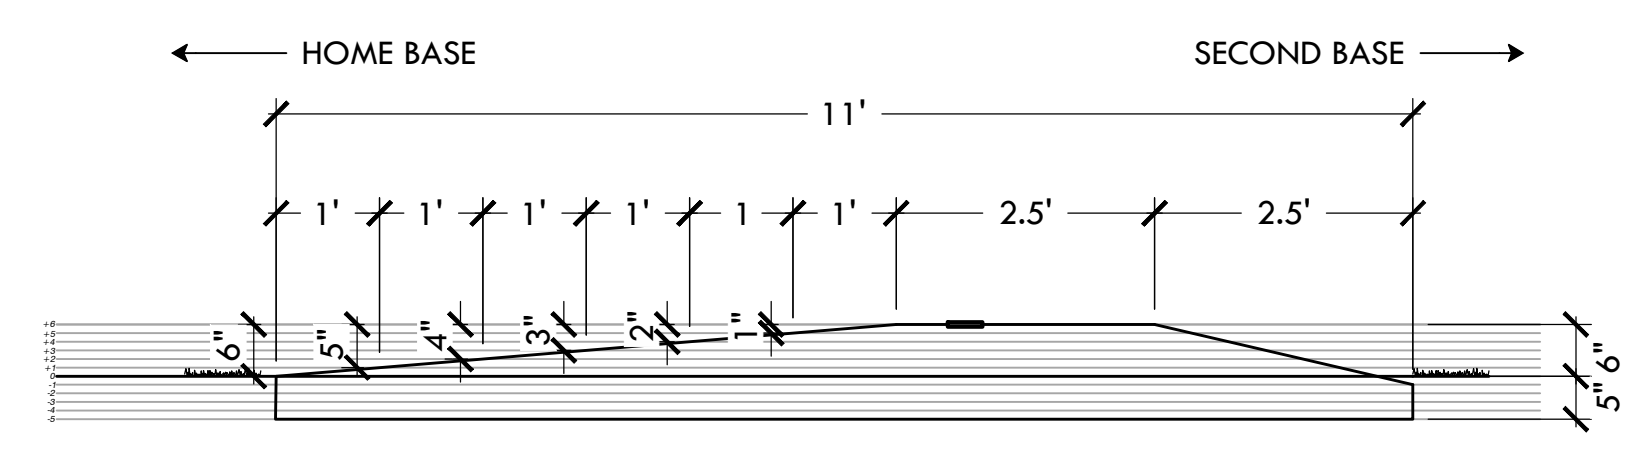


15 BASEBALL PITCHER'S MOUND
NTS

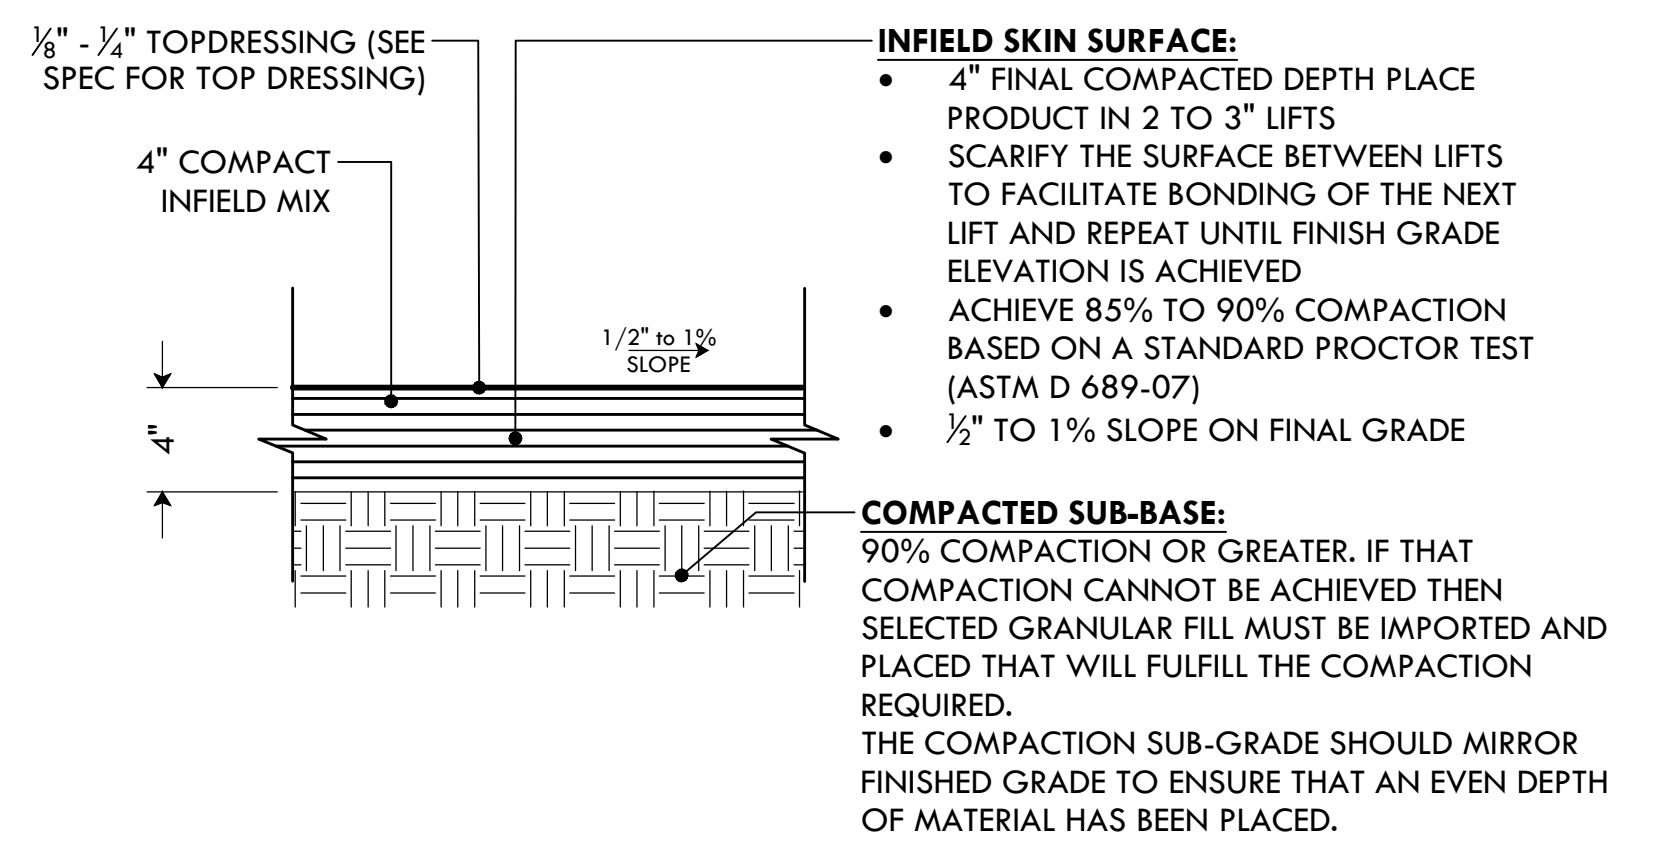

- NOTES:**
1. SAND: 70% TO 75% OF THE TOTAL SAND CONTENT, 50% SHALL BE COMPOSED OF MEDIUM, COARSE, AND VERY COARSE SAND PARTICLES.
 2. SILT & CLAY: THE COMBINED AMOUNT OF SILT AND CLAY SHALL BE BETWEEN 25% AND 30%. THE SILT-TO-CLAY RATIO, SHALL BE BETWEEN 0.5 AND 1.0.

16 INFIELD MIX
NTS

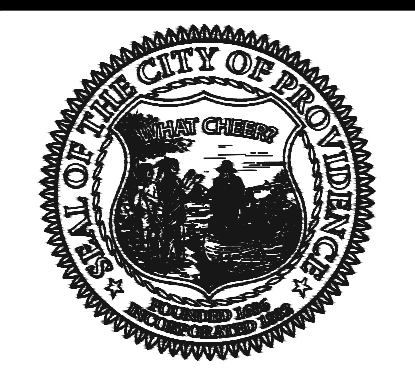

PROVIDENCE PARKS DEPARTMENT
DALRYMPLE BOATHOUSE
ROGER WILLIAMS PARK
PROVIDENCE, RI 02905



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PROJECT:

Re-Bid Site Improvements at Gano St Park
87 Fremont St
Providence, RI 02906

REVISIONS:

Date	Issued For:

NORTH ARROW

SCALE

DRAWING INFO

DATE ISSUED: 01/16/25
PROJECT NO: GSPK.24.01
DRAWN BY: SH, II
CHECKED BY: MG

SHEET TITLE

Construction Details 2

L-9

Model LX1250 Outdoor LED Baseball Scoreboard Cutsheet with Mechanical Detail

Cabinet Size, Weight:
14 ft. x 5 ft., 218 lbs.

Electrical Requirements:
1.6 Amps, 120 VAC

Display Sizes:
18 in. tall Home Score
18 in. tall Guest Score
18 in. tall Inning
18 in. tall Ball
18 in. tall Strike
18 in. tall Out
4 in. H/E Indicators

Standard Post Sizes:
2 each, max diameter 4.5 in.

Standard Equipment & Features

- Single cabinet design with heavy duty extruded aluminum framing
- Light weight, rust free, all aluminum construction
- Mounting hardware for permanent installation on two posts without the need for on site fabrication
- Automotive grade baked on enamel based paint applied to the scoreboard face
- Choice of 18 standard paint colors
- Full color video and other electronic display panels
- Stadium Sound System packages
- Choice of amber or red LED displays
- LED display circuit boards conformal coated for outdoor use
- Simplified 15-key control console
- Junction box and patch cable for hardwired installations
- Five-year limited warranty
- Toll free technical support via phone and online for the life of the product

Optional Equipment & Features

- Electronic Team Names
- ID panels with custom graphics, in a variety of sizes, shapes and styles, to mount above or below the scoreboard
- Extended configurations for ID panels built into the left or right side of the scoreboard cabinet
- Full color video and other electronic display panels
- Stadium Sound System packages
- Custom paint colors
- Team name in place of HOME
- Full-sized 37-key control console with LCD display
- Up to 1,000 feet of data cable for hardwired installations
- ScoreLink wireless RF modem system for wireless communication
- Additional warranty and support plans

TDD/ Rev 2012-Sept. Electro-Mech Scoreboard Co. 72 Industrial Blvd. • Wrightsville, GA 31096 800-445-7856 www.electro-mech.com

ELECTRO-MECH SCOREBOARD COMPANY

MODEL LX1250
Outdoor
Baseball / Softball

Dimensions	Weight	Cabinet Material	Caption Height	Accent Material
14 ft x 5 ft	218 lb	Aluminum	9 in, 8 in	2.4 mil cast vinyl


Digit Height	Indicator Size	Digit Colors	Electrical
18 in	4 in	Amber or Red	1.6 Amps, 120 VAC

STANDARD EQUIPMENT & FEATURES


- Single cabinet design with heavy duty extruded aluminum framing
- Light weight, rust free, all aluminum construction
- Mounting hardware for permanent installation on two posts without the need for on site fabrication
- Automotive grade baked on enamel based paint applied to the scoreboard face
- Choice of 18 standard paint colors
- Choice of amber or red LED displays
- LED display circuit scoreboards conformal coated for outdoor use
- Simplified 15-key control console
- Junction box and patch cable for hardwired installations
- Five-year limited warranty
- Toll free technical support via phone and online for the life of the product

OPTIONAL EQUIPMENT & UPGRADES

- Electronic Team Names
- ID panels with custom graphics, in a variety of sizes, shapes and styles, to mount above or below the scoreboard
- Extended configurations for ID panels built into the left or right side of the scoreboard cabinet
- Full color video and other electronic display panels
- Stadium Sound System packages
- Custom paint colors
- Team name in place of HOME
- Full-sized 37-key control console with LCD display
- Up to 1,000 feet of data cable for hardwired installations
- ScoreLink Wireless RF modem system for wireless communication
- Additional warranty and support plans

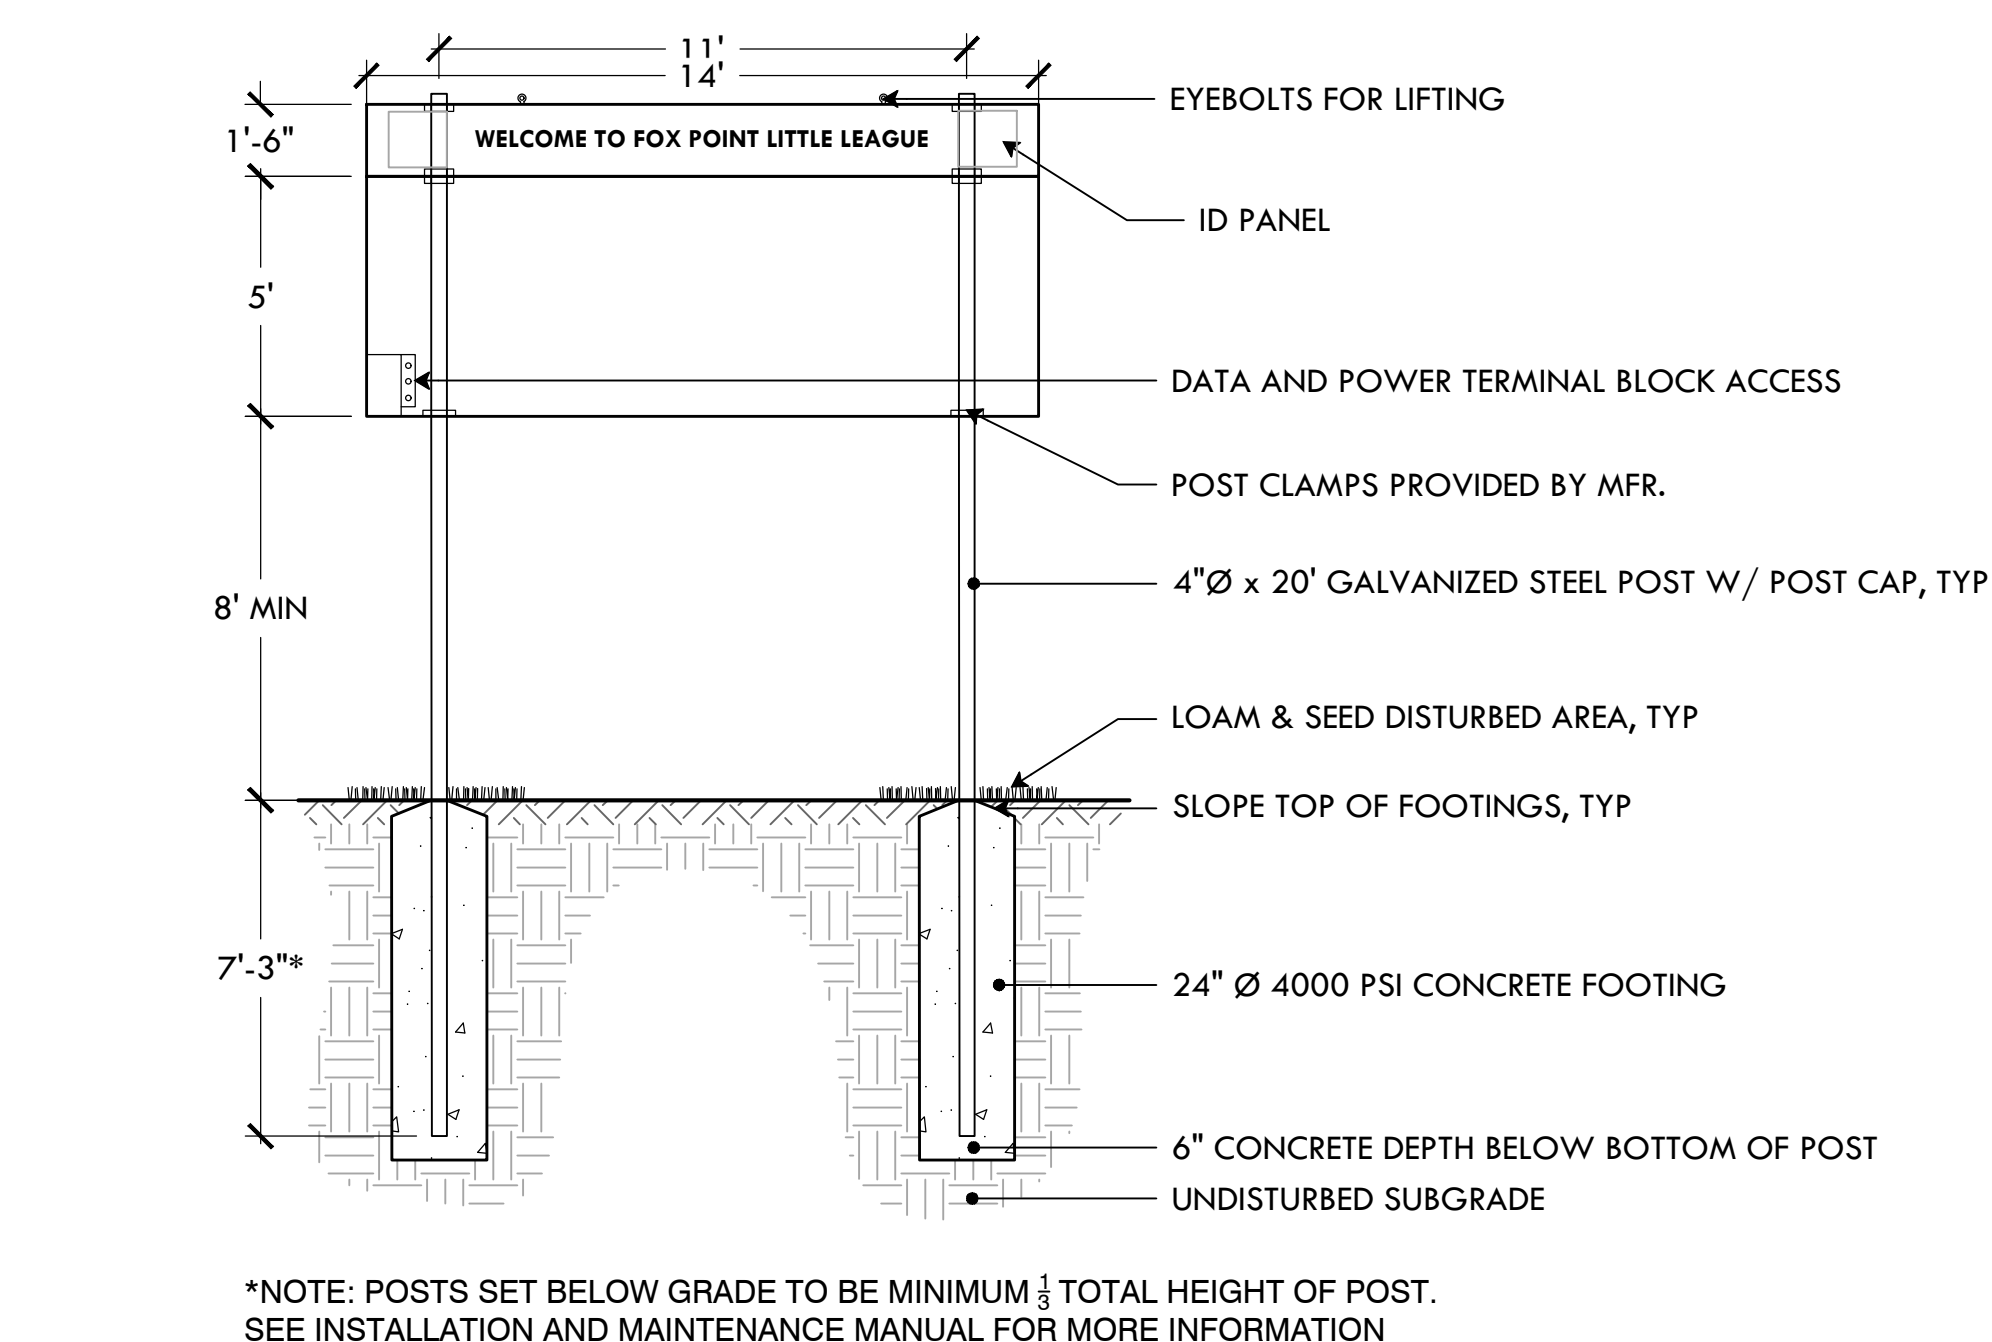

18 SCOREBOARD FOOTING
NTS

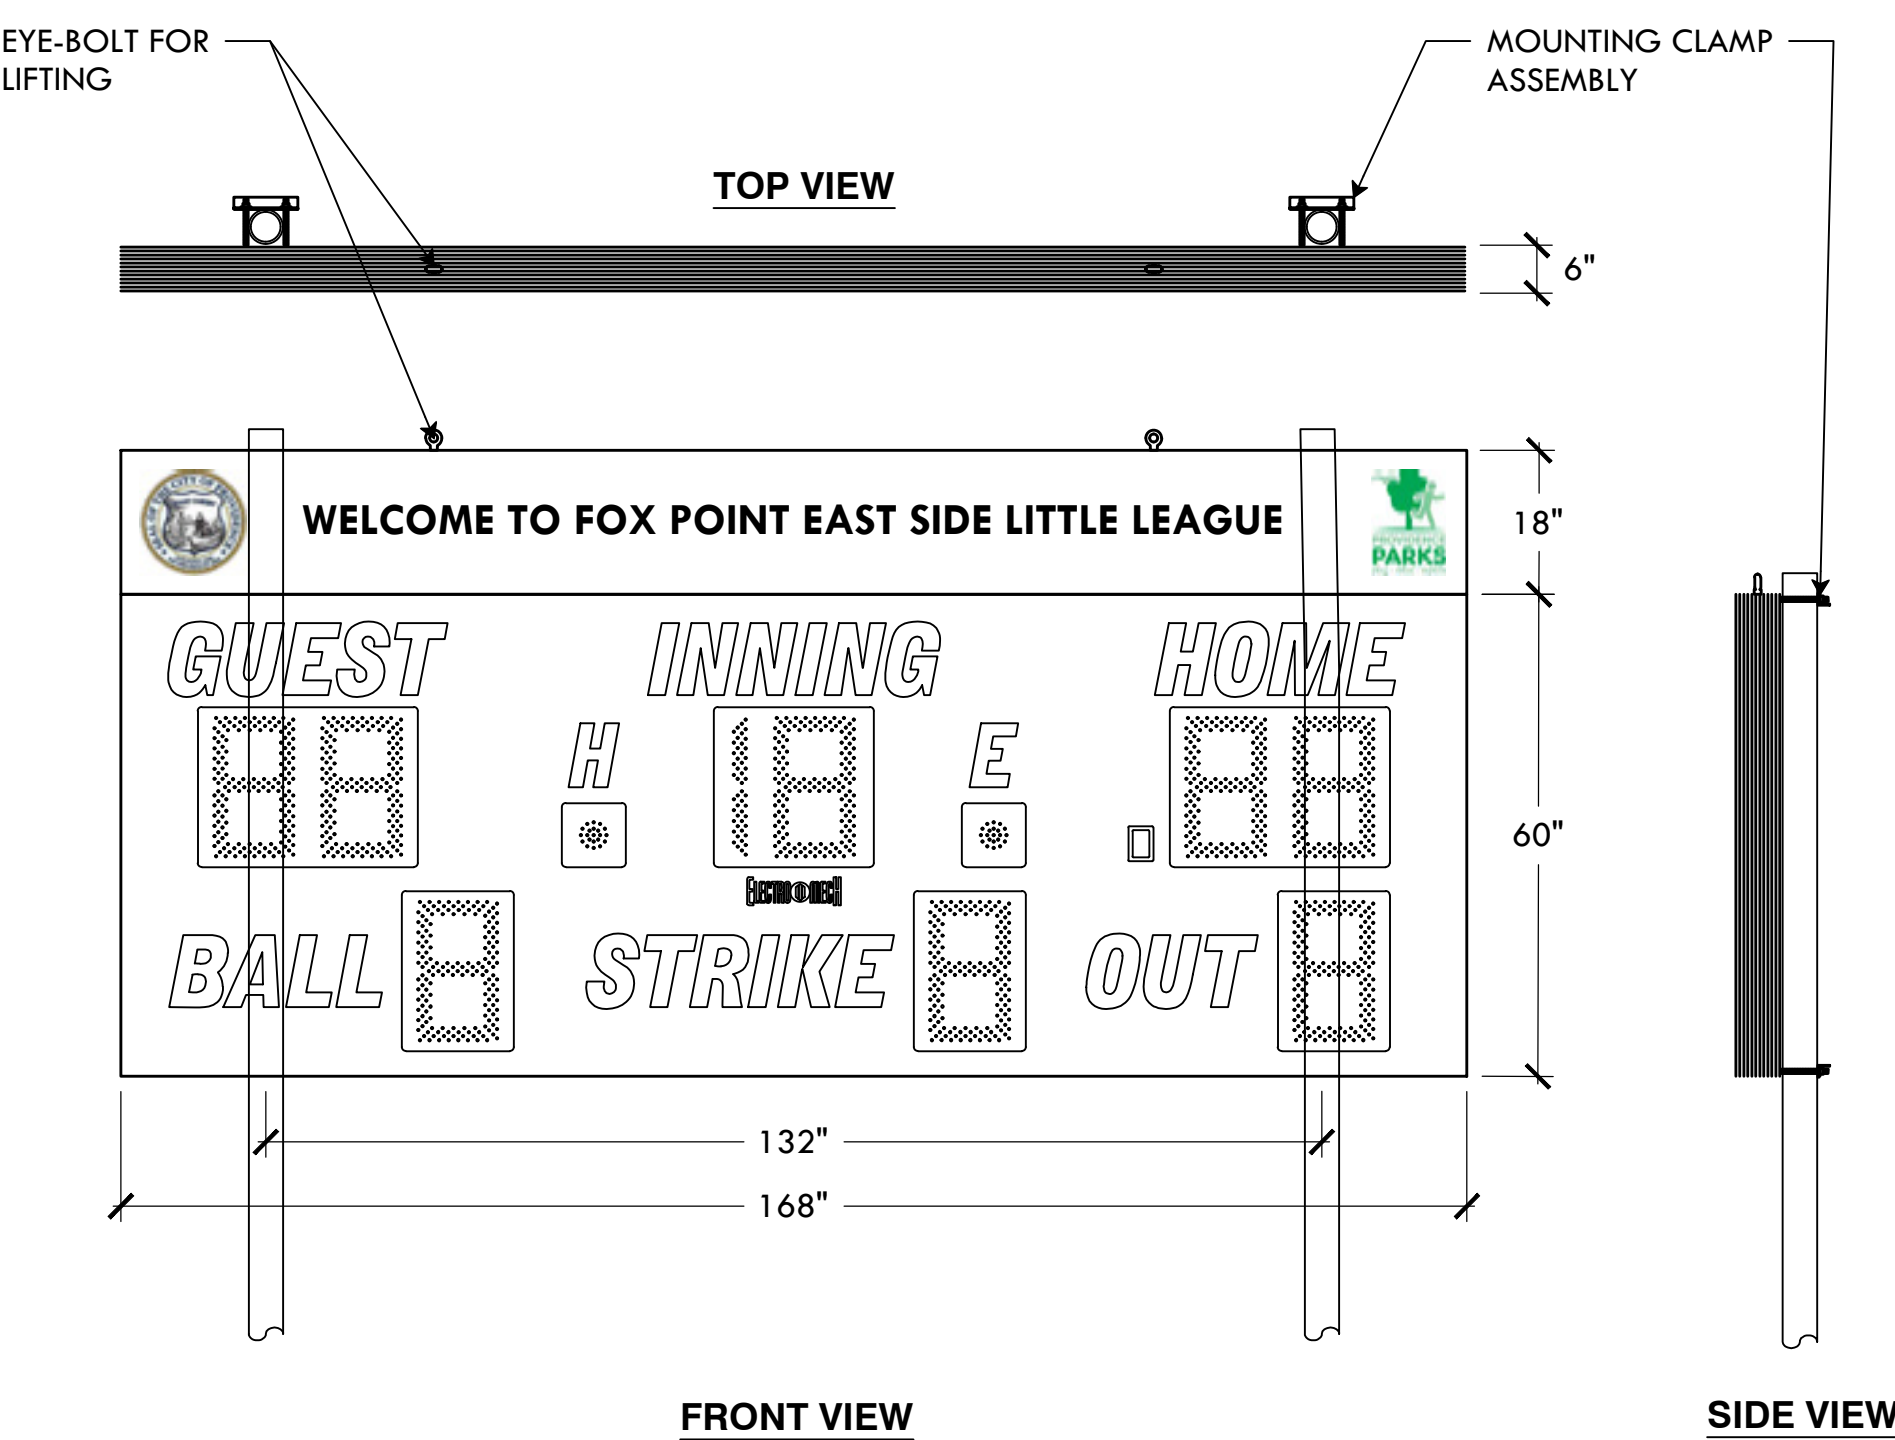

DIGITS / INDICATORS

All digits for this model are 18 inches tall, and indicators are 4 inches in diameter. Digits and indicators are formed from matrices of super-bright, long-lasting, energy-efficient LEDs (Light Emitting Diodes). Choose either amber or red LEDs for all outdoor products. Our LED assemblies are protected by aluminum masks that allow the hard epoxy shells of the LEDs to be exposed for maximum viewing angles.

PAINT COLOR OPTIONS

Rev 2.0.2017.06.08 Electro-Mech Scoreboard Company 72 Industrial Blvd. • Wrightsville, GA 31096 www.electro-mech.com • 800-445-7846

ELECTRO-MECH SCOREBOARD COMPANY



MM-Series Scoreboard Control Console
Available for the following sports:
Baseball/Softball
Baseball/Football
Football

STANDARD FEATURES

User friendly, feature packed software

- Sport-specific configuration (no codes to enter)
- Simplified layout
- Perfect synchronization with multiple scoreboards
- Support for wired or wireless data transmission
- Flash memory for saving game data during power loss

Attached 6 ft. power cord

Additional Features

- ETL Listed
- Made in the USA

PHYSICAL DESCRIPTION

Membrane Keypad

- 15 dome switches with tactile feedback
- 3M vinyl overlay

ABS Plastic Enclosure

- Desktop configuration
- Flame retardant, high impact plastic
- Painted steel back plate

Dimensions

- Width: 11.5 inches
- Depth: 9 inches
- Height: 5.5 inches
- Weight: 5 pounds

Power Requirements

- Voltage: 120 VAC
- Amperage: 0.5 Amps
- AC Frequency: 60 Hz
- Requires standard grounded power receptacle

Data Input and Output


- One 1/4 in. Stereo Cable Data Output Jack
- Optional RJ-45 style Clock Control Input Jack

OTHER INFO

The MM Scoreboard Console was designed for our budget friendly baseball, softball, and football scoreboards and only works on the following models (these can be upgraded at any time to an MP console to support additional features): LX1020, LX1030, LX1050, LX1060, LX1062, LX1064, LX1070, LX1240, LX1241, LX1244, LX1250, LX1260, LX1340, LX1341, LX1342, LX1499, LX1500.

ELECTRO-MECH
72 Industrial Blvd.
Wrightsville, GA 31096
(800)-445-7846
electro-mech.com


19 LOAM & HYRDOSEED
NTS

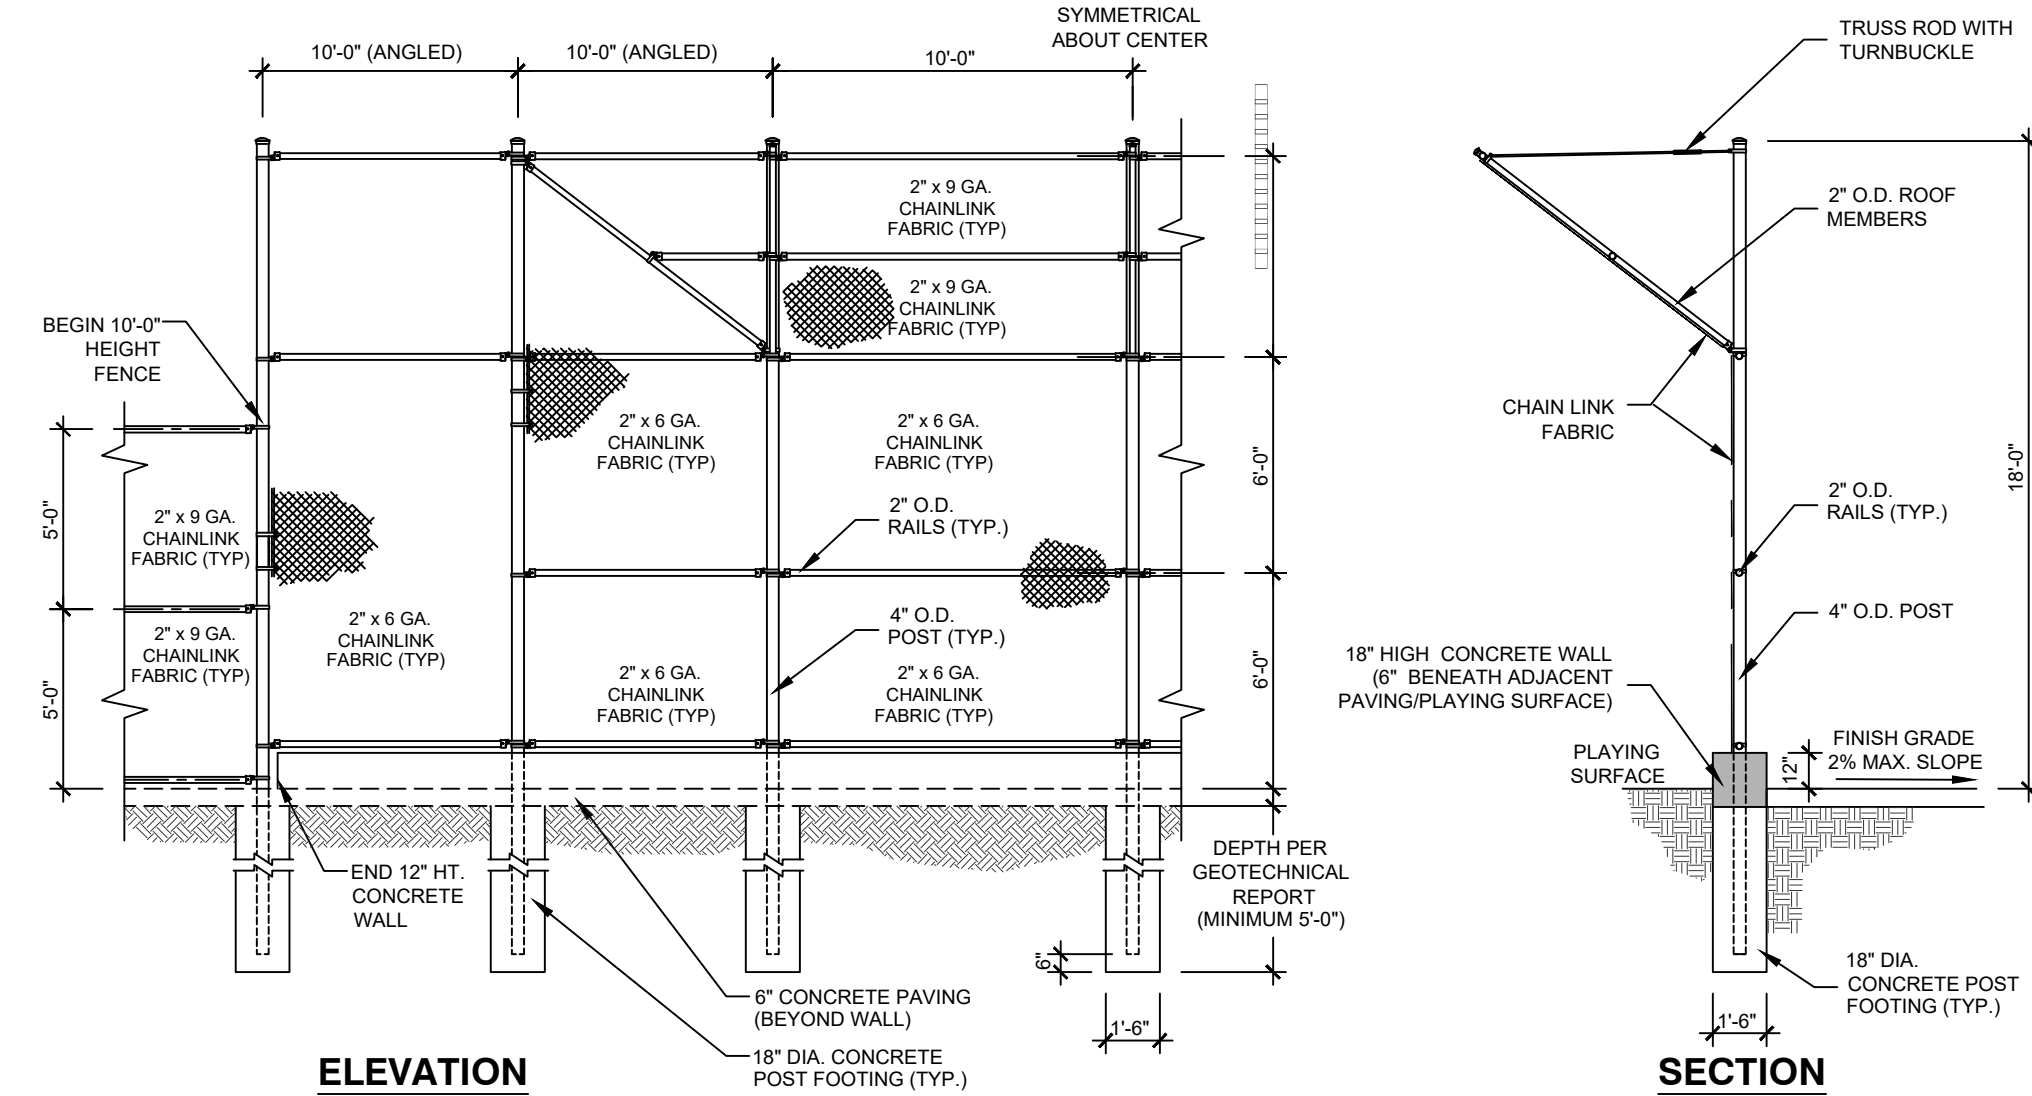

- NOTES:**
1. UNLESS NOTED OTHERWISE, ALL POSTS AND RAILS TO BE SCHEDULE 40 GALVANIZED.
 2. UNLESS NOTED OTHERWISE, ALL FABRIC TO BE GALVANIZED.
 3. UNLESS NOTED OTHERWISE, ALL FASTENERS AND CHAIN LINK FENCE ACCESSORY ITEMS TO BE GALVANIZED.
 4. NO ALUMINUM TIES SHALL BE PERMITTED.
 5. CHAIN LINK FABRIC ON BOTTOM TWO PANELS OF ENTIRE BACKSTOP SHALL BE 6 GAUGE.

20 BACKSTOP
NTS

17 14' SCOREBOARD
NTS

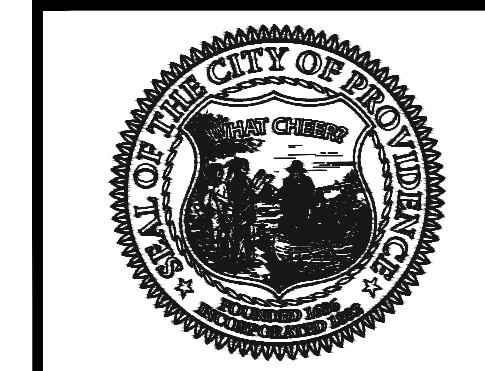

PROVIDENCE PARKS DEPARTMENT
DALRYMPLE BOATHOUSE
ROGER WILLIAMS PARK
PROVIDENCE, RI 02905



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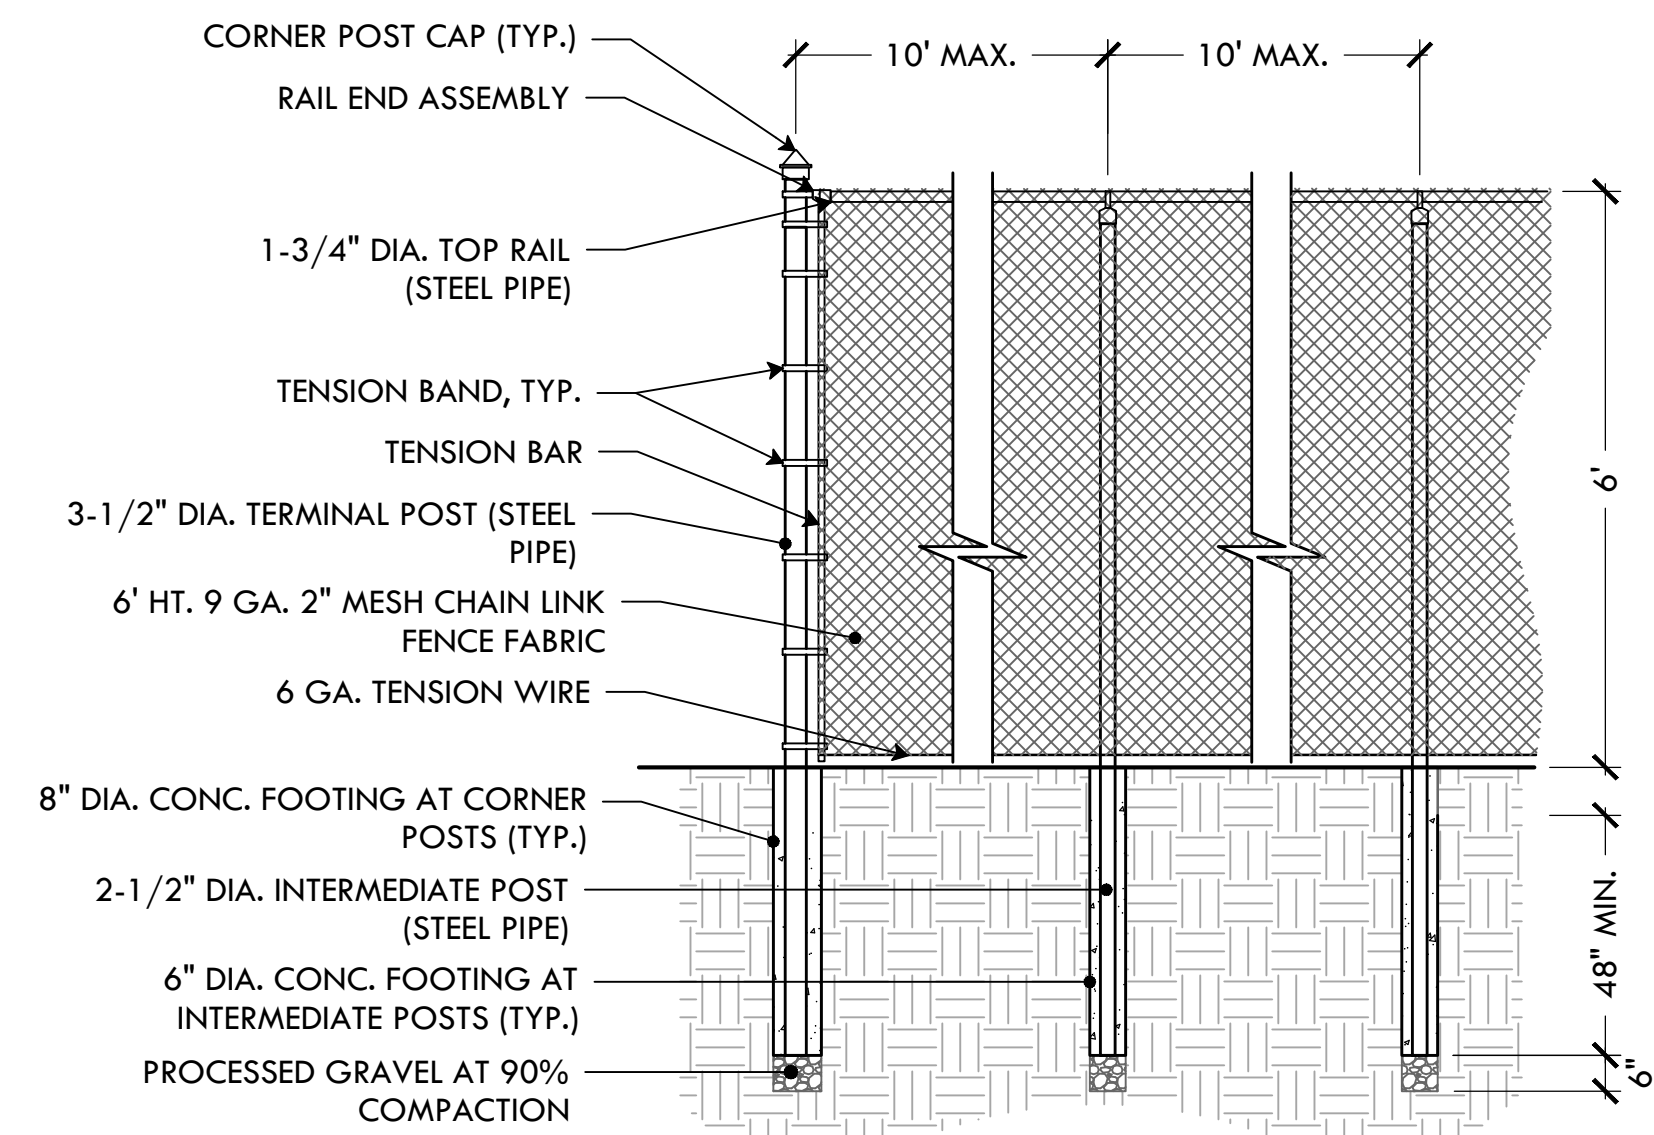
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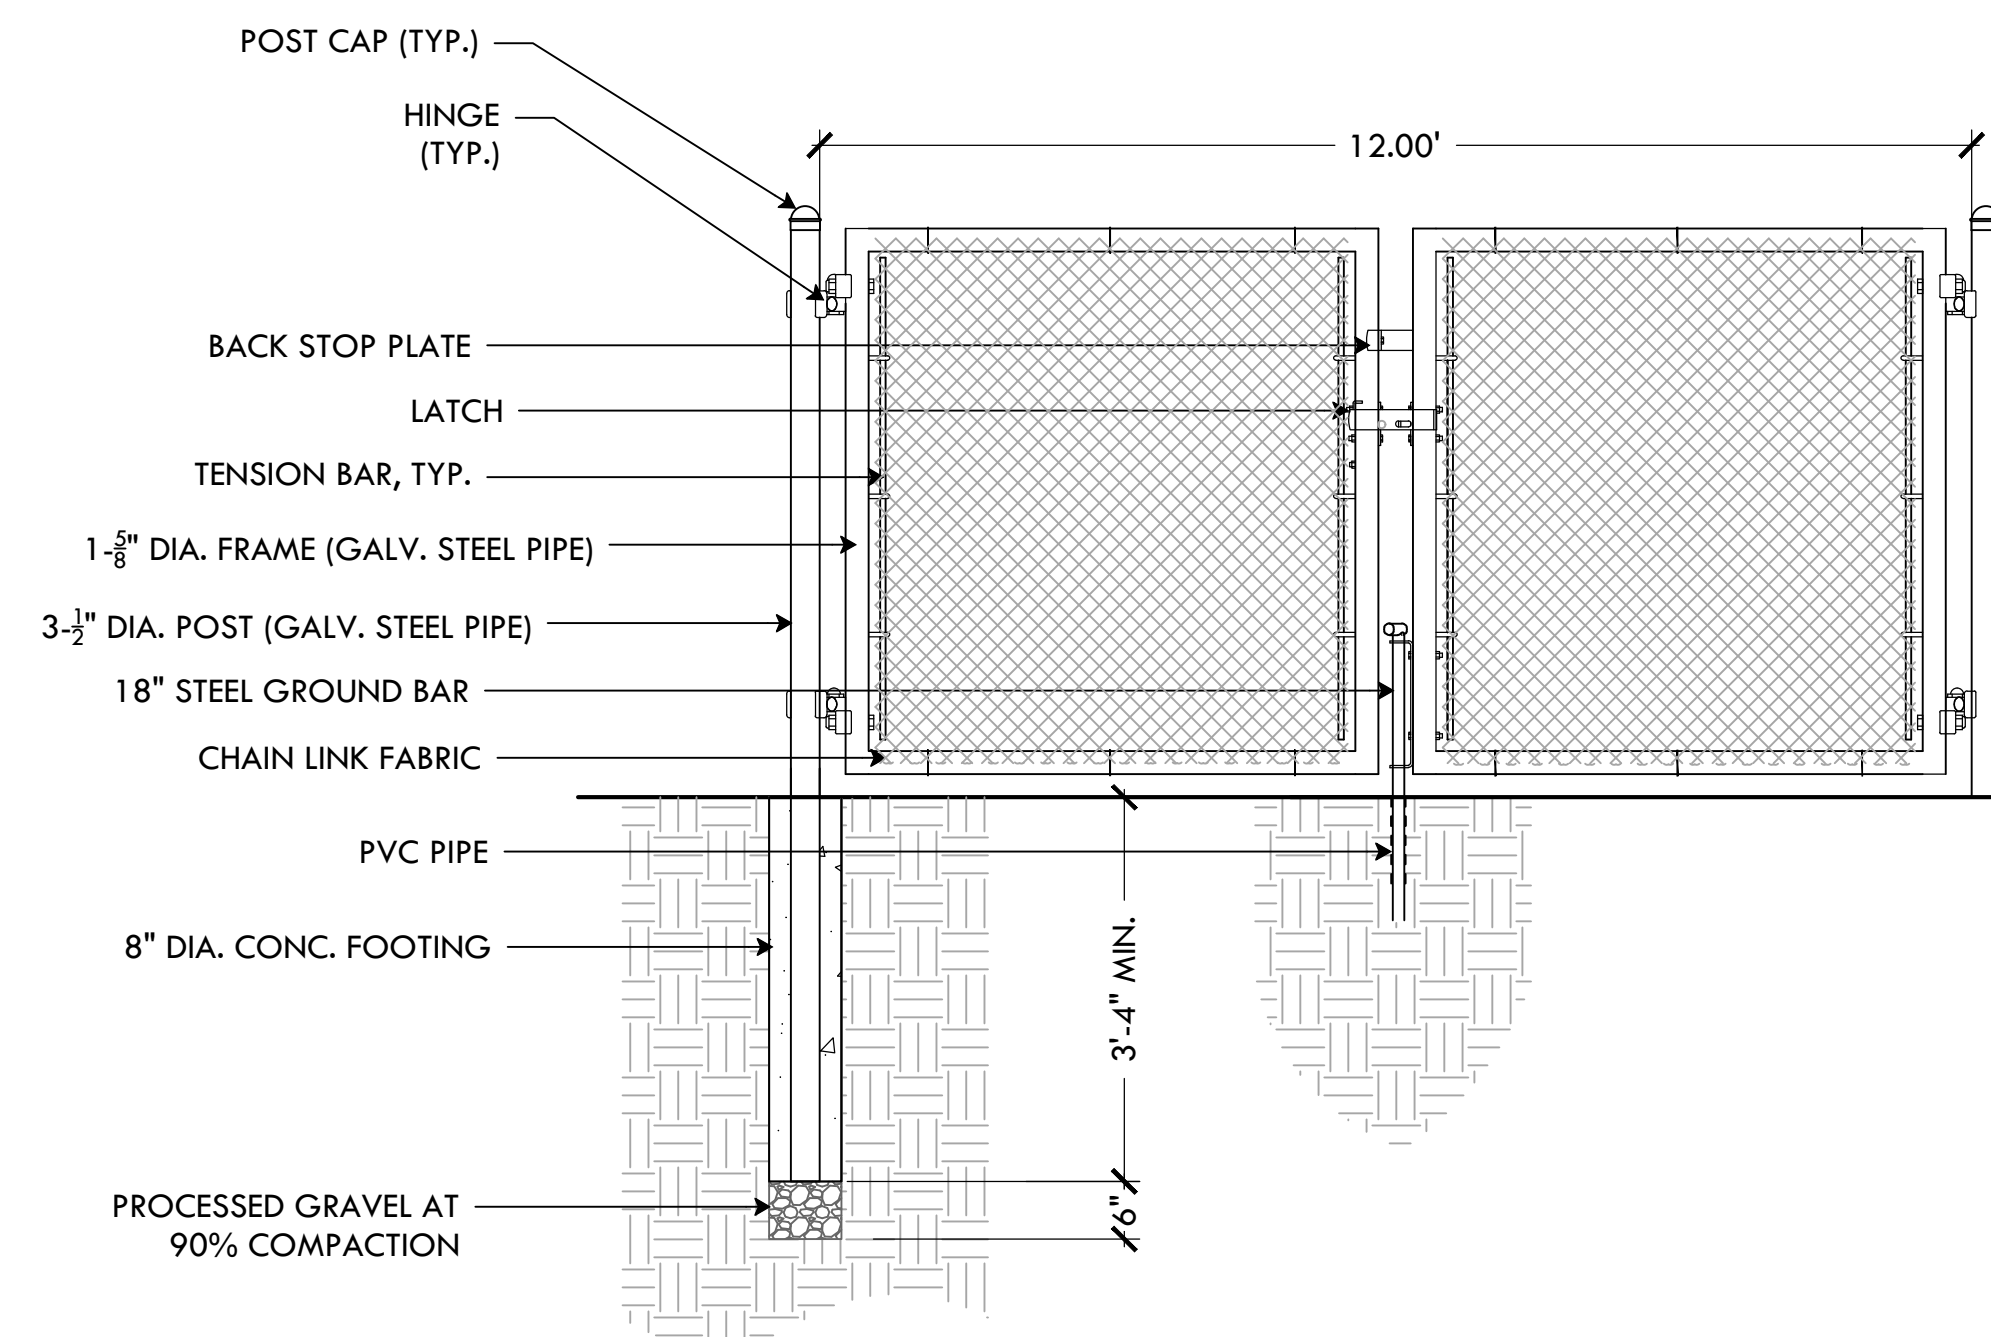
DRAWING INFO
DATE ISSUED: 01/16/25
PROJECT NO: GSPK.24.01
DRAWN BY: SH, II
CHECKED BY: MG

SHEET TITLE
Construction Details 3




- NOTES:
1. FENCING TO BE TIED TO TOP RAILS & LINE POSTS W/ 9GA. WIRE SPACED AT 12"
 2. BRACE ALL CORNERS & TERMINAL POSTS W/ 1-3/4\"/>

21 6' HT. CHAIN LINK FENCE
NTS




22 12' WIDE CHAIN LINK SERVICE GATE
NTS

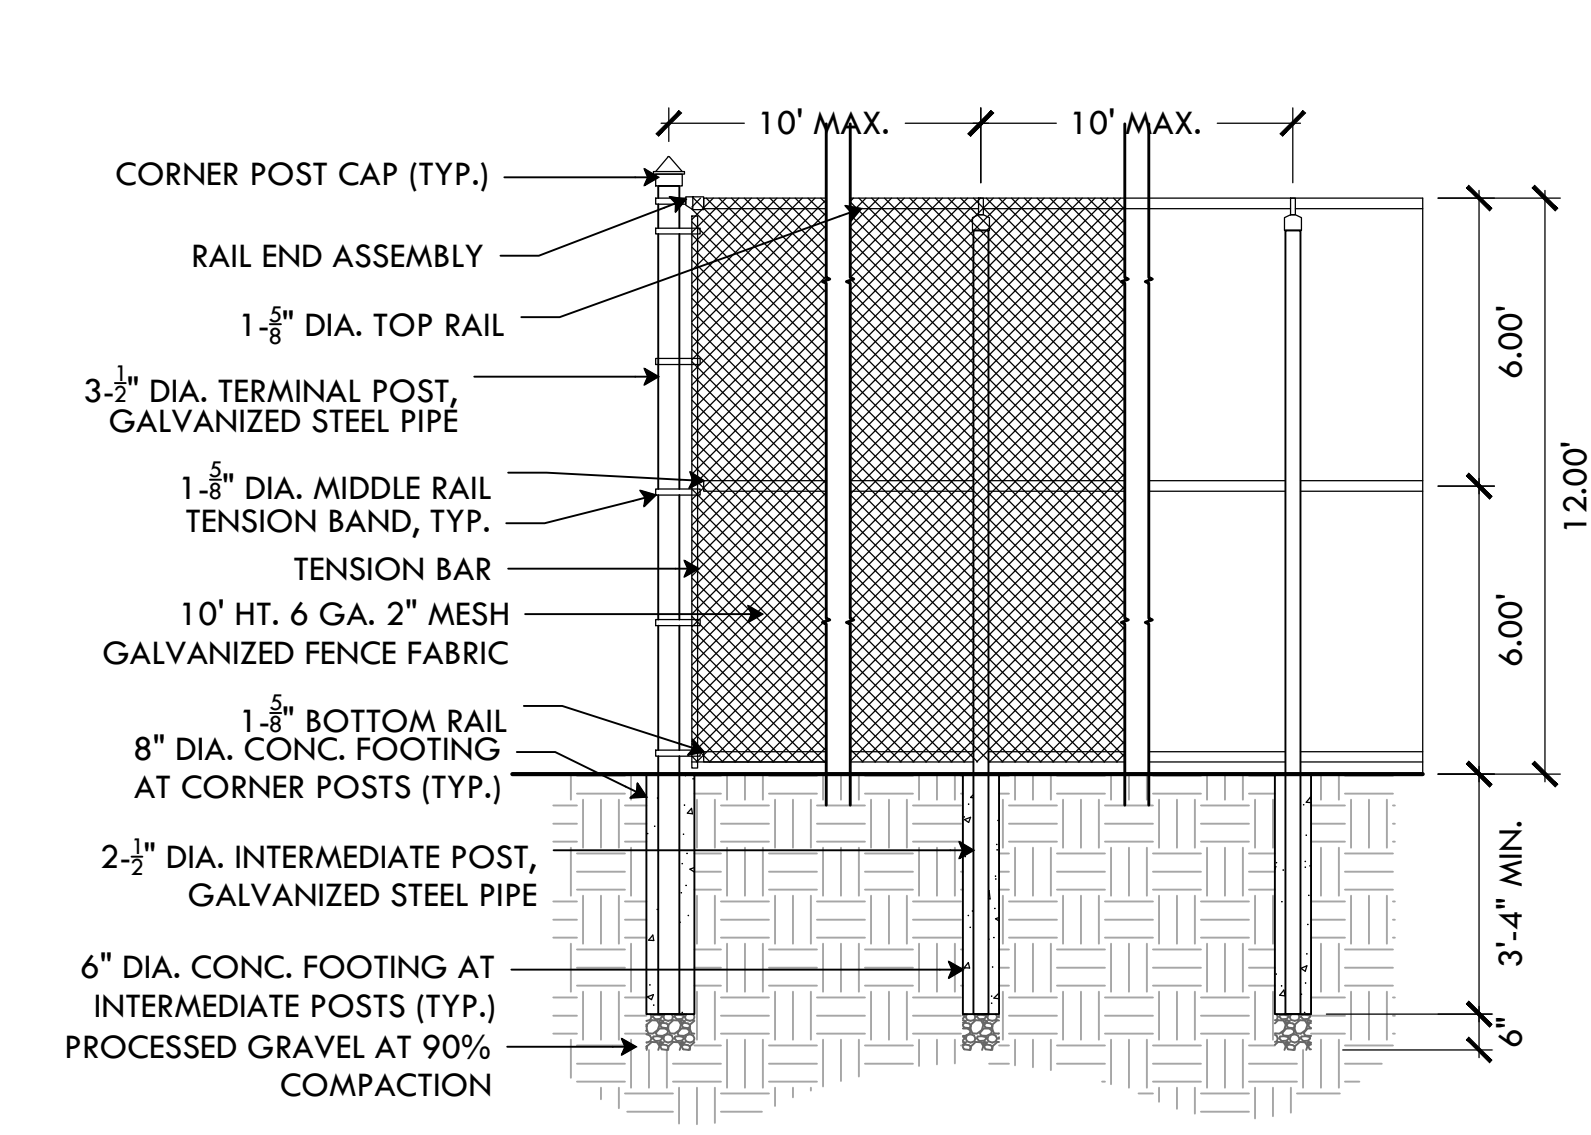


- NOTES:
1. FENCING TO BE TIED TO ALL RAILS & LINE POSTS W/ 9GA. WIRE SPACED AT 12"
 2. BRACE ALL CORNERS & TERMINAL POSTS W/ 1-3/4\"/>

23 12' HT. CHAIN LINK FENCE
NTS

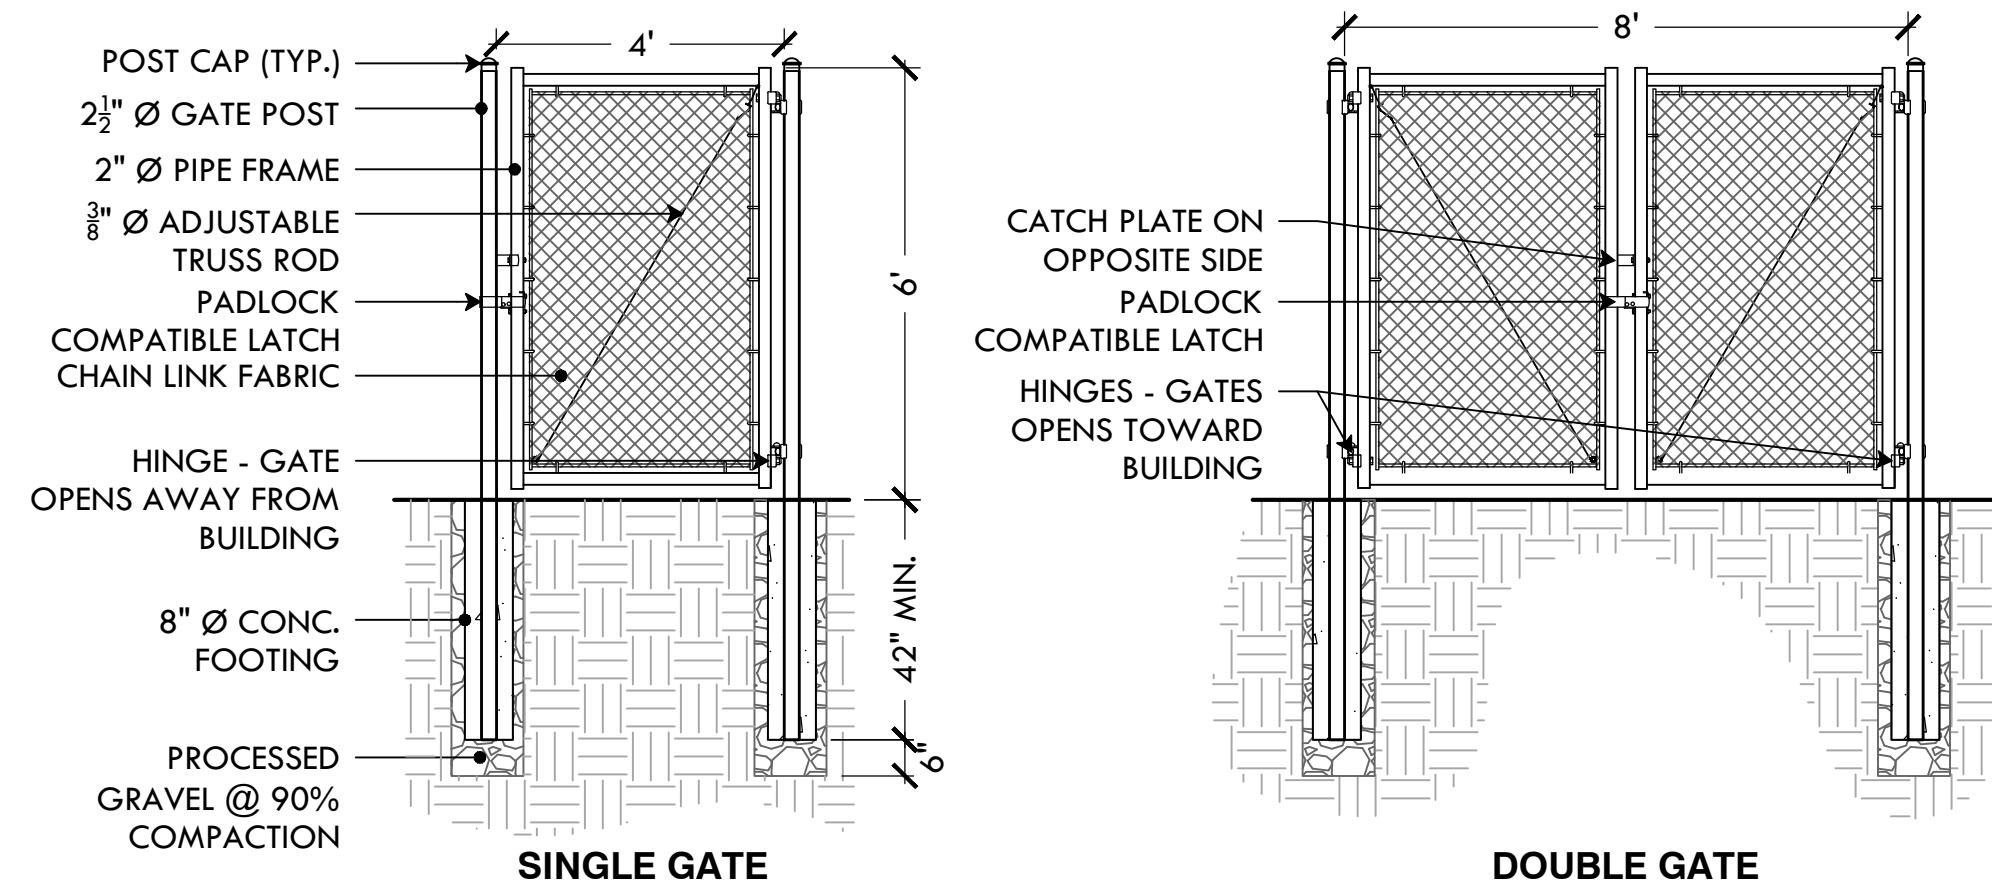


- NOTES:
1. FENCING TO BE TIED TO TOP RAILS & LINE POSTS W/ 9GA. WIRE SPACED AT 12"
 2. BRACE ALL CORNERS & TERMINAL POSTS W/ 1-3/4\"/>

24 4' WIDE CHAIN LINK GATE
NTS

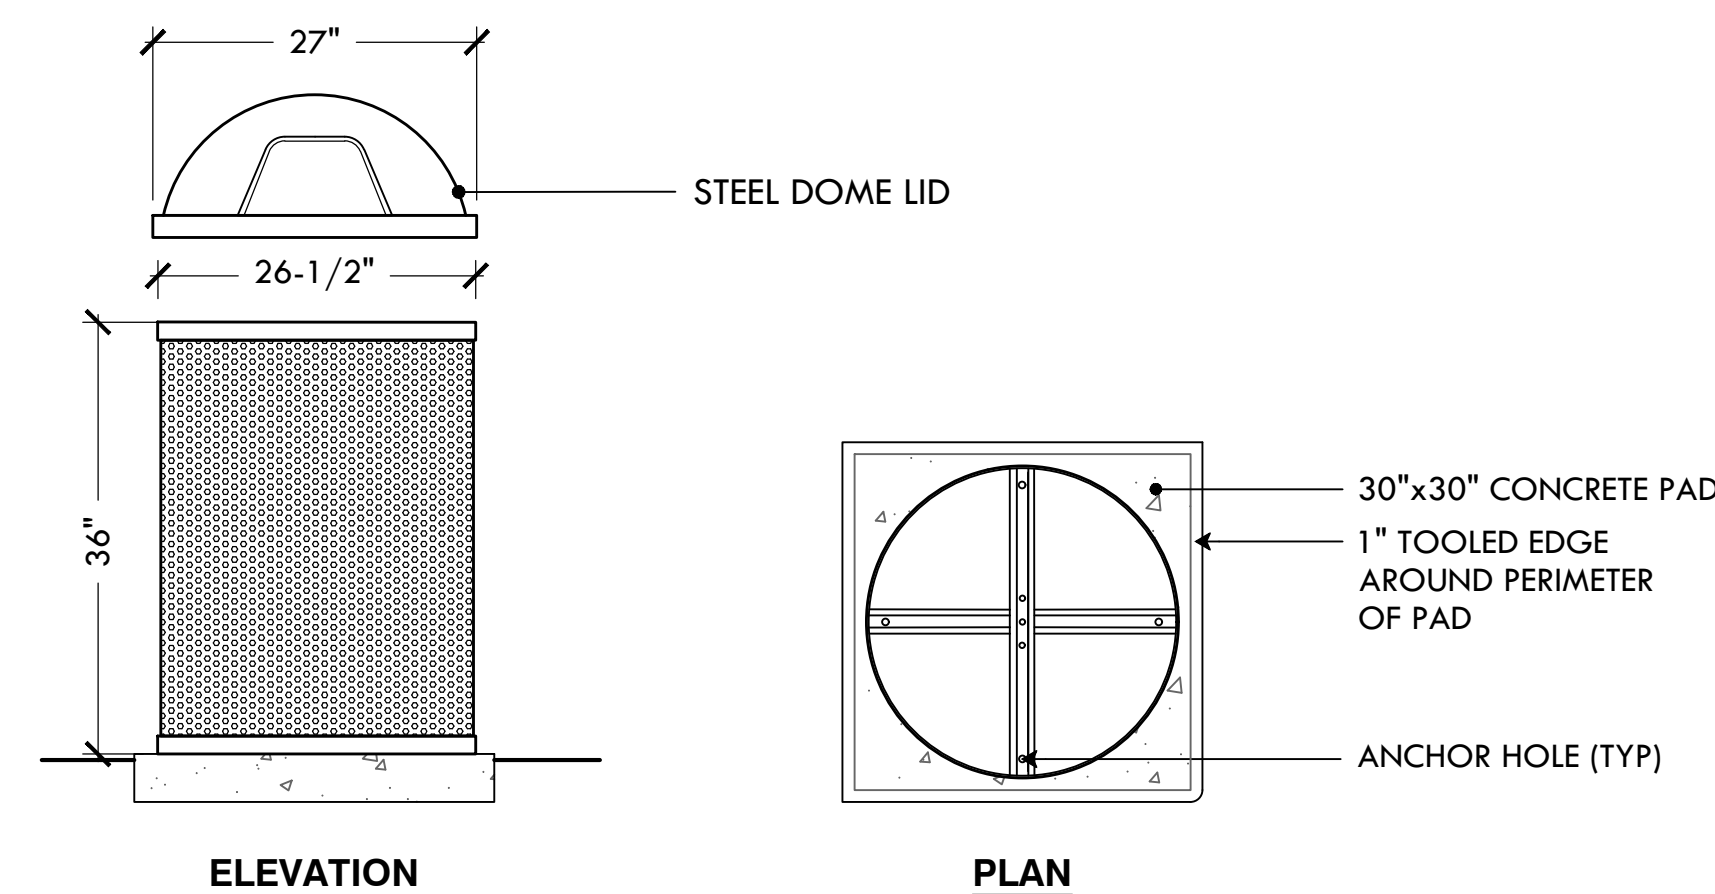


- NOTES:
1. SEE DETAIL 7, SHEET L-8 FOR CONCRETE PAD.
 2. UNIT SHOULD BE SECURED TO CONCRETE PAD USING THE FOUR (4) ANCHOR HOLES.
 3. MODEL#: CN-R/R-55: PILOT ROCK 55 GAL. ROUND PERFORATED STEEL TRASH RECEPTACLE. COLOR: BLACK, MATERIAL: STEEL.

25 ADD ALT #1: 55-GAL TRASH RECEPTACLE
NTS

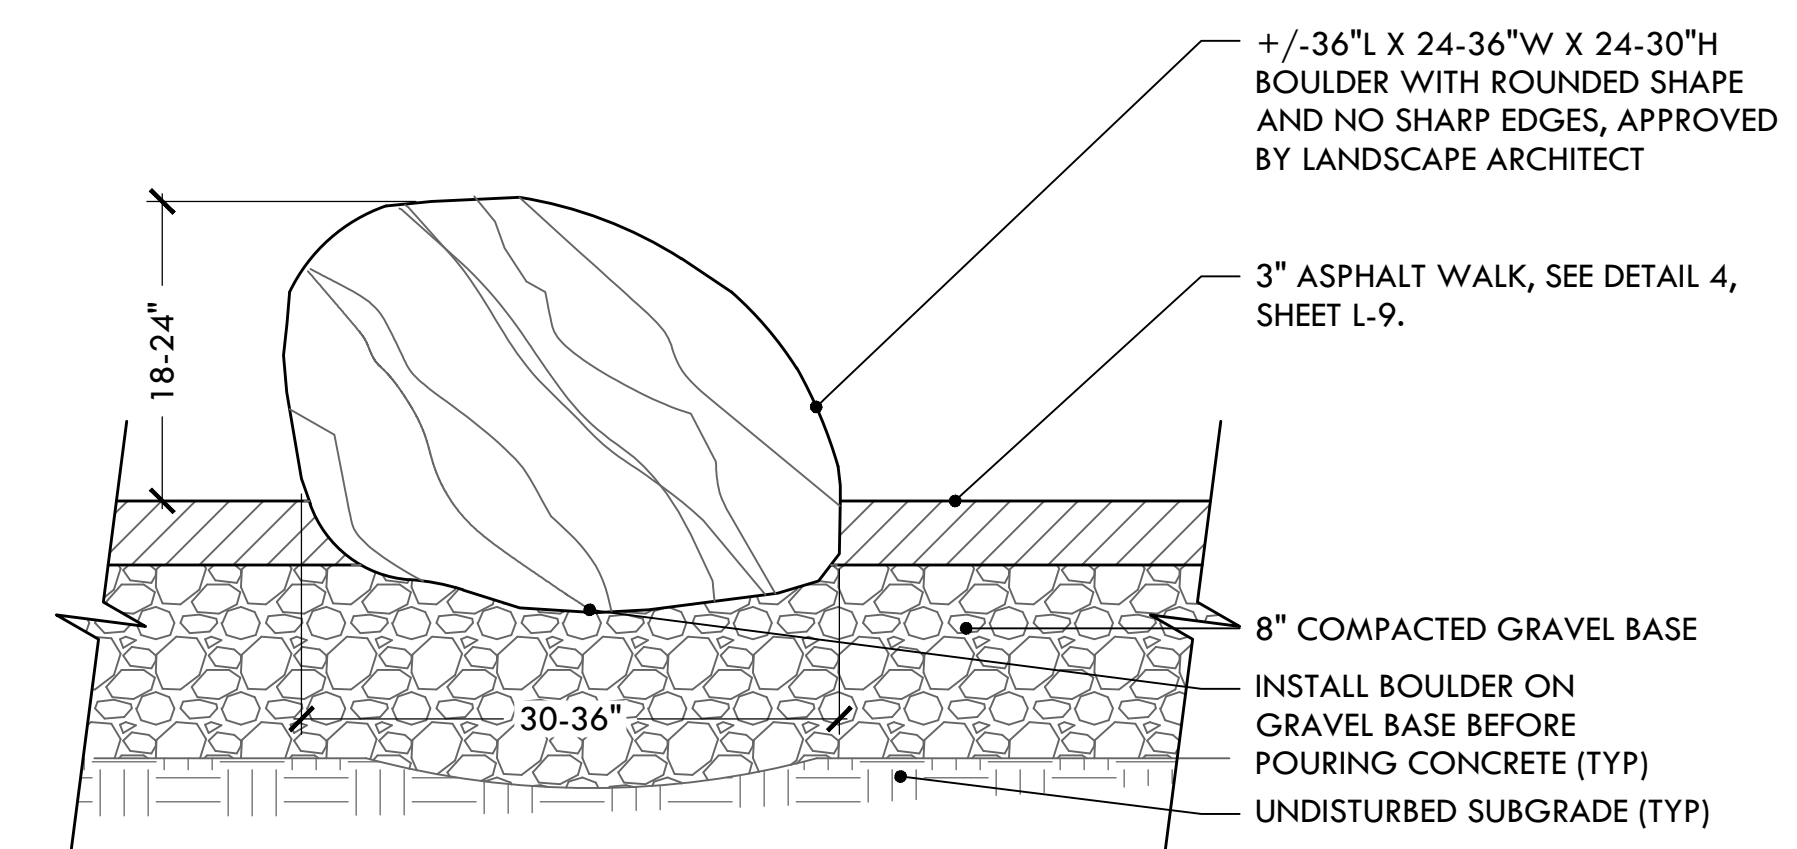


BOULDER QUANTITY: 5

26 ADD ALT #4: LANDSCAPE BOULDERS IN ASPHALT
NTS

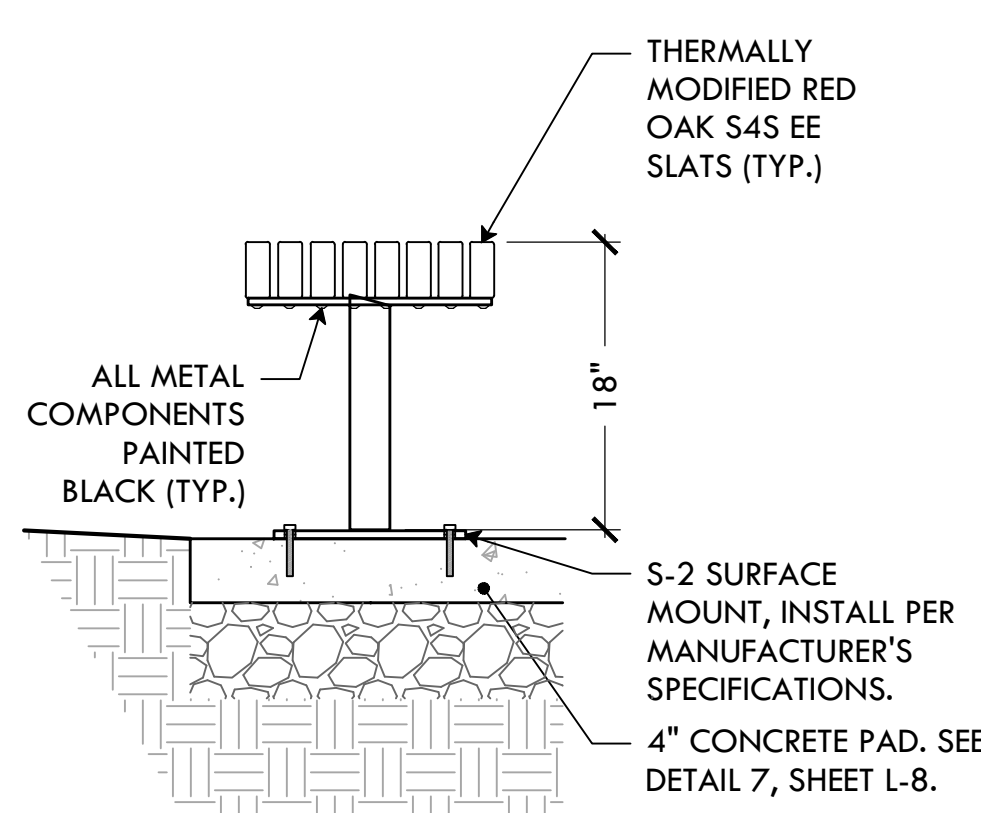


27 ADD ALT #5: 6' BACKLESS BENCH ON CONC. PAD
NTS

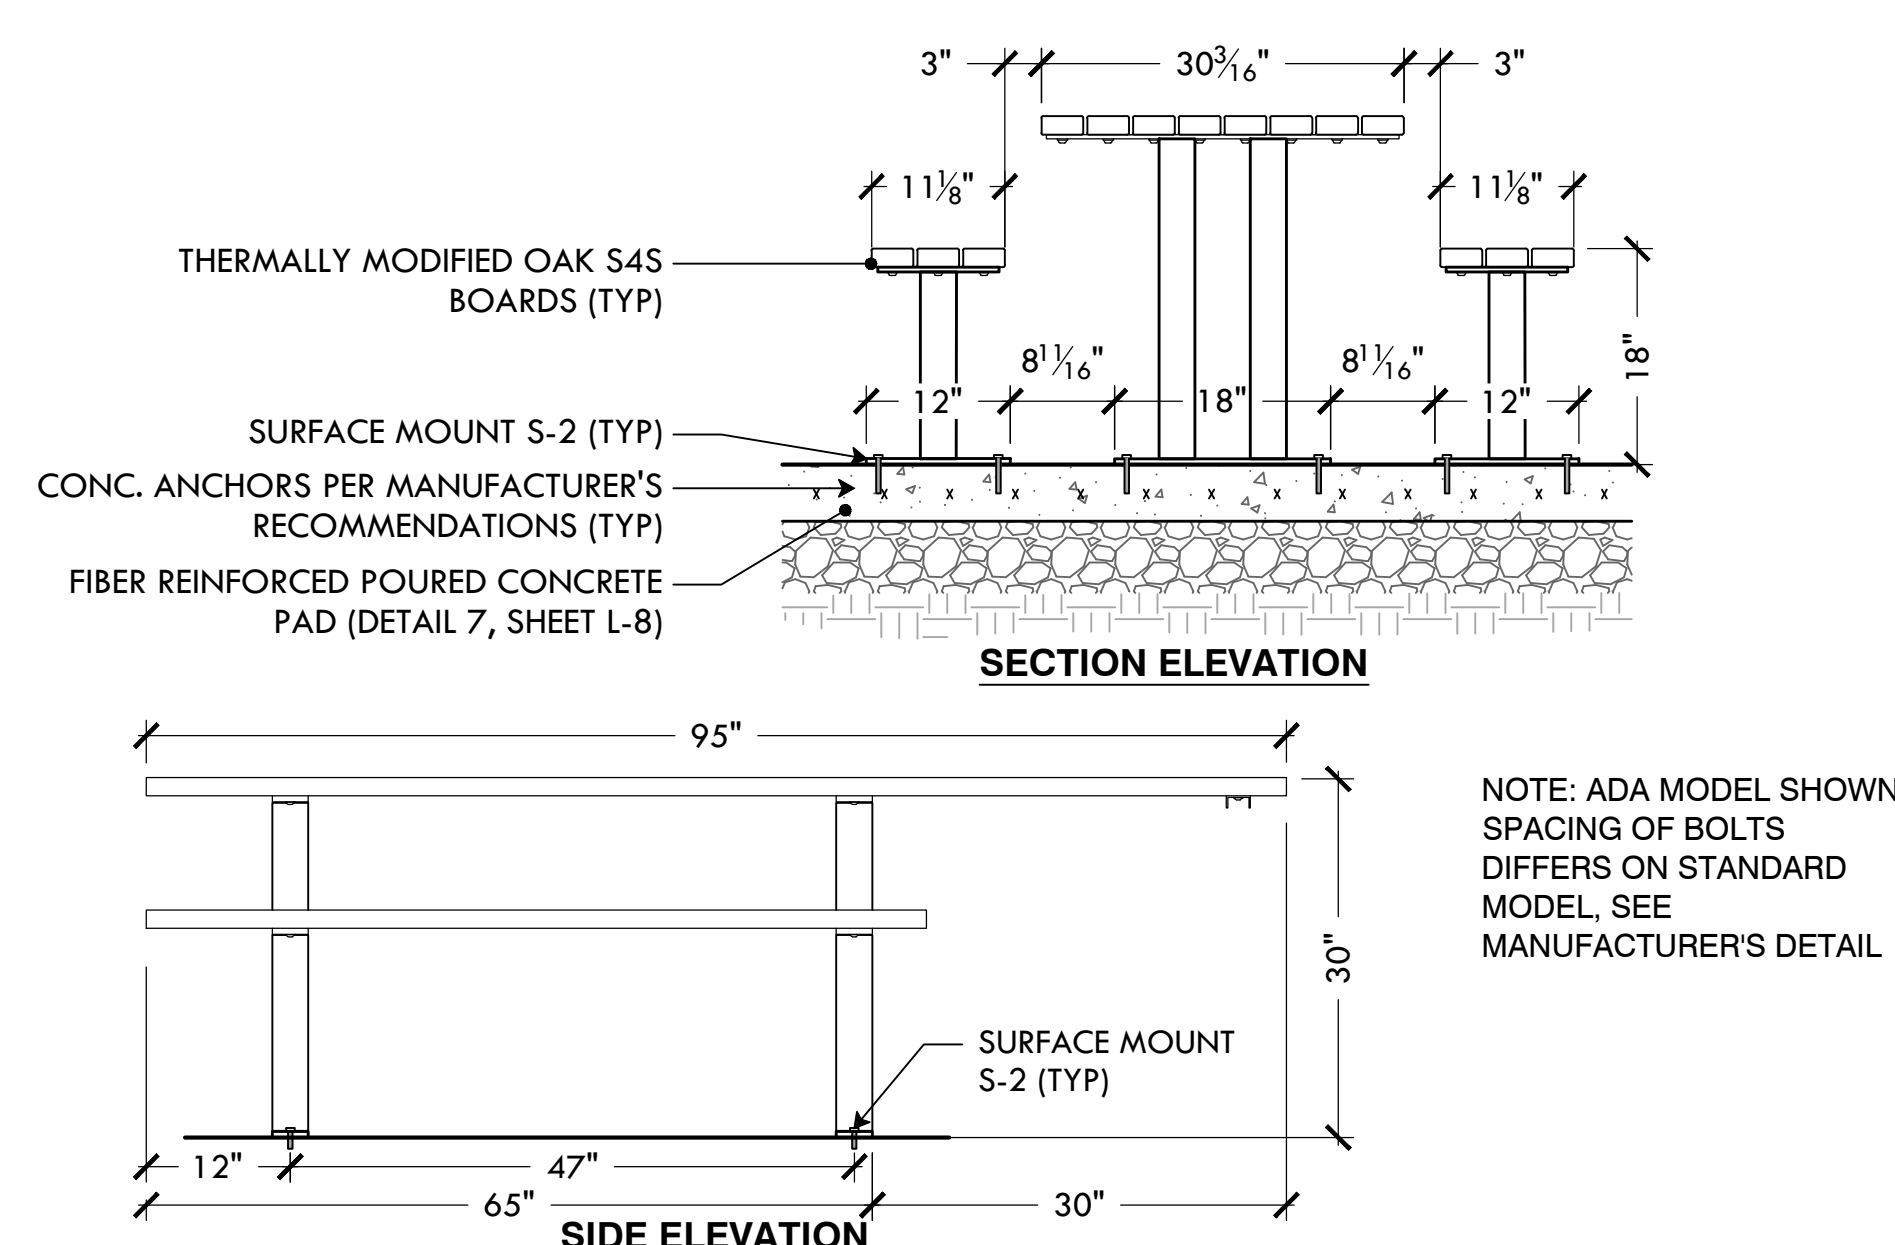


NOTE: ADA MODEL SHOWN, SPACING OF BOLTS DIFFERS ON STANDARD MODEL. SEE MANUFACTURER'S DETAIL

28 ADD ALT #6: 6' PICNIC TABLE & 8' ADA PICNIC TABLE ON CONC. PAD
NTS

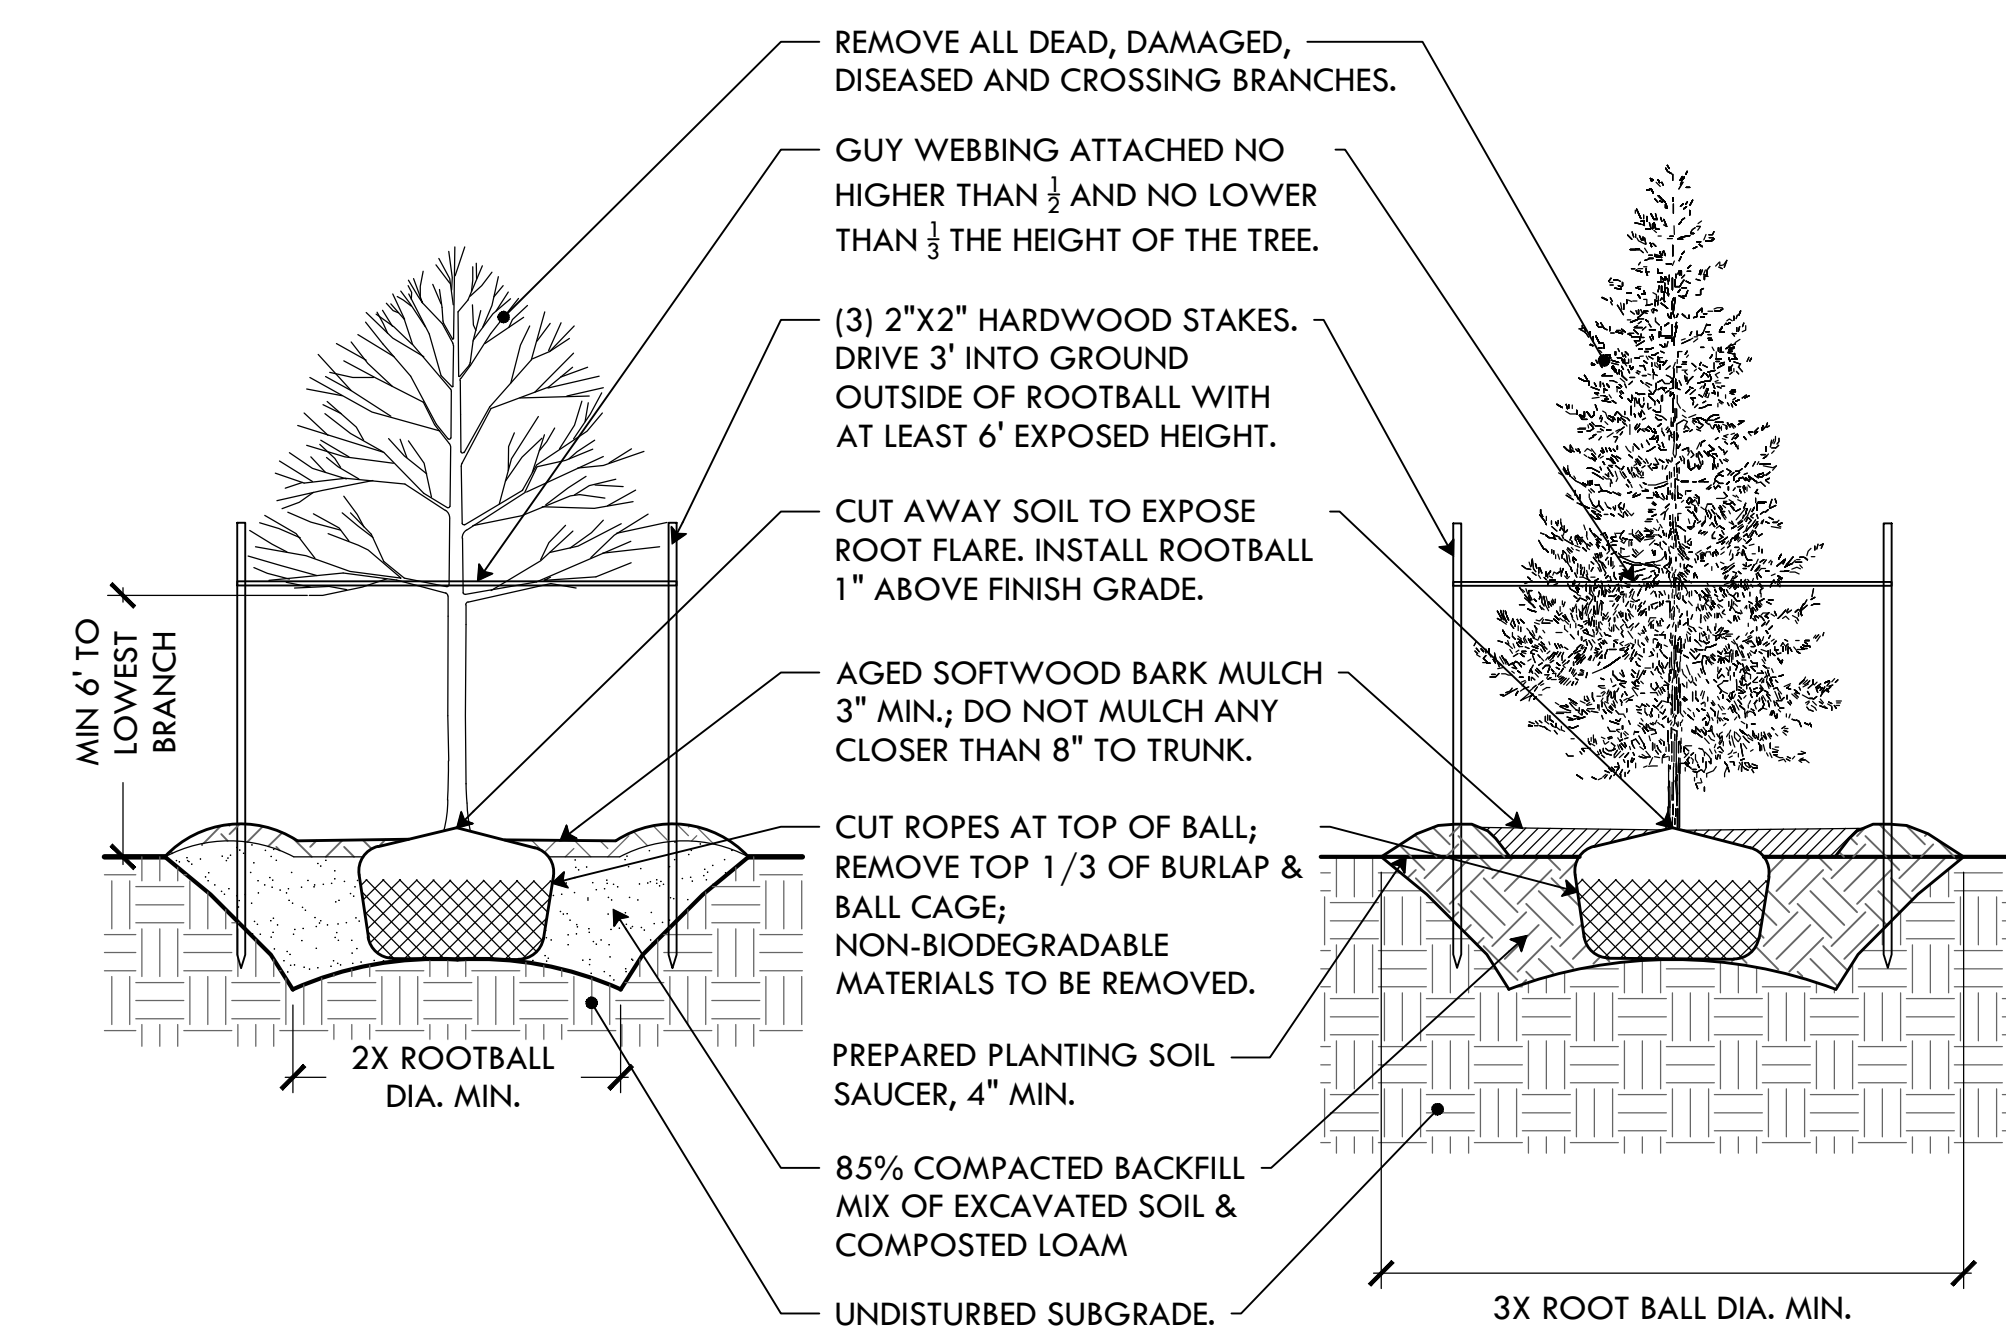

29 ADD ALT #8: DECIDUOUS & EVERGREEN TREE PLANTING
NTS

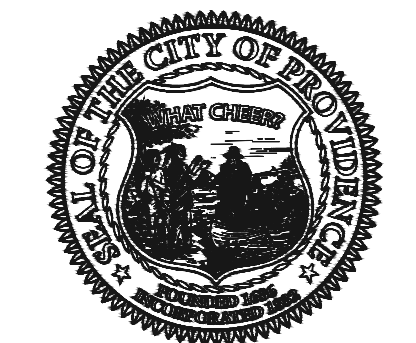

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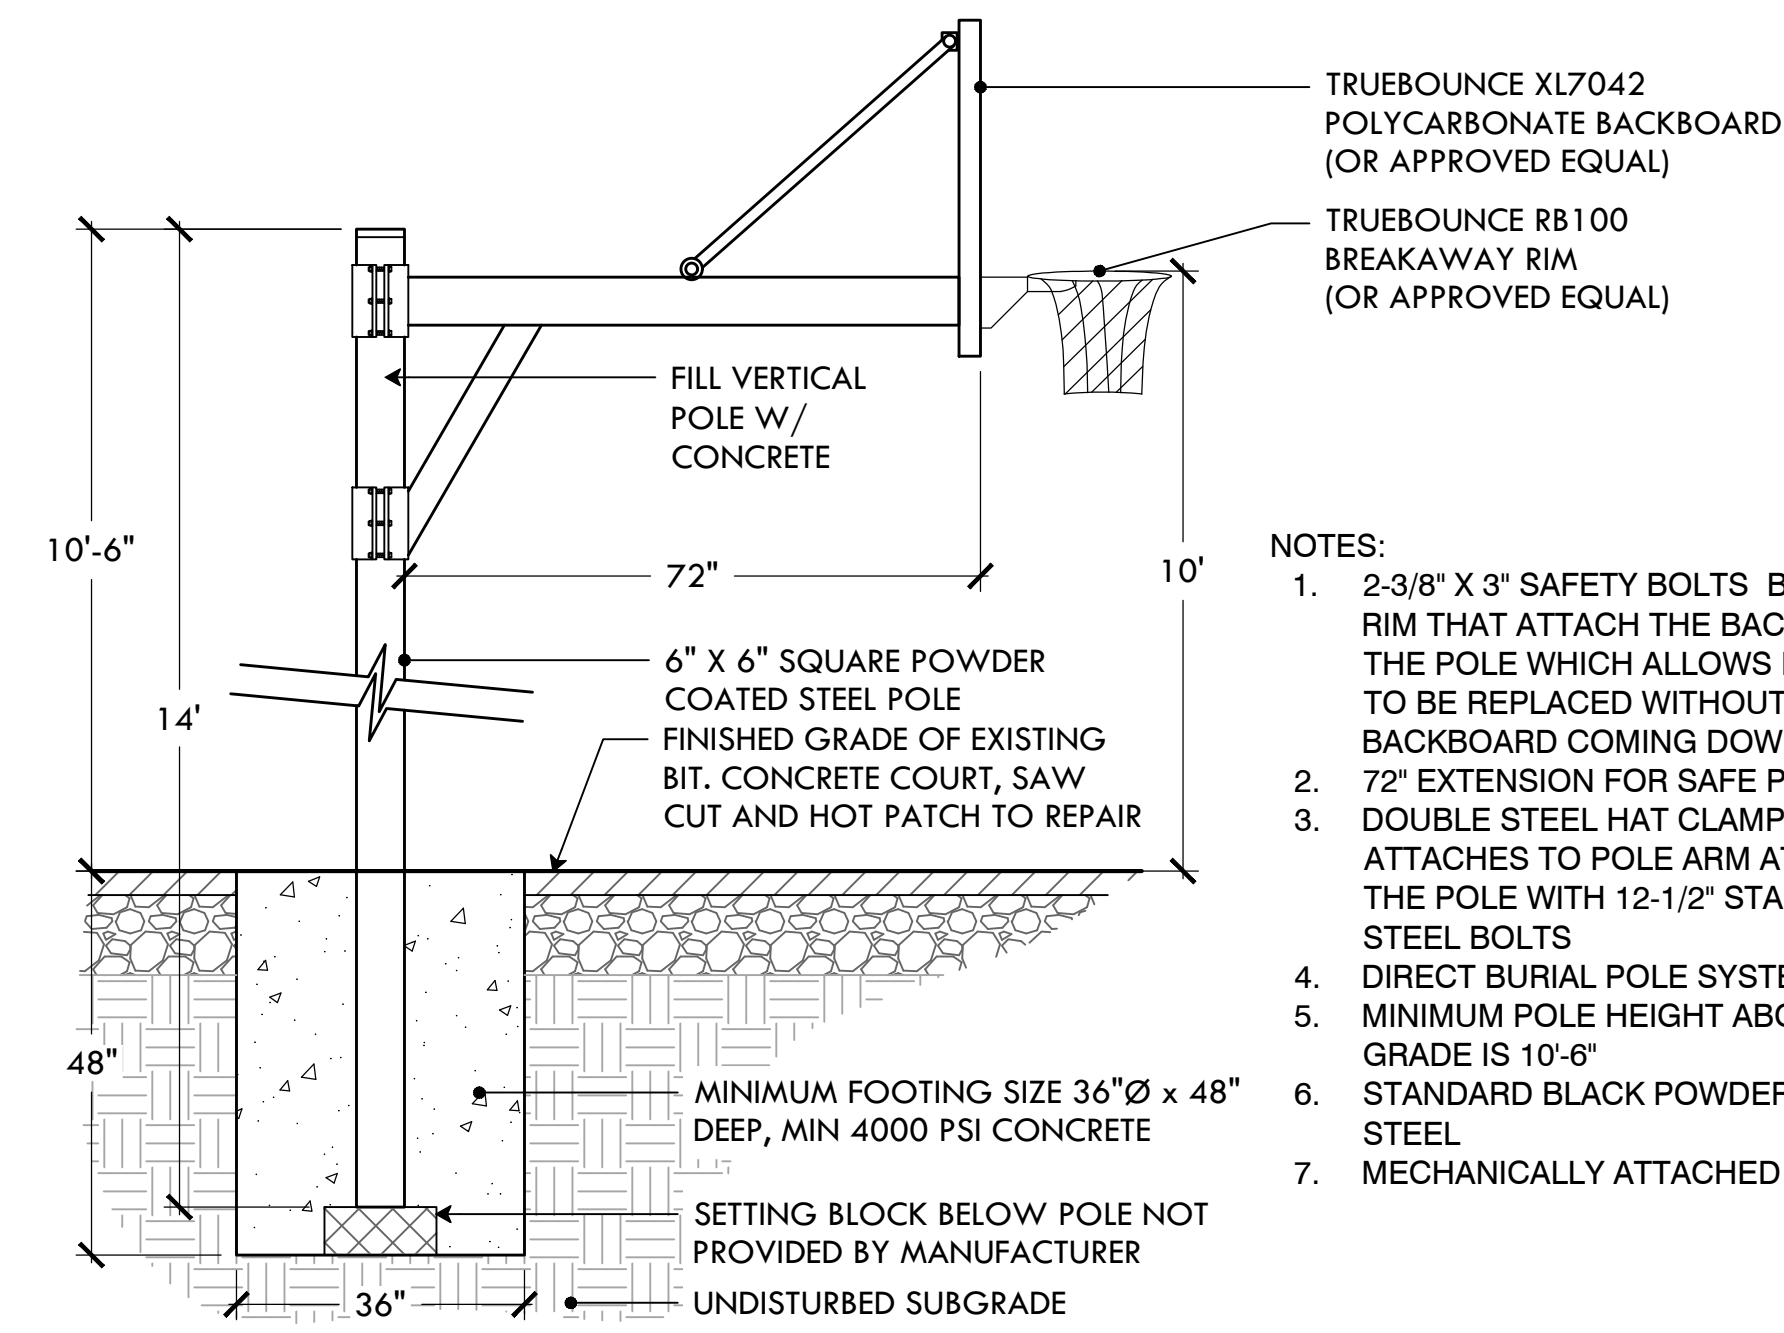
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DRAWING INFO
DATE ISSUED: 01/16/25
PROJECT NO: GSPK.24.01
DRAWN BY: SH, II
CHECKED BY: MG
SHEET TITLE
Construction Details 4


L-11

11 OF 19


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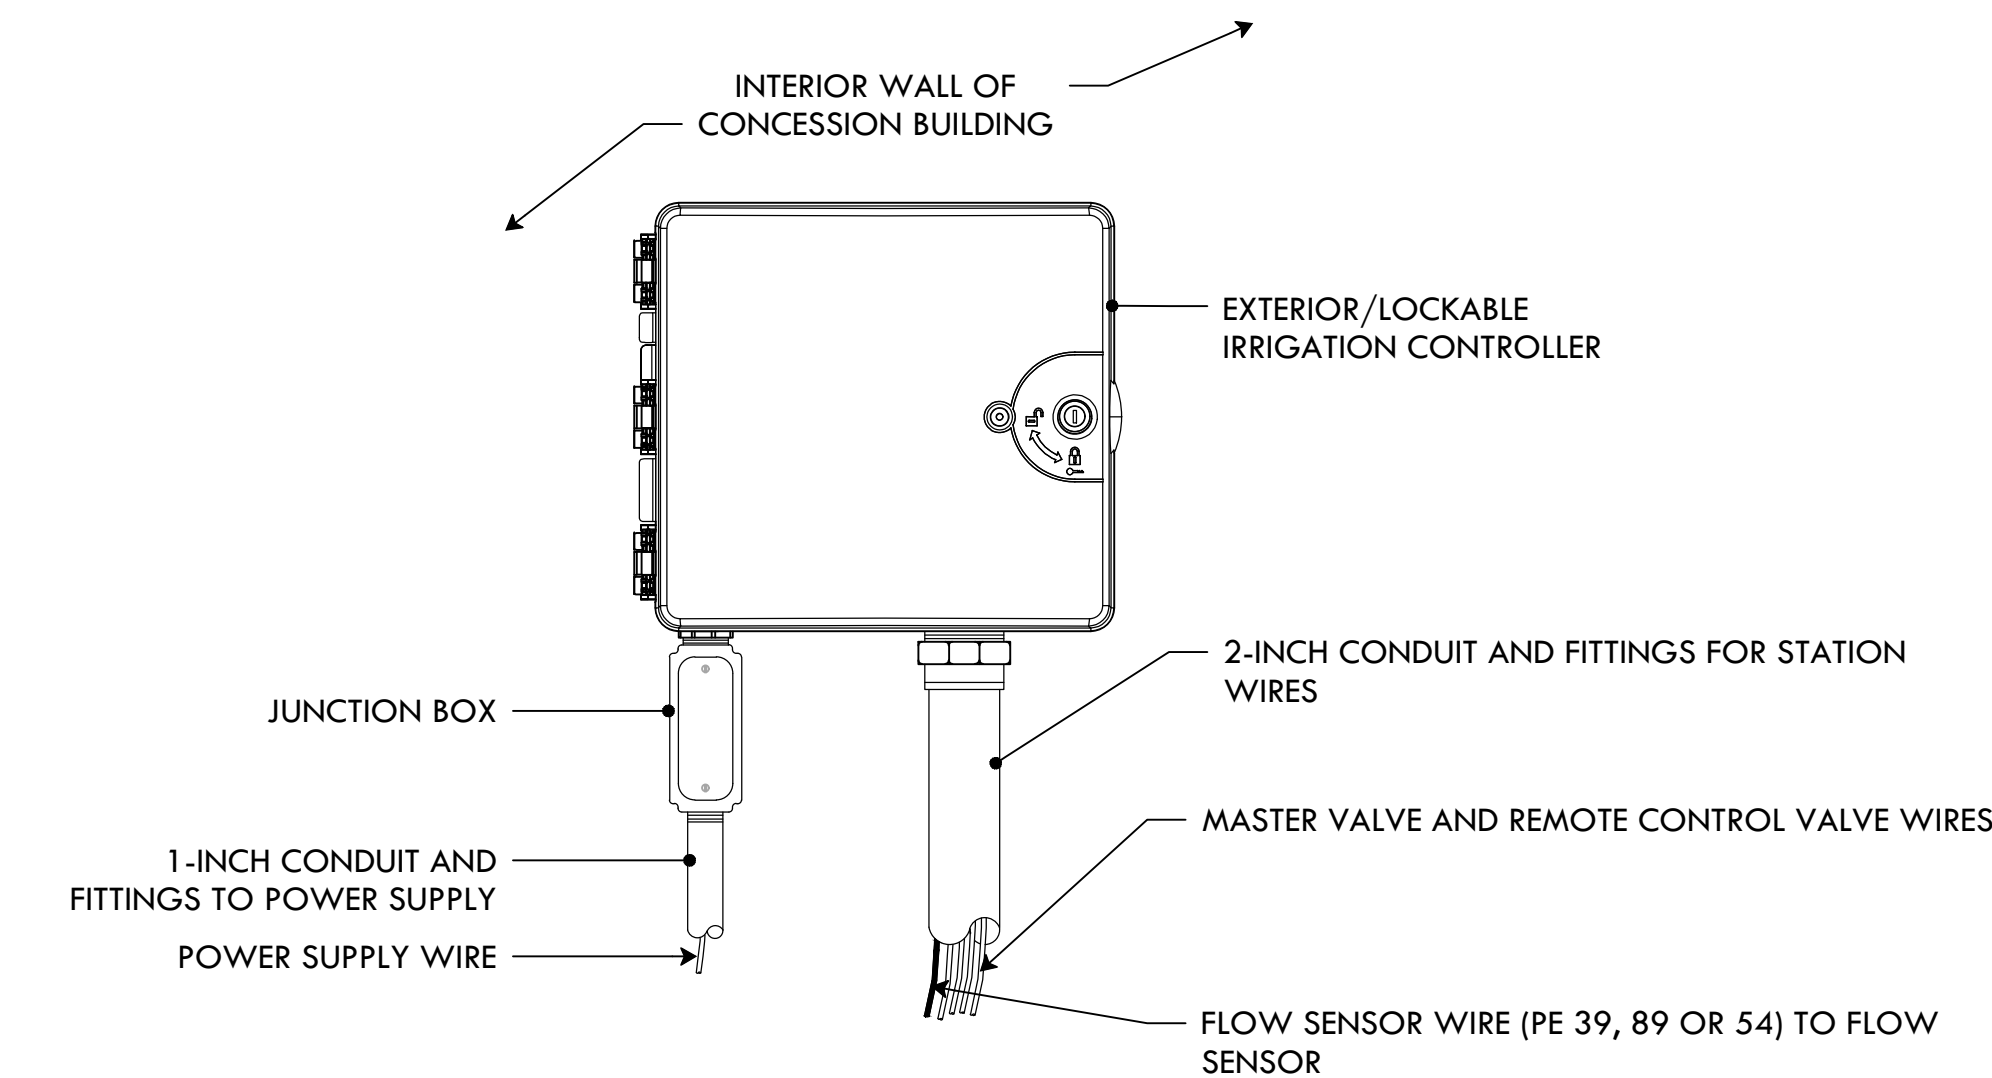
30 ADD ALT #12: TRUEBOUNCE BASKETBALL POST, BACKBOARD, & RIM




31 RAINBIRD WIRELESS SENSOR

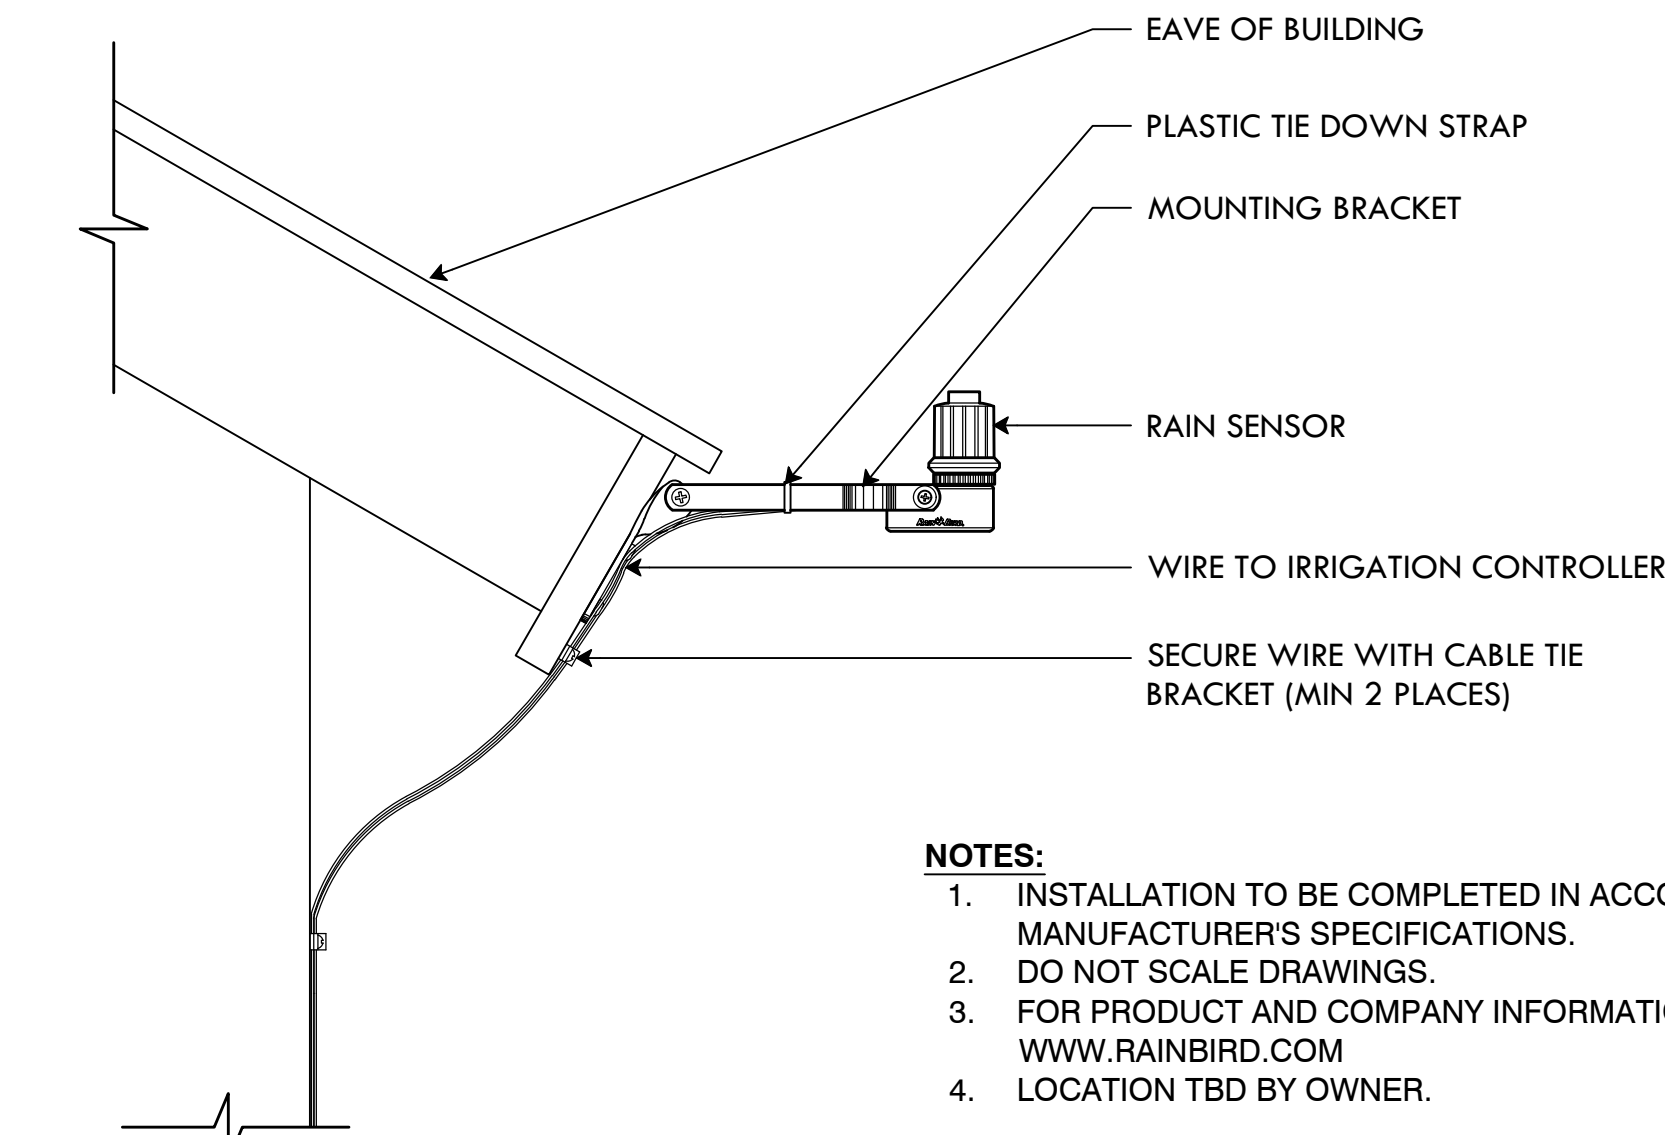


32 RAINBIRD REMOTE CONTROL VALVE

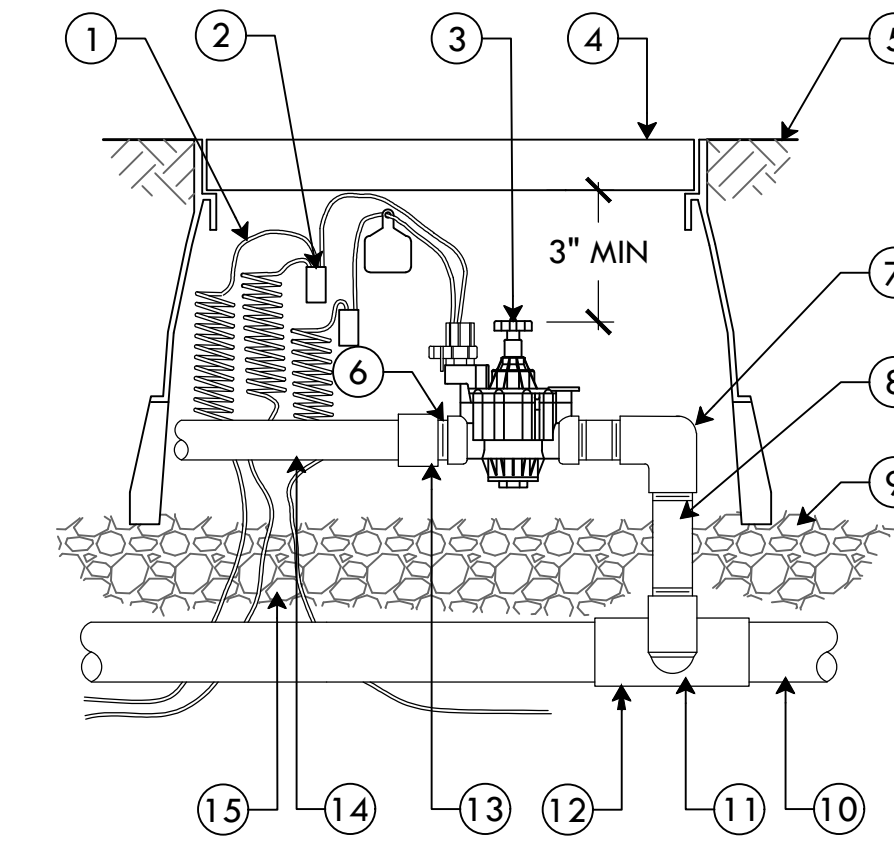


33 IRRIGATION (EXTERIOR) CONTROLLER

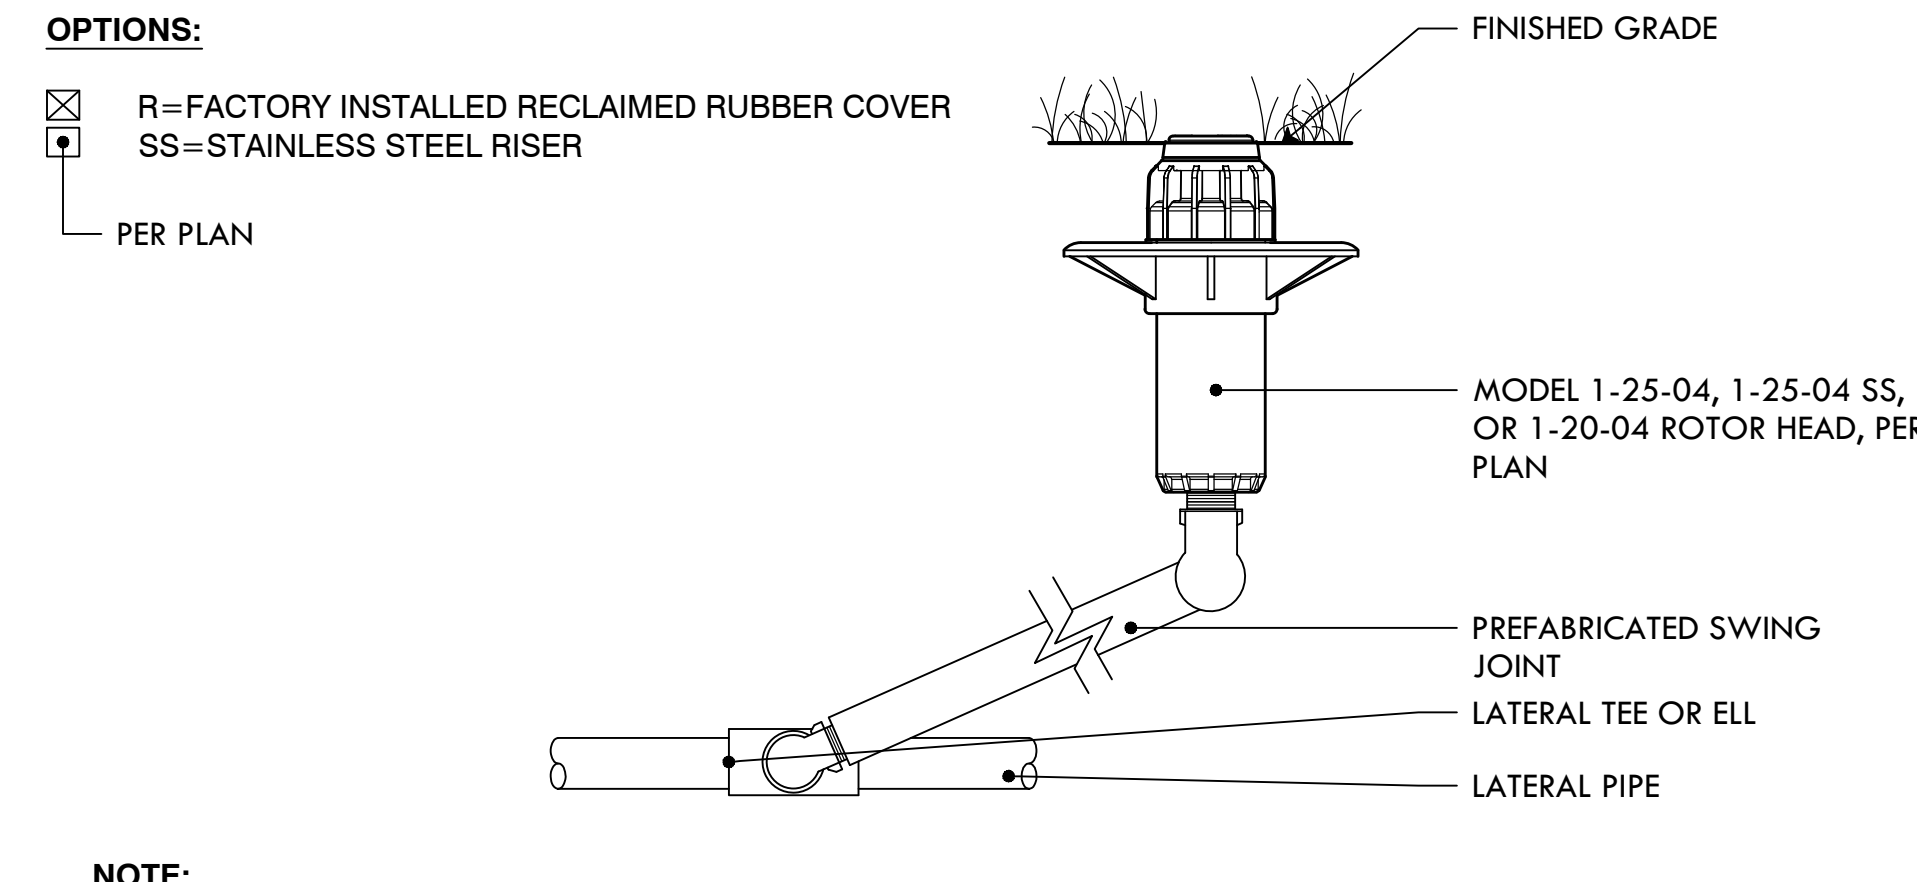


34 HUNTER ROTOR

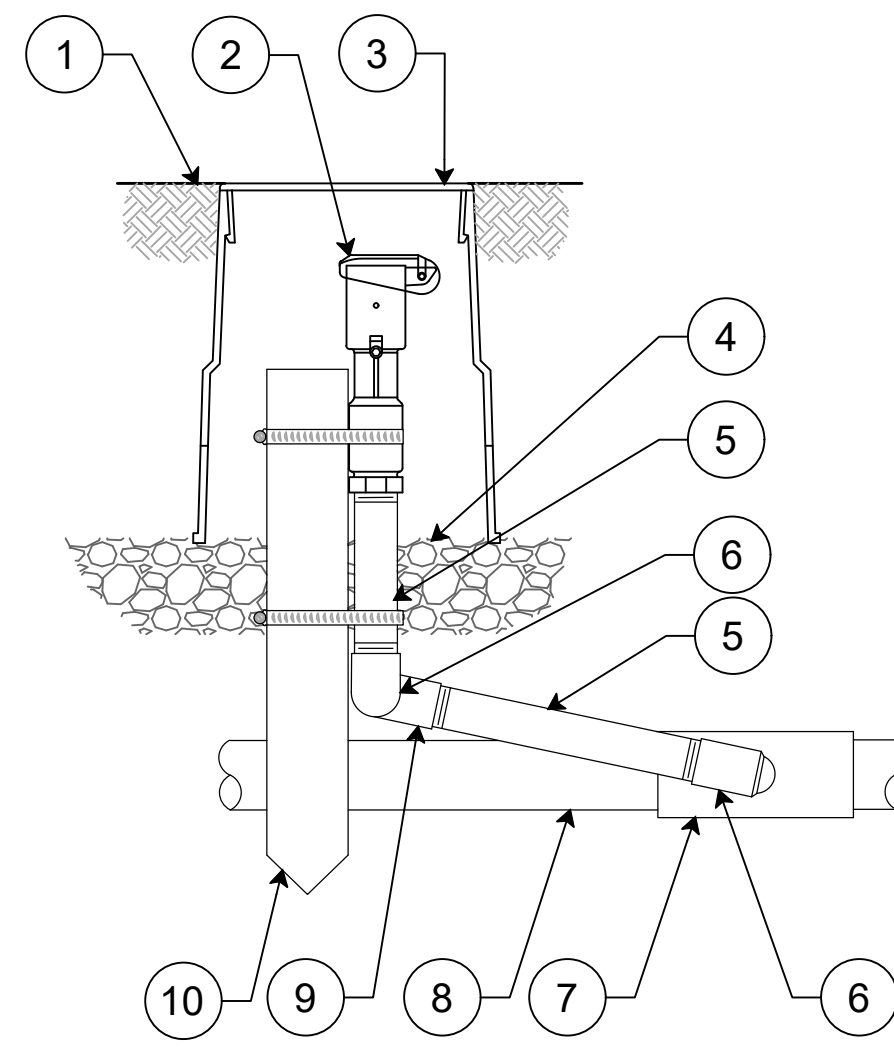

35 RAINBIRD QUICK COUPLING VALVE

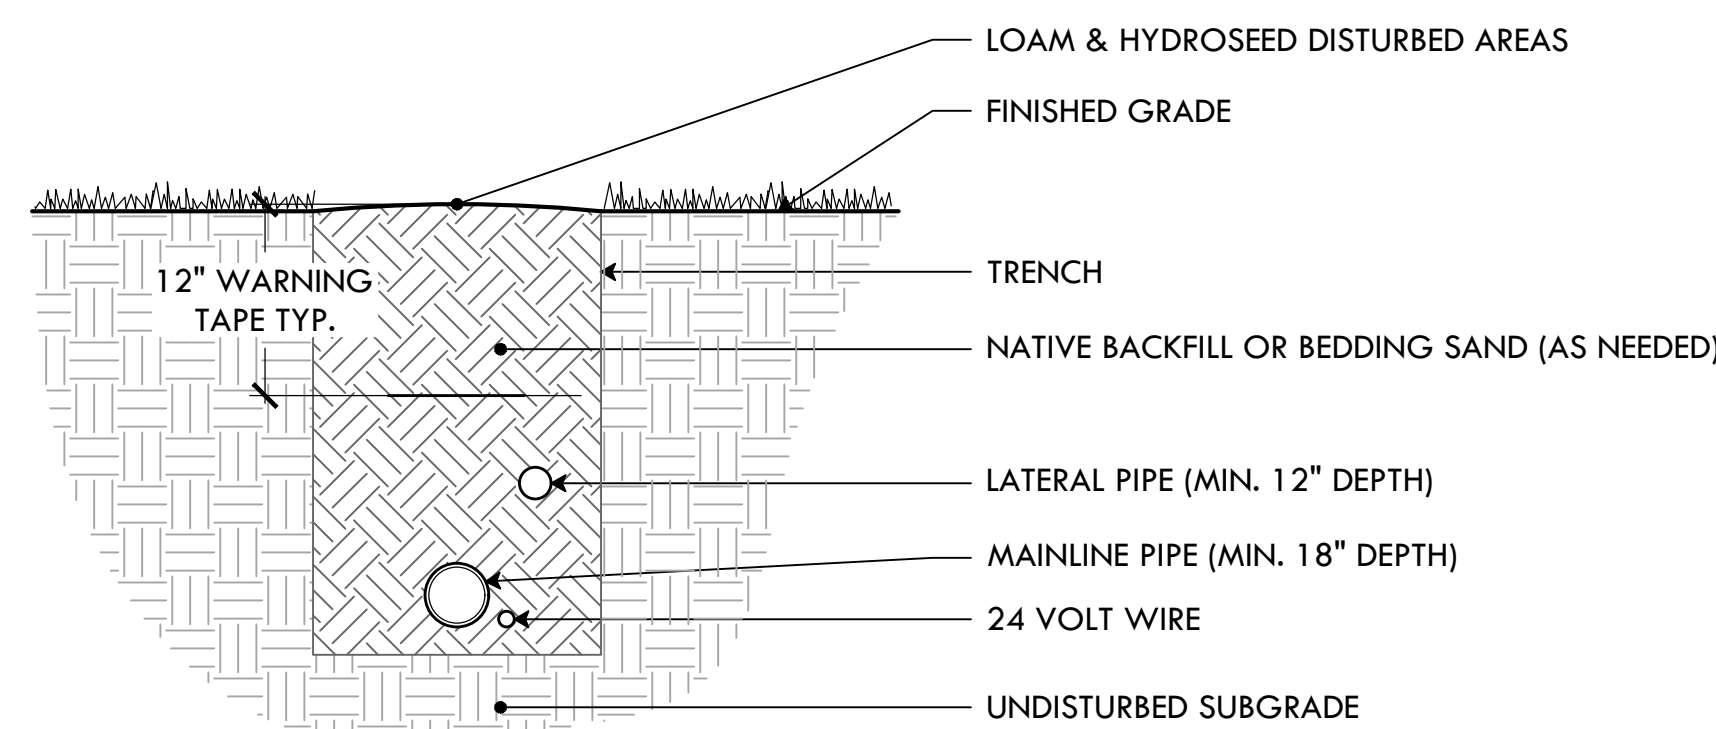

36 TRENCH AND WIRE

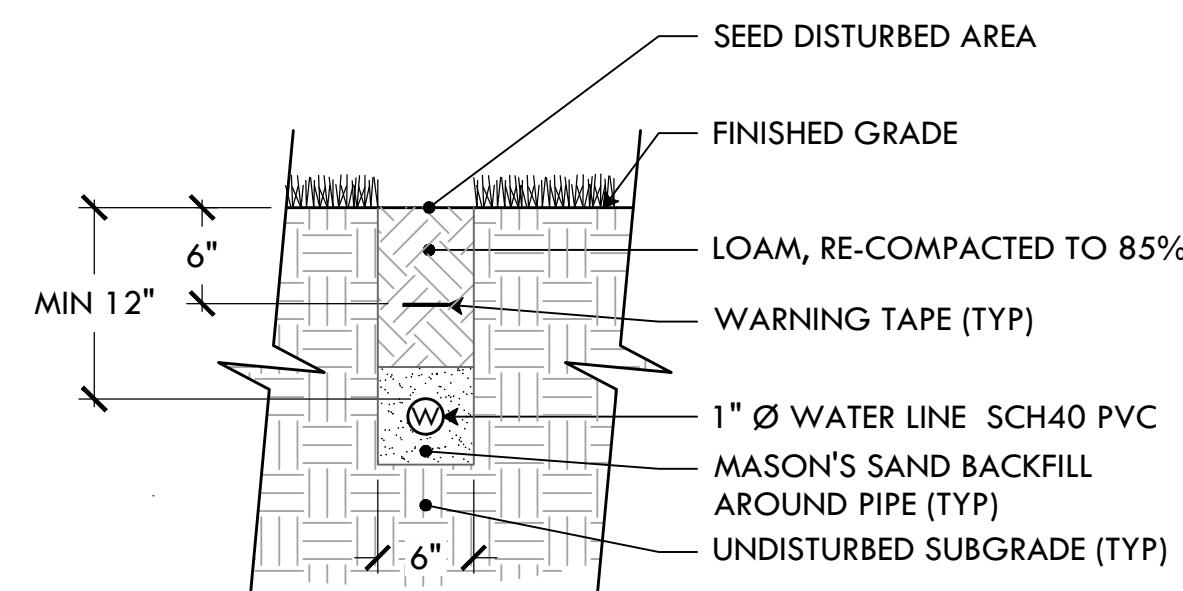

37 IRRIGATION CONDUIT



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PROVIDENCE, RI 02905



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87 Fremont St
Providence, RI 02906

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DRAWING INFO
DATE ISSUED: 01/16/25
PROJECT NO: GSPK.24.01
DRAWN BY: SH, II
CHECKED BY: MG

SHEET TITLE
Construction Details 5 & Irrigation Details L-12

Gano Park Softball

Providence, RI

Lighting System

Pole/Fixture Summary						
Pole ID	Pole Height	Mtg Height	Fixture Qty	Luminaire Type	Load	Circuit
A1-A2	60'	60'	1	TLC-LED-1200	1.17 kW	A
		60'	2	TLC-LED-900	1.76 kW	A
		16'	1	TLC-BT-575	0.57 kW	A
B1-B2	60'	60'	1	TLC-LED-1500	1.41 kW	A
		60'	3	TLC-LED-1200	3.51 kW	A
		16'	1	TLC-BT-575	0.57 kW	A
4			18		18.00 kW	

Circuit Summary			
Circuit	Description	Load	Fixture Qty
A	Baseball 1	18.00 kW	18


Fixture Type Summary							
Type	Source	Wattage	Lumens	L90	L80	L70	Quantity
TLC-BT-575	LED 5700K - 75 CRI	575W	52,000	>120,000	>120,000	>120,000	4
TLC-LED-1200	LED 5700K - 75 CRI	1170W	150,000	>120,000	>120,000	>120,000	8
TLC-LED-1500	LED 5700K - 75 CRI	1410W	181,000	>120,000	>120,000	>120,000	2
TLC-LED-900	LED 5700K - 75 CRI	880W	104,000	>120,000	>120,000	>120,000	4

Single Luminaire Amperage Draw Chart							
Driver Specifications (.90 min power factor)	Line Amperage Per Luminaire (max draw)						
	208 (60)	220 (60)	240 (60)	277 (60)	347 (60)	380 (60)	480 (60)
Single Phase Voltage							
TLC-LED-1500	8.4	7.9	7.3	6.3	5.0	4.6	3.6
TLC-LED-1200	6.9	6.5	6.0	5.2	4.2	3.8	3.0
TLC-LED-900	5.2	4.9	4.5	3.9	3.1	2.9	2.3
TLC-BT-575	3.3	3.2	2.9	2.5	2.0	1.8	1.5

Light Level Summary

Calculation Grid Summary								
Grid Name	Calculation Metric	Illumination Ave					Circuits	Fixture Qty
		Ave	Min	Max	Max/Min	Ave/Min		
Softball 1 (Infield)	Horizontal Illuminance	50.94	32	59	1.86	1.60	A	18
Softball 1 (Outfield)	Horizontal Illuminance	31.76	20	44	2.17	1.57	A	18
Softball 1 Spill @ 3ft.	Horizontal Illuminance	0.0191	0.00	0.06	107.315	33.498	A	18
Softball 1 Spill @ 5ft.	Max Candela Metric	3105.8455	354.09	7489.06	21.150	8.771	A	18
Softball 1 Spill @ 5ft.	Max Vertical Illuminance Metric	0.0566	0.00	0.16	84.949	29.962	A	18
Softball 1 Spill @ 5ft.	True Max Vert Illuminance Metric	0.0563	0.00	0.16	101.277	36.528	A	18

From Hometown to Professional

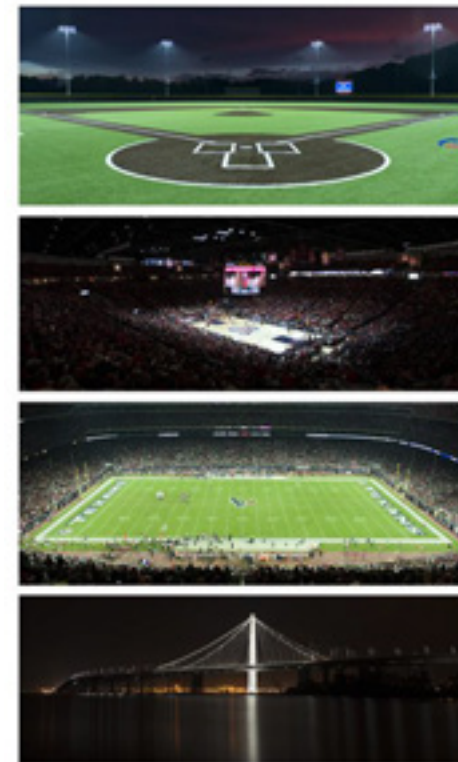


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Equipment List For Areas Shown

Pole				Luminaires				
QTY	LOCATION	SIZE	GRADE ELEVATION	ABOVE GRADE LEVEL	LUMINAIRE TYPE	QTY/POLE	THIS GRID	OTHER GRIDS
2	A1-A2	60'	-	60'	TLC-LED-1200	1	1	0
				60'	TLC-LED-900	2	2	0
				15.5'	TLC-BT-575	1	1	0
2	B1-B2	60'	-	60'	TLC-LED-1200	3	3	0
				60'	TLC-LED-1500	1	1	0
				15.5'	TLC-BT-575	1	1	0
4	Totals					18	18	0

*Above Grade level relative to the field

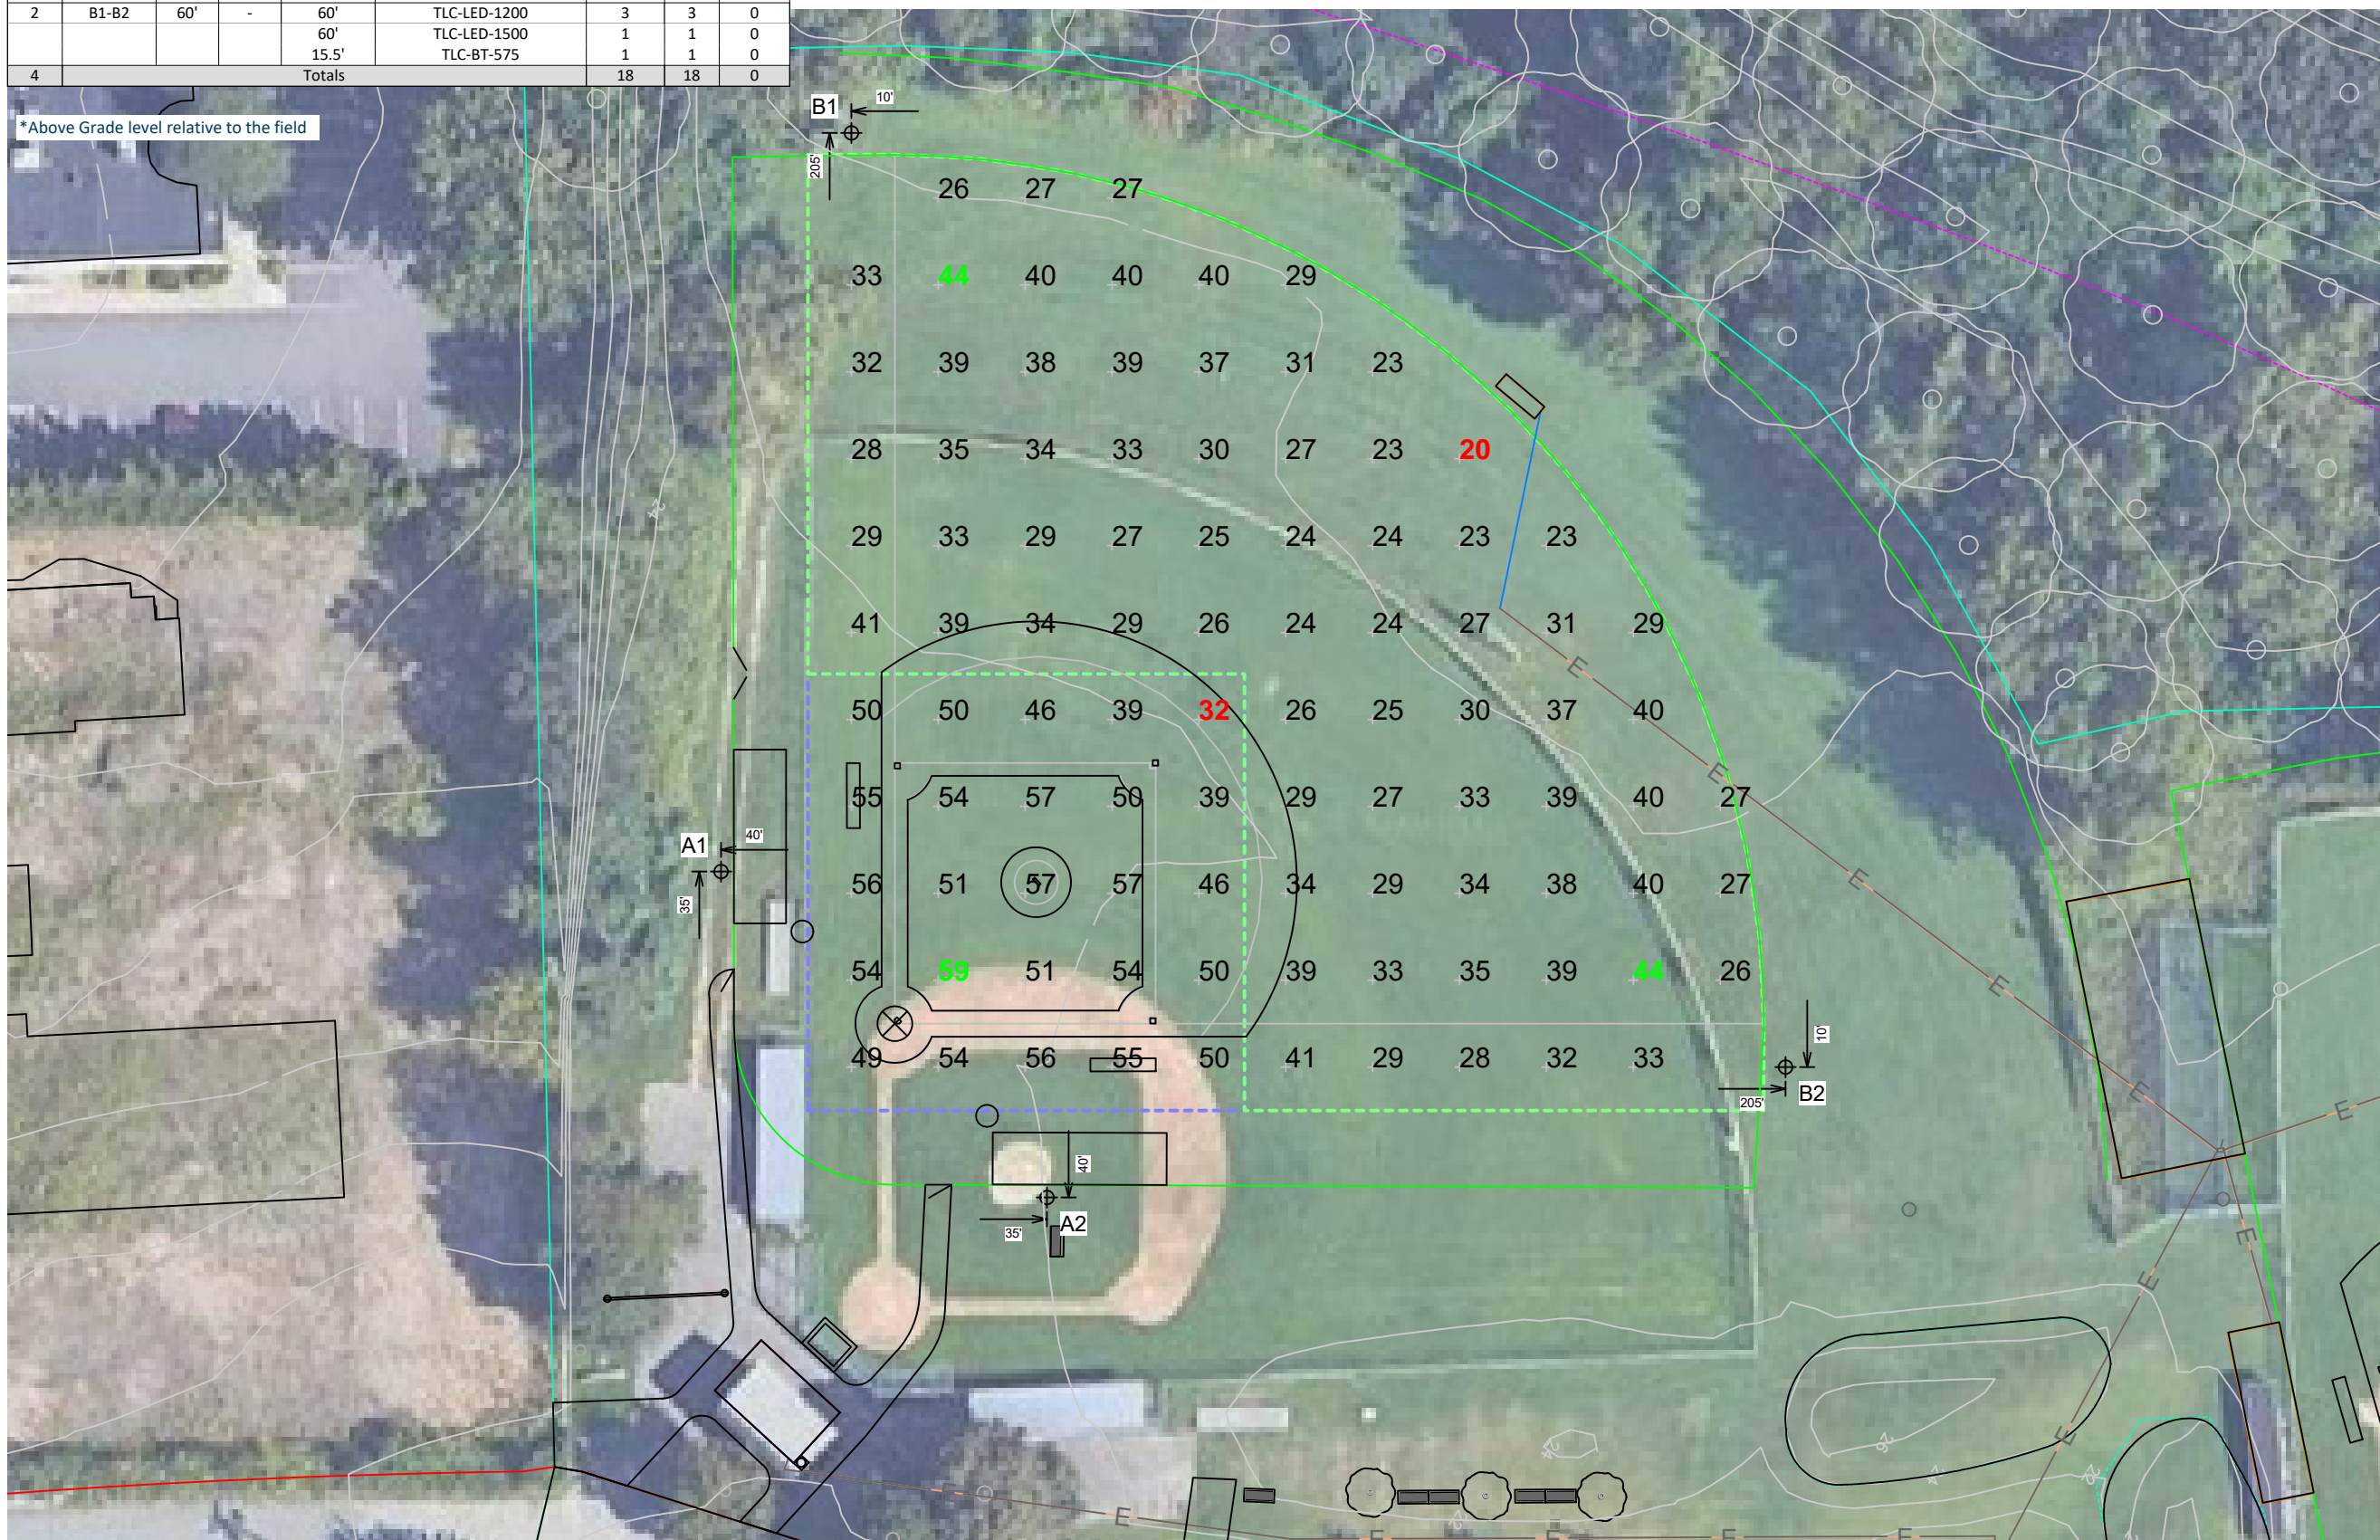

Gano Park Softball

Providence, RI

Grid Summary	
Name	Softball 1
Size	200'/200'/200' - basepath 60'
Spacing	20.0' x 20.0'
Height	3.0' above grade


	MAINTAINED HORIZONTAL FOOTCANDLES	
	Infield	Outfield
Guaranteed Average	50	30
Scan Average	50.94	31.76
Maximum	59	44
Minimum	32	20
Avg/Min	1.60	1.57
Guaranteed Max/Min	2	2.5
Max/Min	1.86	2.17
UG (adjacent pts)	1.30	1.66
CU	0.66	
No. of Points	25	71
LUMINAIRE INFORMATION		
Applied Circuits	A	
No. of Luminaires	18	
Total Load	18.00 kW	

Guaranteed Performance: The ILLUMINATION described above is guaranteed per your Musco Warranty document and includes a 0.95 dirt depreciation factor.

Field Measurements: Individual field measurements may vary from computer-calculated predictions and should be taken in accordance with IESNA RP-6-15.

Electrical System Requirements: Refer to Amperage Draw Chart and/or the "Musco Control System Summary" for electrical sizing.

Installation Requirements: Results assume ± 3% nominal voltage at line side of the driver and structures located within 3 feet (1m) of design locations.

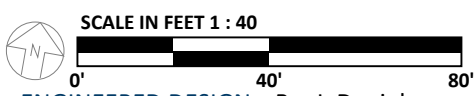

ENGINEERED DESIGN By: J. Danielson • File #237520E • 06-Jan-25

Pole location(s) ⊕ dimensions are relative to 0,0 reference point(s) ⊗



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ILLUMINATION SUMMARY

Gano Park Softball

Providence, RI

Grid Summary	
Name	Softball 1 Spill @ 3ft.
Spacing	30.0'
Height	3.0' above grade


Illumination Summary	
INITIAL HORIZONTAL FOOTCANDLES	
Entire Grid	0.0191
Scan Average	0.0191
Maximum	0.06
Minimum	0.00
CU	0.00
No. of Points	56
LUMINAIRE INFORMATION	
Applied Circuits	A
No. of Luminaires	18
Total Load	18.00 kW

Guaranteed Performance: The ILLUMINATION described above is guaranteed per your Musco Warranty document.

Field Measurements: Individual field measurements may vary from computer-calculated predictions and should be taken in accordance with IESNA RP-6-15.

Electrical System Requirements: Refer to Amperage Draw Chart and/or the "Musco Control System Summary" for electrical sizing.

Installation Requirements: Results assume ± 3% nominal voltage at line side of the driver and structures located within 3 feet (1m) of design locations.

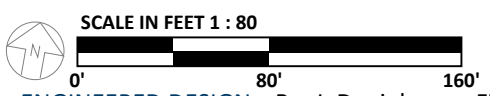

Pole location(s) ⊕ dimensions are relative to 0,0 reference point(s) ⊗



Gano Park Softball

Providence, RI

Grid Summary	
Name	Softball 1 Spill @ 5ft.
Spacing	30.0'
Height	5.0' above grade


Illumination Summary	
	INITIAL CANDELA (PER FIXTURE)
Entire Grid	
Scan Average	3105.8455
Maximum	7489.06
Minimum	354.09
CU	0.00
No. of Points	56
LUMINAIRE INFORMATION	
Applied Circuits	A
No. of Luminaires	18
Total Load	18.00 kW

Guaranteed Performance: The ILLUMINATION described above is guaranteed per your Musco Warranty document.

Field Measurements: Individual field measurements may vary from computer-calculated predictions and should be taken in accordance with IESNA RP-6-15.

Electrical System Requirements: Refer to Amperage Draw Chart and/or the "Musco Control System Summary" for electrical sizing.

Installation Requirements: Results assume ± 3% nominal voltage at line side of the driver and structures located within 3 feet (1m) of design locations.

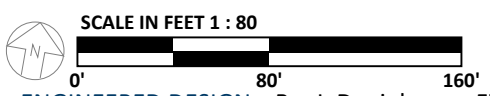

ENGINEERED DESIGN By: J. Danielson • File #237520E • 06-Jan-25

Pole location(s) ⊕ dimensions are relative to 0,0 reference point(s) ⊗



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ILLUMINATION SUMMARY

Gano Park Softball

Providence, RI

Grid Summary

Name Softball 1 Spill @ 5ft.
Spacing 30.0'
Height 5.0' above grade

Illumination Summary


INITIAL MAX VERTICAL FOOTCANDLES	
Entire Grid	
Scan Average	0.0566
Maximum	0.16
Minimum	0.00
CU	0.00
No. of Points	56
LUMINAIRE INFORMATION	
Applied Circuits	A
No. of Luminaires	18
Total Load	18.00 kW

Guaranteed Performance: The ILLUMINATION described above is guaranteed per your Musco Warranty document.

Field Measurements: Individual field measurements may vary from computer-calculated predictions and should be taken in accordance with IESNA RP-6-15.

Electrical System Requirements: Refer to Amperage Draw Chart and/or the "Musco Control System Summary" for electrical sizing.

Installation Requirements: Results assume $\pm 3\%$ nominal voltage at line side of the driver and structures located within 3 feet (1m) of design locations.

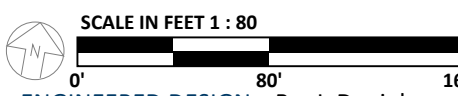

ENGINEERED DESIGN By: J. Danielson • File #237520E • 06-Jan-25

Pole location(s) ⊕ dimensions are relative to 0,0 reference point(s) ⊗



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ILLUMINATION SUMMARY

Gano Park Softball

Providence, RI

Equipment Layout

INCLUDES:

· Softball 1

Electrical System Requirements: Refer to Amperage Draw Chart and/or the "Musco Control System Summary" for electrical sizing.


Installation Requirements: Results assume ± 3% nominal voltage at line side of the driver and structures located within 3 feet (1m) of design locations.

Equipment List For Areas Shown

QTY	LOCATION	Pole		Luminaires		
		SIZE	GRADE ELEVATION	ABOVE GRADE LEVEL	LUMINAIRE TYPE	QTY/POLE
2	A1-A2	60'	-	60'	TLC-LED-1200	1
				60'	TLC-LED-900	2
				15.5'	TLC-BT-575	1
2	B1-B2	60'	-	60'	TLC-LED-1200	3
				60'	TLC-LED-1500	1
				15.5'	TLC-BT-575	1
4	Totals					18

Single Luminaire Amperage Draw Chart

Driver Specifications (.90 min power factor)	Line Amperage Per Luminaire (max draw)					
	208 (60)	220 (60)	240 (60)	277 (60)	347 (60)	480 (60)
Single Phase Voltage						
TLC-LED-1500	8.4	7.9	7.3	6.3	5.0	4.6
TLC-LED-1200	6.9	6.5	6.0	5.2	4.2	3.8
TLC-LED-900	5.2	4.9	4.5	3.9	3.1	2.9
TLC-BT-575	3.3	3.2	2.9	2.5	2.0	1.8

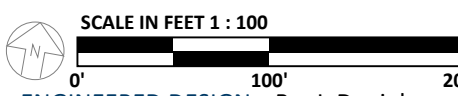


ENGINEERED DESIGN By: J. Danielson • File #237520E • 06-Jan-25

Pole location(s) ⊕ dimensions are relative to 0,0 reference point(s) ⊗



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EQUIPMENT LAYOUT

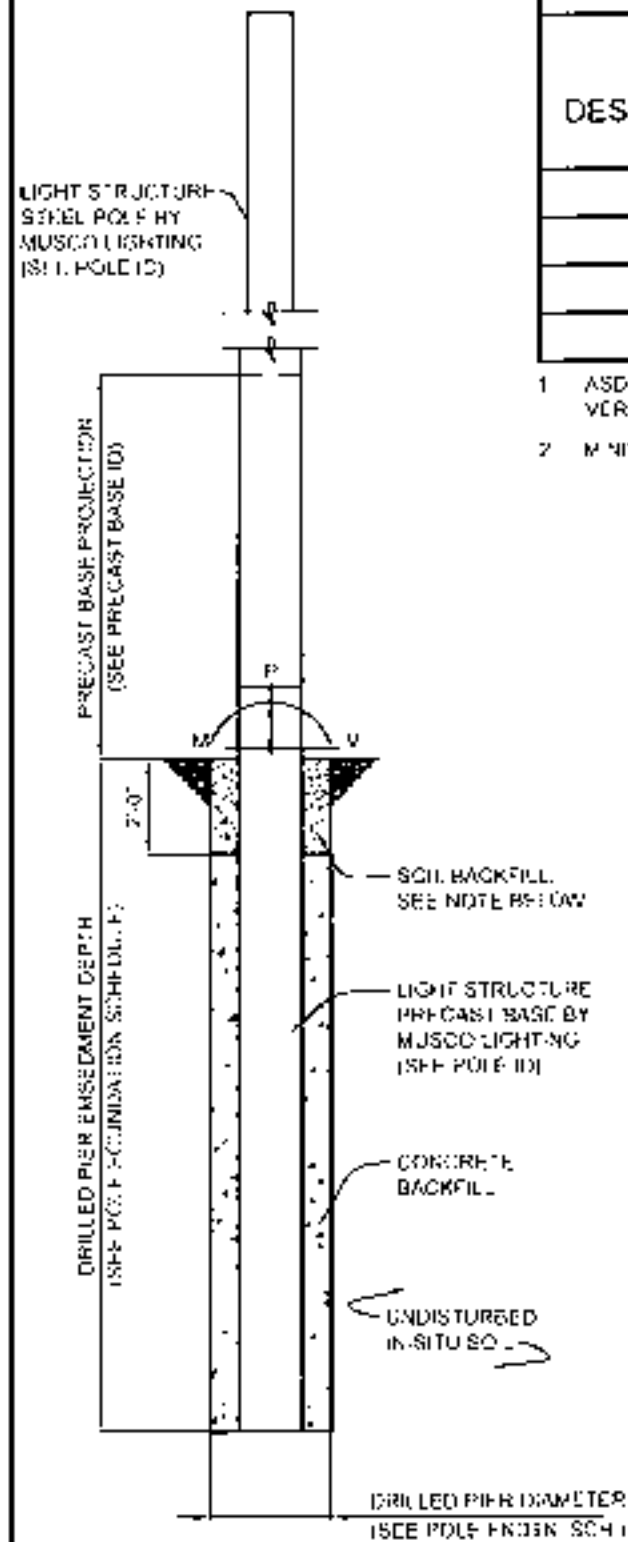

POLE FOUNDATION ELEV.

SCALE: NOT TO SCALE

SOIL BACKFILL NOTE:
 THE TOP TWO FEET OF ANNULUS SHALL BE BACKFILLED WITH SOIL WITH A CLASSIFICATION OF CLASS 5 (TABLE 1806.2) OR BETTER. COMPACTION, 95% FOR COHESIVE SOIL AND 98% FOR A COHESIONLESS SOIL BASED UPON STANDARD PROCTOR TESTING (ASTM D698)

POLE FOUNDATION SCHEDULE						
POLE DESIGNATION	FORCES (1)			DRILLED PIER		
	MOMENT (M) FT-LBS	SHEAR (M) LBS	VERTICAL (P) LBS	DIAMETER (INCHES)	EMBEDMENT DEPTH	CONCRETE BACKFILL YD ³ (2)
A1, A2	38,036	1,043	981	20	10'-0"	1.3
B1, B2	42,457	1,121	1,152	26	10'-0"	1.9
A3, A4	39,146	1,000	981	20	10'-0"	1.3
B3, B4	39,399	1,009	1,064	20	10'-0"	1.3

- ASD LOAD COMBINATION D + E (W)
 VERTICAL FORCE IS WEIGHT OF DRESSED POLE (DOES NOT INCLUDE PRECAST BASE WEIGHT);
- MINIMUM CONCRETE BACKFILL VOLUME. SITE CONDITIONS MAY REQUIRE ADDITIONAL BACKFILL.

PRECAST BASE IDENTIFICATION					
PRECAST BASE TYPE	PRECAST BASE WEIGHT	PRECAST BASE LENGTH	PROJECTION ABOVE GRADE	STANDARD EMBEDMENT	OUTSIDE DIAMETER
2B	1,593 LBS	17'-3"	7'-3"	10'-0"	12'-00"

POLE IDENTIFICATION					
POLE DESIGNATION	POLE TYPE	PRECAST BASE TYPE	FIXTURE CONFIGURATION (F X PER ARM)	FIXTURE AND ACCESSORY EPA (F1)	
A1, A2	LS821AA	2B	4 (3)	10.2	
B1, B2	LS821AA	2B	5 (4)	11.1	
A3, A4	LS821AA	2B	4 (3)	10.8	
B3, B4	LS821AA	2B	5 (4)	10.3	

EACH POLE HAS (1) MUSCO LIGHTING FIXTURE AT 15'-6" AGL. INCLUDED ABOVE

DESIGN NOTES

DESIGN PARAMETERS:
 WIND: $V = 125$ MPH; $V_{red} = 97$ MPH; EXPOSURE C; RISK CATEGORY I; PER INTERNATIONAL BUILDING CODE, 2018 EDITION (ASCE 7-16)

GEOTECHNICAL PARAMETERS:
 ALLOWABLE END BEARING SOIL PRESSURE: 1,500 PSF OR SAUER FRICTION: 250 PSF
 ALLOWABLE LATERAL SOIL BEARING PRESSURE:
 100 PSF/FT (GRADE TO 2'-0"), 250 PSF/FT (BELOW 2'-0")
 IN ACCORDANCE WITH THE 2018 EDITION OF THE INTERNATIONAL BUILDING CODE, CHAPTER 18. SEE TABLE 1806.2, SOIL MATERIAL CLASS 5 & SECTION 1806.3.4

DESIGN SOIL PARAMETERS ARE AS NOTED. ACTUAL ALLOWABLE SOIL PARAMETERS MUST BE VERIFIED ON SITE.

A GEOTECHNICAL ENGINEER OR REPRESENTATIVE OF IS RECOMMENDED (NOT REQUIRED) TO BE AVAILABLE AT THE TIME OF THE FOUNDATION INSTALLATION TO VERIFY THE SOIL DESIGN PARAMETERS AND TO PROVIDE ASSISTANCE IF ANY PROBLEMS ARISE IN FOUNDATION INSTALLATION.

ENCOUNTERING SOIL FORMATIONS THAT WILL REQUIRE SPECIAL DESIGN CONSIDERATIONS OR EXCAVATION PROCEDURES MAY OCCUR. POLE FOUNDATIONS WILL NEED TO BE ANALYZED ACCORDING TO THE SOIL CONDITIONS THAT EXIST. IF ANY DISCREPANCIES OR INCONSISTENCIES ARISE, NOTIFY THE ENGINEER OF SUCH DISCREPANCIES. FOUNDATIONS WILL THEN BE REVISED ACCORDINGLY. REVISIONS WILL BE ANALYZED PER RECOMMENDATIONS DIRECTED BY A REGISTERED ENGINEER.

ALL EXCAVATIONS MUST BE FREE OF LOOSE SOIL AND DEBRIS PRIOR TO FOUNDATION INSTALLATION AND CONCRETE BACKFILL PLACEMENT. TEMPORARY CASINGS OR DRILLERS SLURRY MAY BE USED TO STABILIZE THE EXCAVATION DURING INSTALLATION. CASINGS MUST BE REMOVED DURING CONCRETE BACKFILL PLACEMENT. CONCRETE BACKFILL MUST BE PLACED WITH A TREMIE WHEN SLURRY OR WATER IS PRESENT WITHIN THE EXCAVATION.

CONTRACTOR MUST BE FAMILIAR WITH THE COMPLETE SOIL INVESTIGATION REPORT AND BORINGS AND CONTACT THE GEOTECHNICAL FIRM IF NECESSARY TO UNDERSTAND THE SOIL CONDITIONS AND THE POSSIBILITY OF GROUND WATER PUMPING AND EXCAVATION STABILIZATION OR BRACING DURING PRECAST BASE INSTALLATION AND PLACEMENT OF CONCRETE BACKFILL.

CONCRETE:
 CONCRETE SHALL BE AIR-ENTRAINED AND HAVE A MINIMUM COMPRESSIVE DESIGN STRENGTH AT 28 DAYS OF 3,000 PSI. 3,000 PSI CONCRETE IS SPECIFIED FOR EARLY POLE ERECTION. ACTUAL REQUIRED MINIMUM ALLOWABLE CONCRETE STRENGTH IS 1,300 PSI. ALL PIERS AND CONCRETE BACKFILL MUST BEAR ON AND AGAINST FIRM UNDISTURBED SOIL.

GENERAL NOTES:
 FIXTURES MUST BE LOCATED TO MAINTAIN 10'-0" MINIMUM HORIZONTAL CLEARANCE FROM ANY OBSTRUCTION. ENGINEER MUST BE NOTIFIED IF FOUNDATIONS ARE NEAR ANY RETAINING WALLS OR WITHIN 10' OF ANY SLOPE STEEPER THAN 3H:1V. POLES, FIXTURES, PRECAST BASES, ELECTRICAL ITEMS AND INSTALLATION PER MUSCO LIGHTING.

MATTHEW L. PEEFER
Matthew L. Peffer
 No. 11653
 11-22-2024
 REGISTERED
 PROFESSIONAL ENGINEER
 CIVIL

**GANO PARK
 BASEBALL
 FIELD LIGHTING
 PROVIDENCE, RI**

MUSCO Lighting
 CORPORATE: 100 1st AVE WEST
 OSALDOGA, IA 52537
 (800) 625-6020

STRUCTURAL ENGINEERS, P.C.
 114 N. CHILAS DRIVE
 MARSHALLTOWN, IOWA 50158
 PHONE: N. JENNER 641-792-6334
 EMAIL: N. SL INFO@SEPC.IOWA

DISPERSED LIT
 POLE AND FOUNDATION
 SCALE: NOT TO SCALE
 SHEET: 1
 SCAN #237520

PROJECT NUMBER: 237520

DATE: 22 NOVEMBER 2024

DRAWING NUMBER: C1

OF ONE