

GENERAL NOTES:

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Architect if additional dimensioning is

2: Contractor shall verify all dimensions in the field and notify Architect of any

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3: The Contractor shall provide all materials indiccated, graphically, as annotated or as needed for a complete and proper installation, and shall notify Architect of any discrepancies

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4: Large scale plans of details shall take precedence over smaller scale drawings.
5: All work shall be in conformance with the Federal, State, and Local Building Codes and other governing bodies.

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7: All work is to be installed in accordance

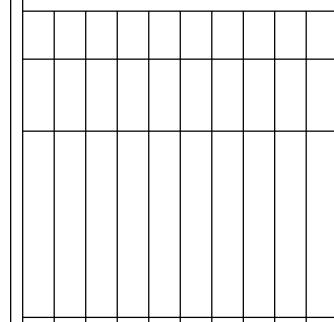
with manufacturer's recommendations and specifications.


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ALTERATIONS.





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ISSUED FOR: INTERNAL REVIEW

> GENERAL PLANNING DRAWINGS FOR:

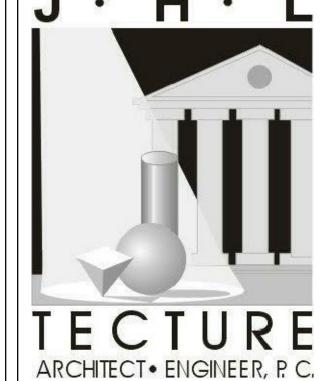THIS SET IS FOR SCHEMATIC DESIGN DOCUMENTATION AND SHOULD NOT BE USED FOR CONSTRUCTION PURPOSES

GENERAL PLANNING DRAWINGS FOR:

GRACE HARBOR CHURCH

430 KINSLEY AVENUE PROVIDENCE, RI, 02909

EXISTING CONDITIONS

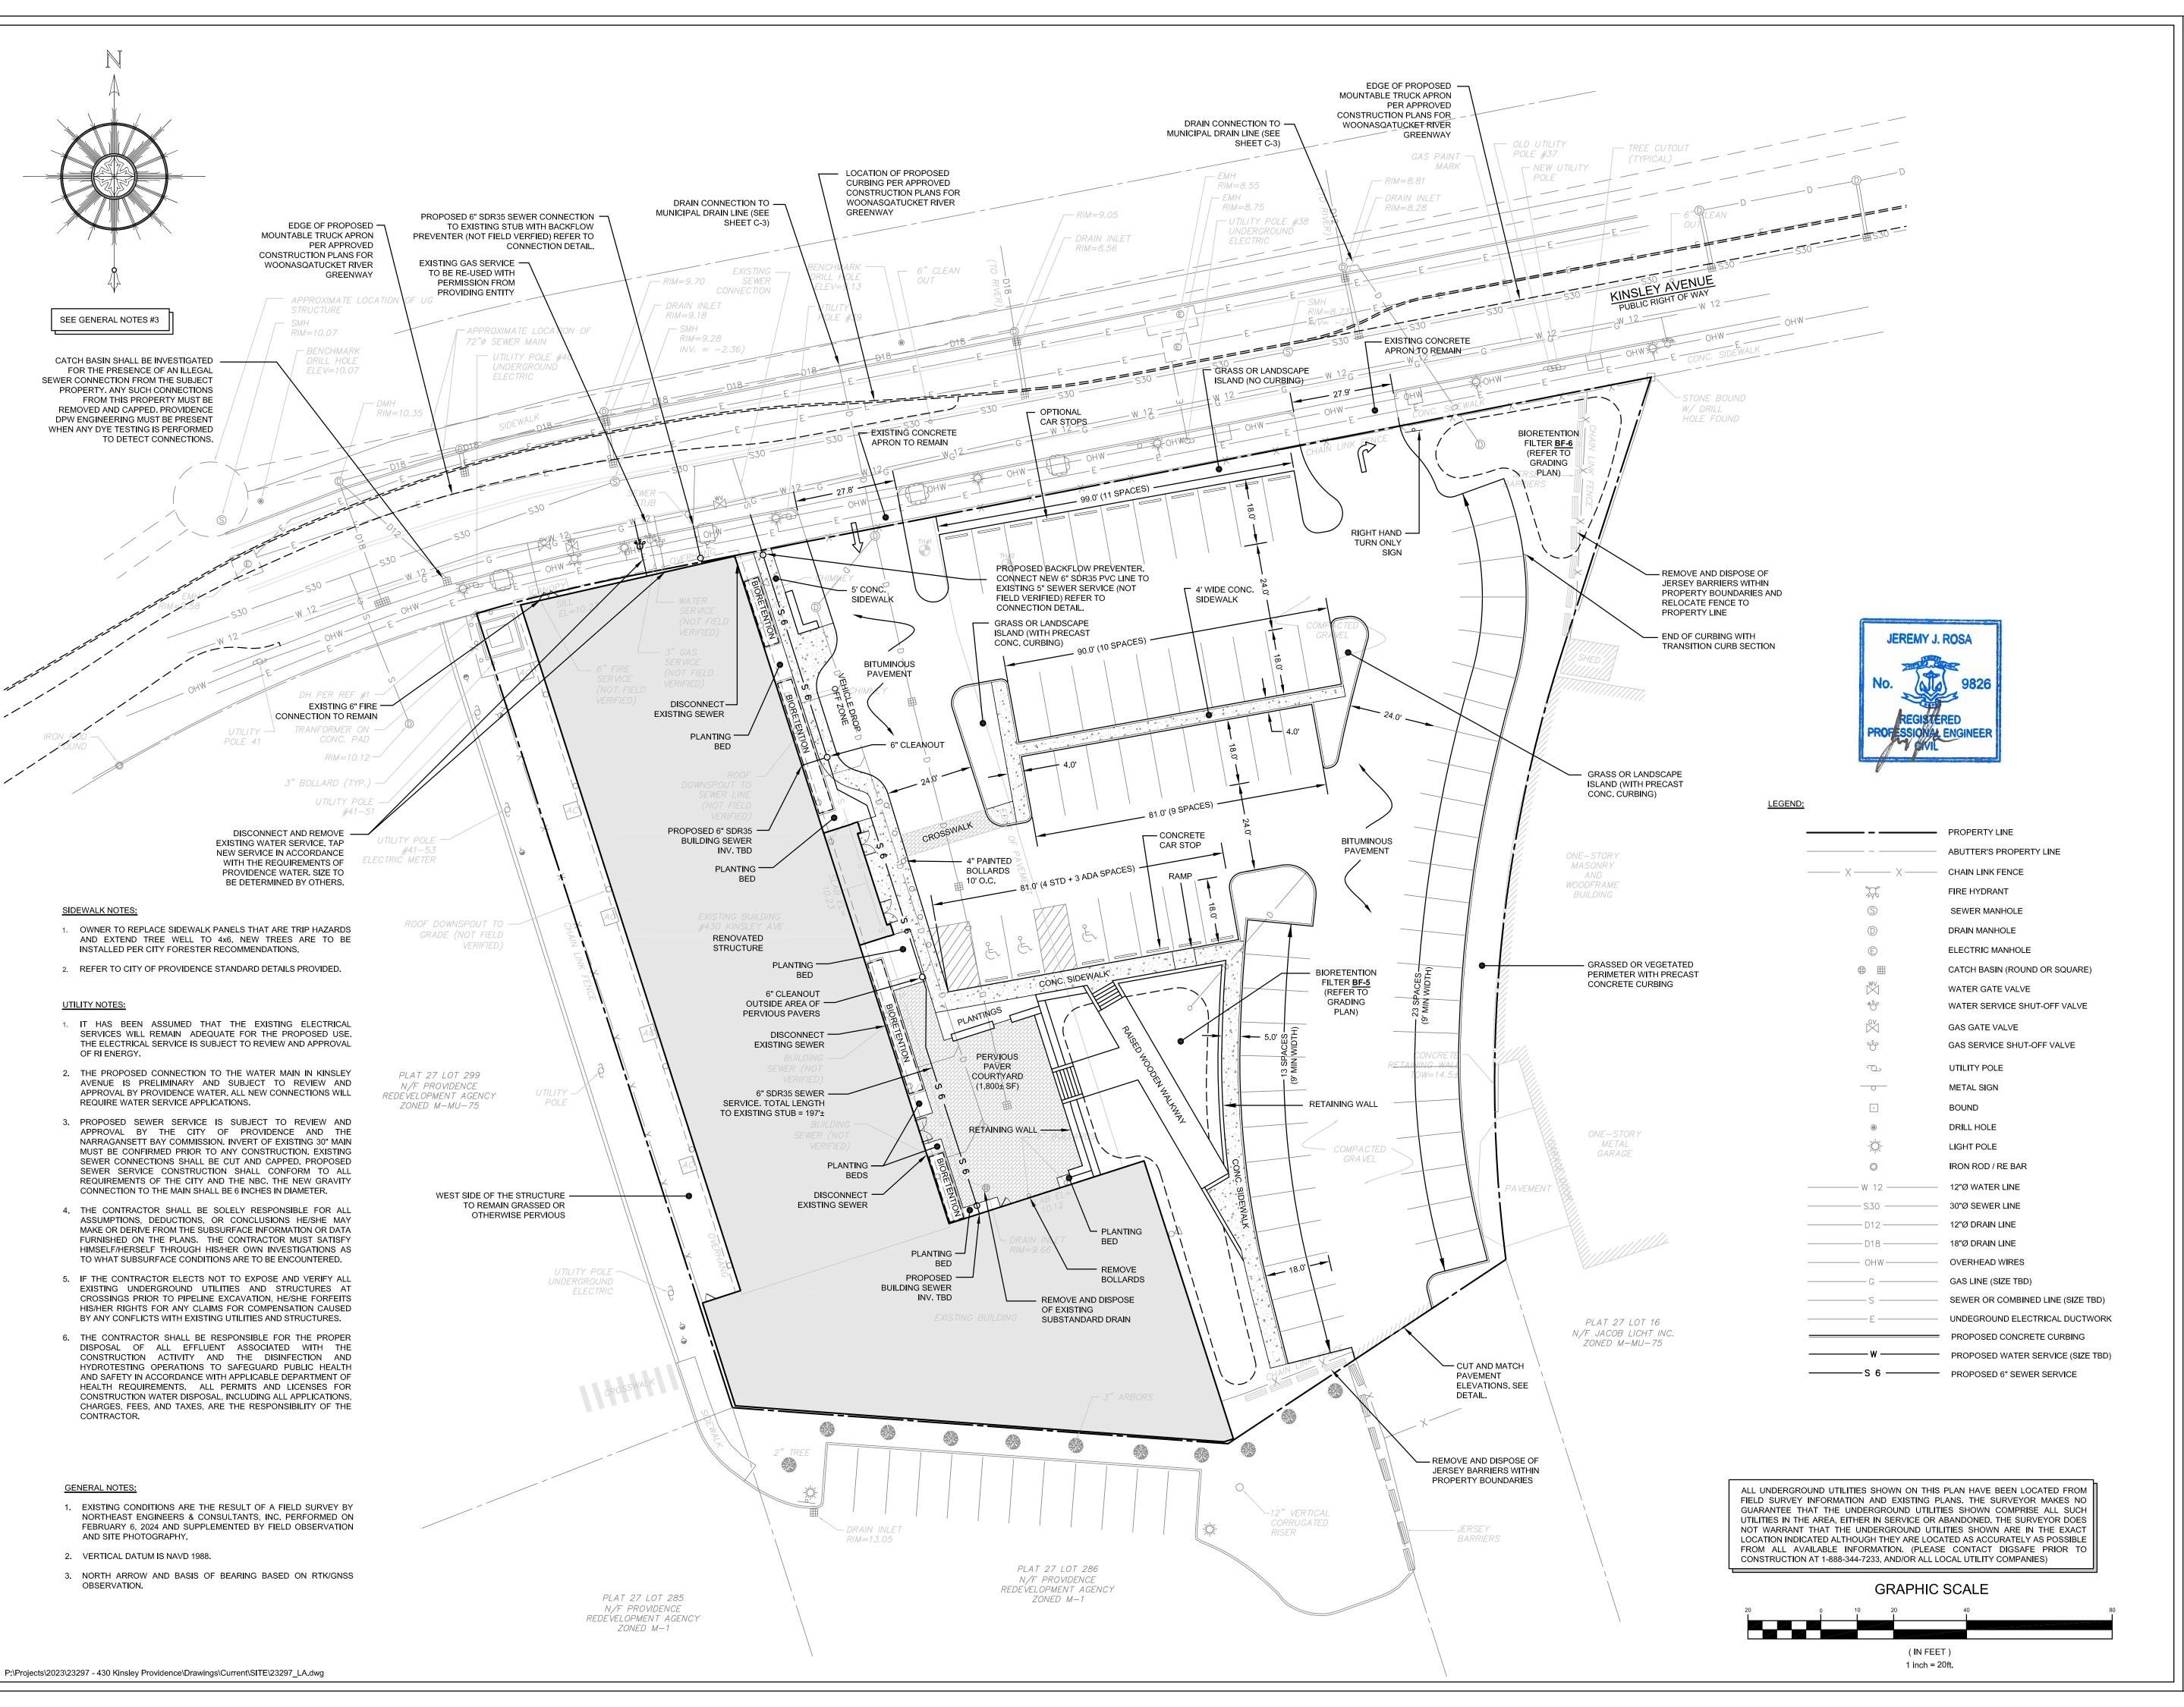
DATE: 12AUG24
SCALE: 1"=20'
DRAWN BY: JJR

PROJECT NUMBER:

7461

DRAWING NUMBER:

C-01



GENERAL NOTES:

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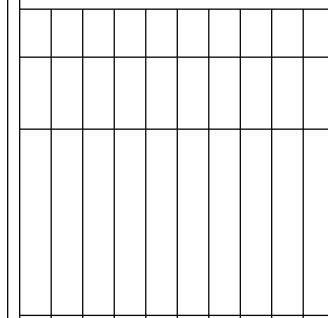
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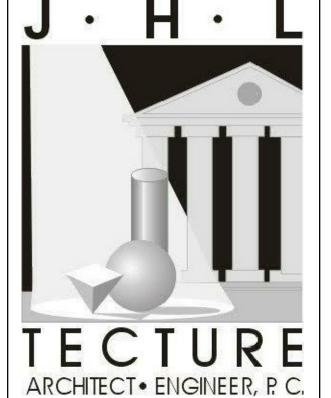
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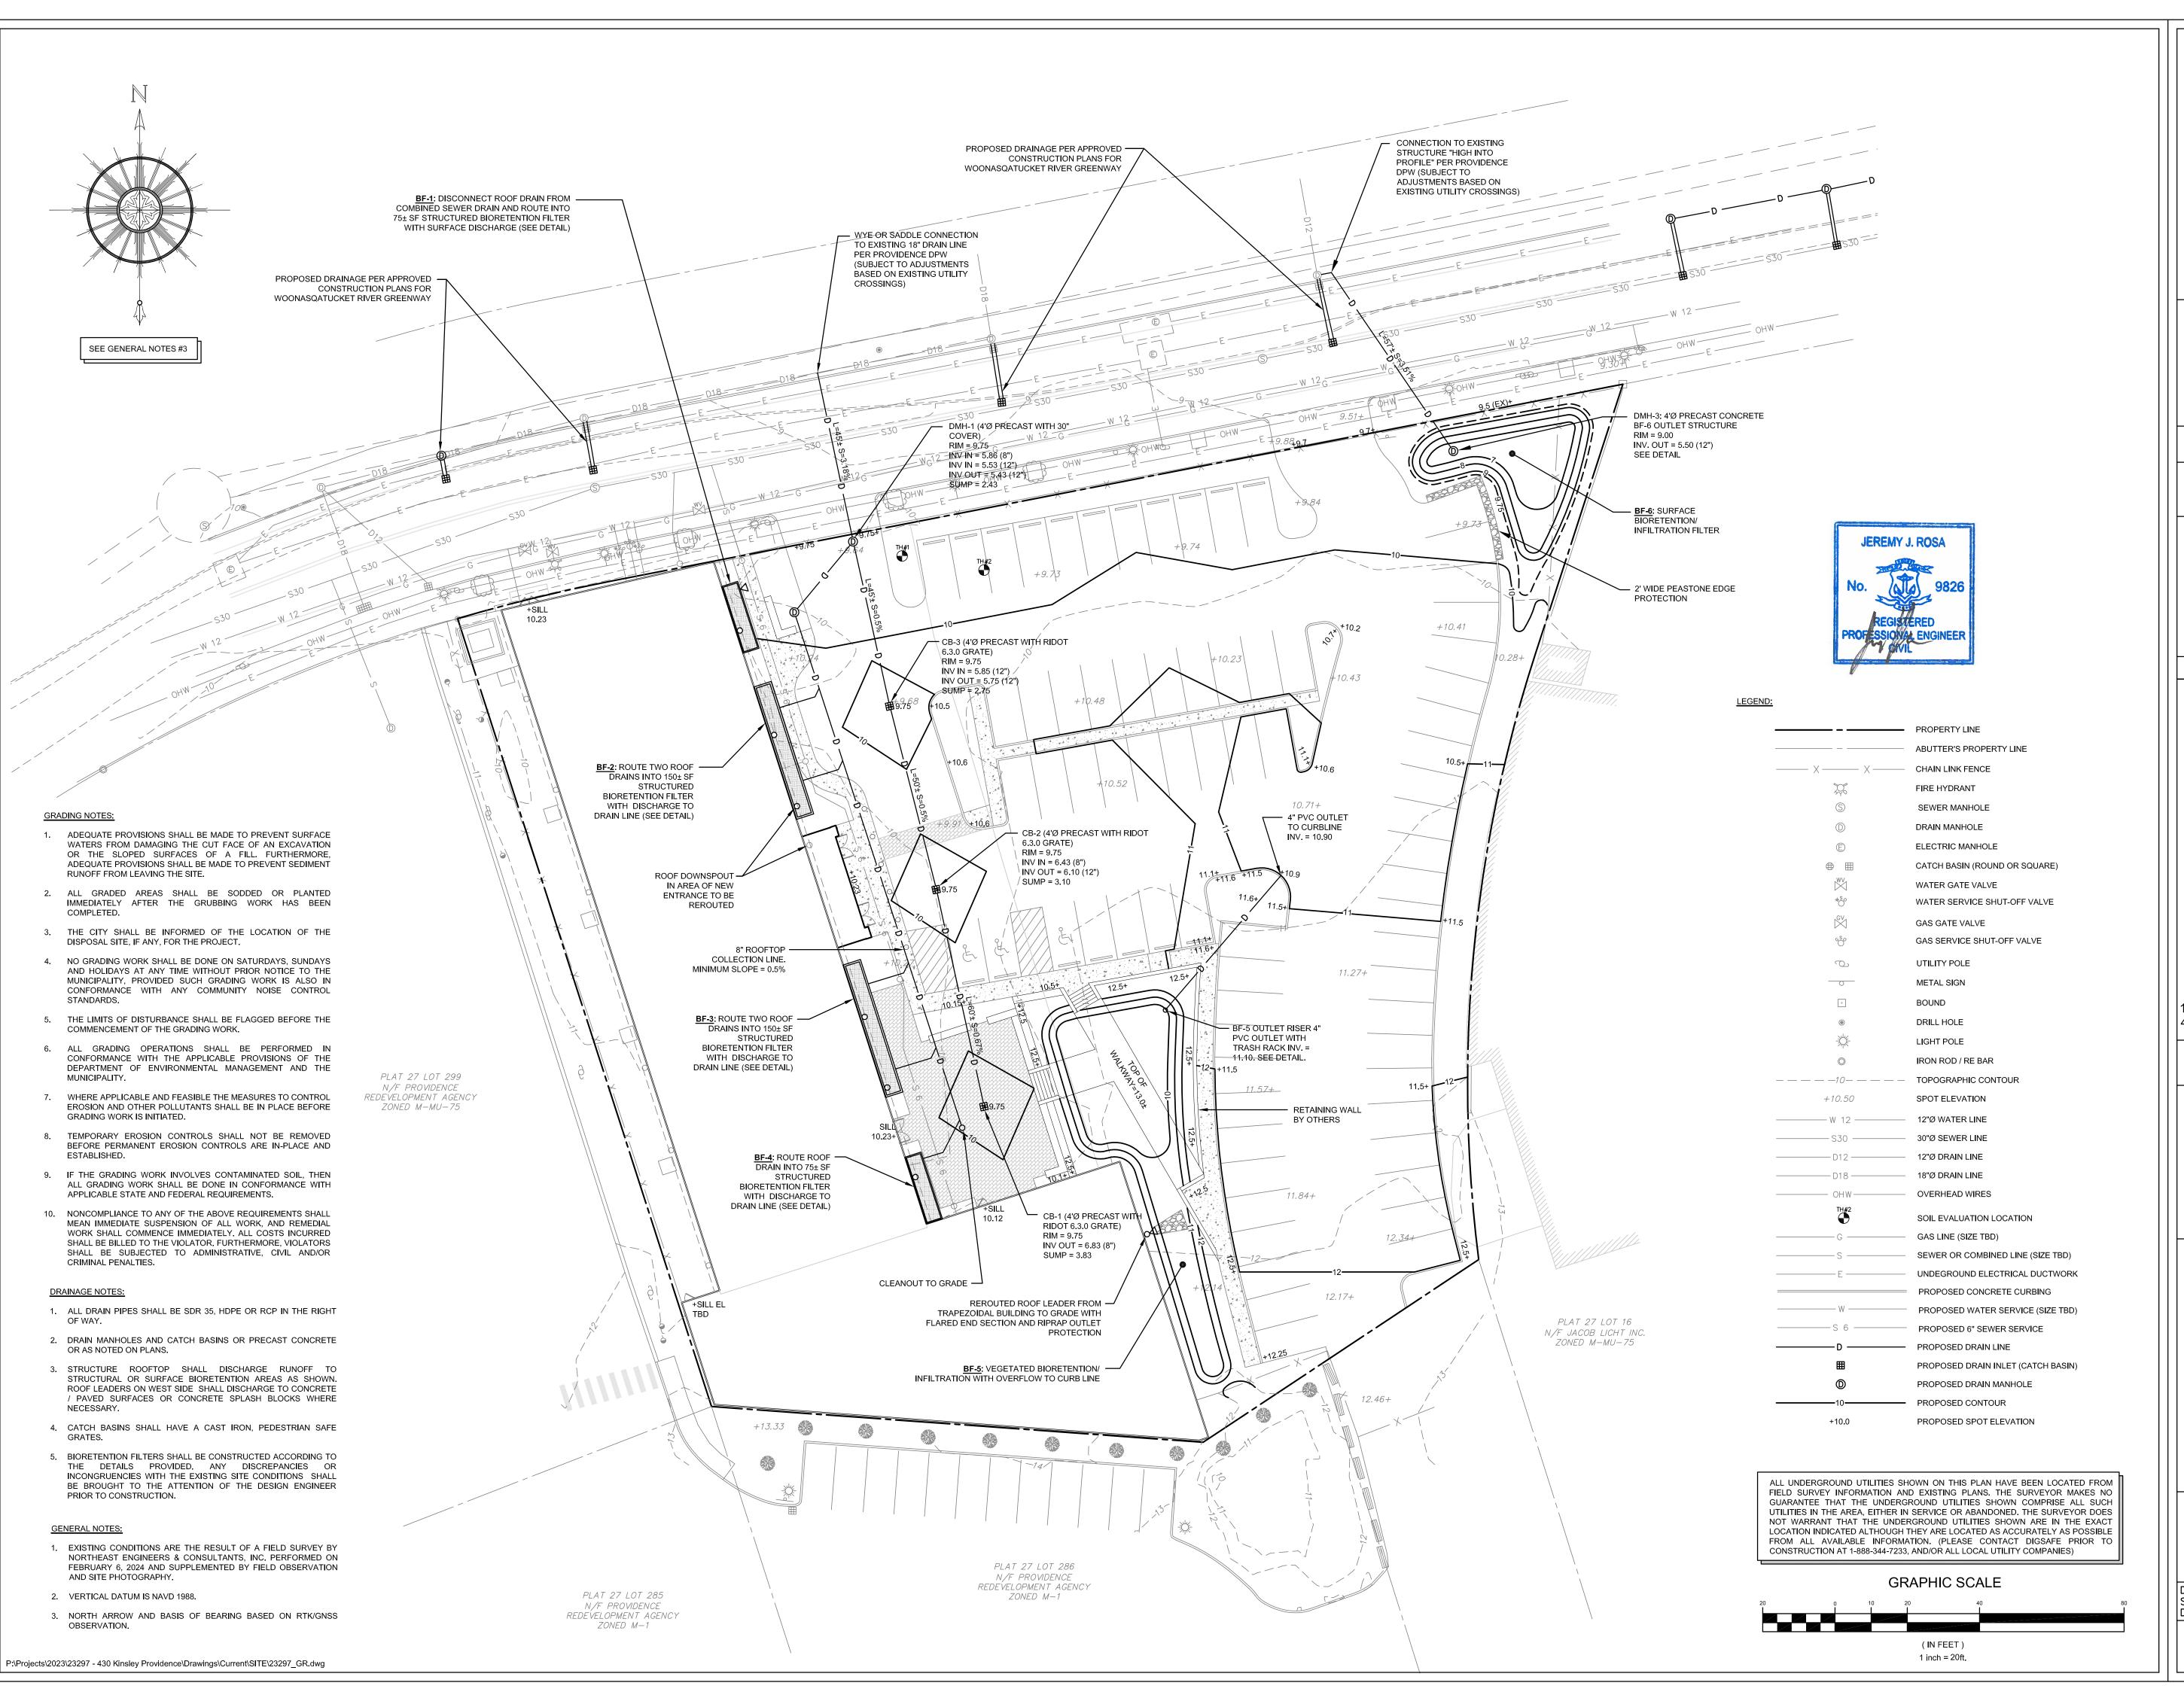
430 KINSLEY AVENUE PROVIDENCE, RI, 02909

LAYOUT AND UTILITY PLAN

DATE: 28AUG24
SCALE: 1"=20'
DRAWN BY: JJR

PROJECT NUMBER:

7461



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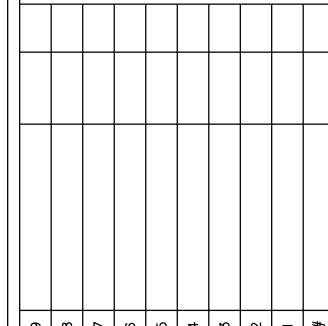
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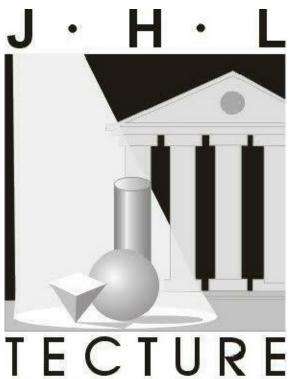
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ARCHITECT • ENGINEER, P. C.

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GENERAL PLANNING DRAWINGS FOR:

GRACE HARBOR CHURCH

430 KINSLEY AVENUE PROVIDENCE, RI, 02909

GRADING AND DRAINAGE PLAN

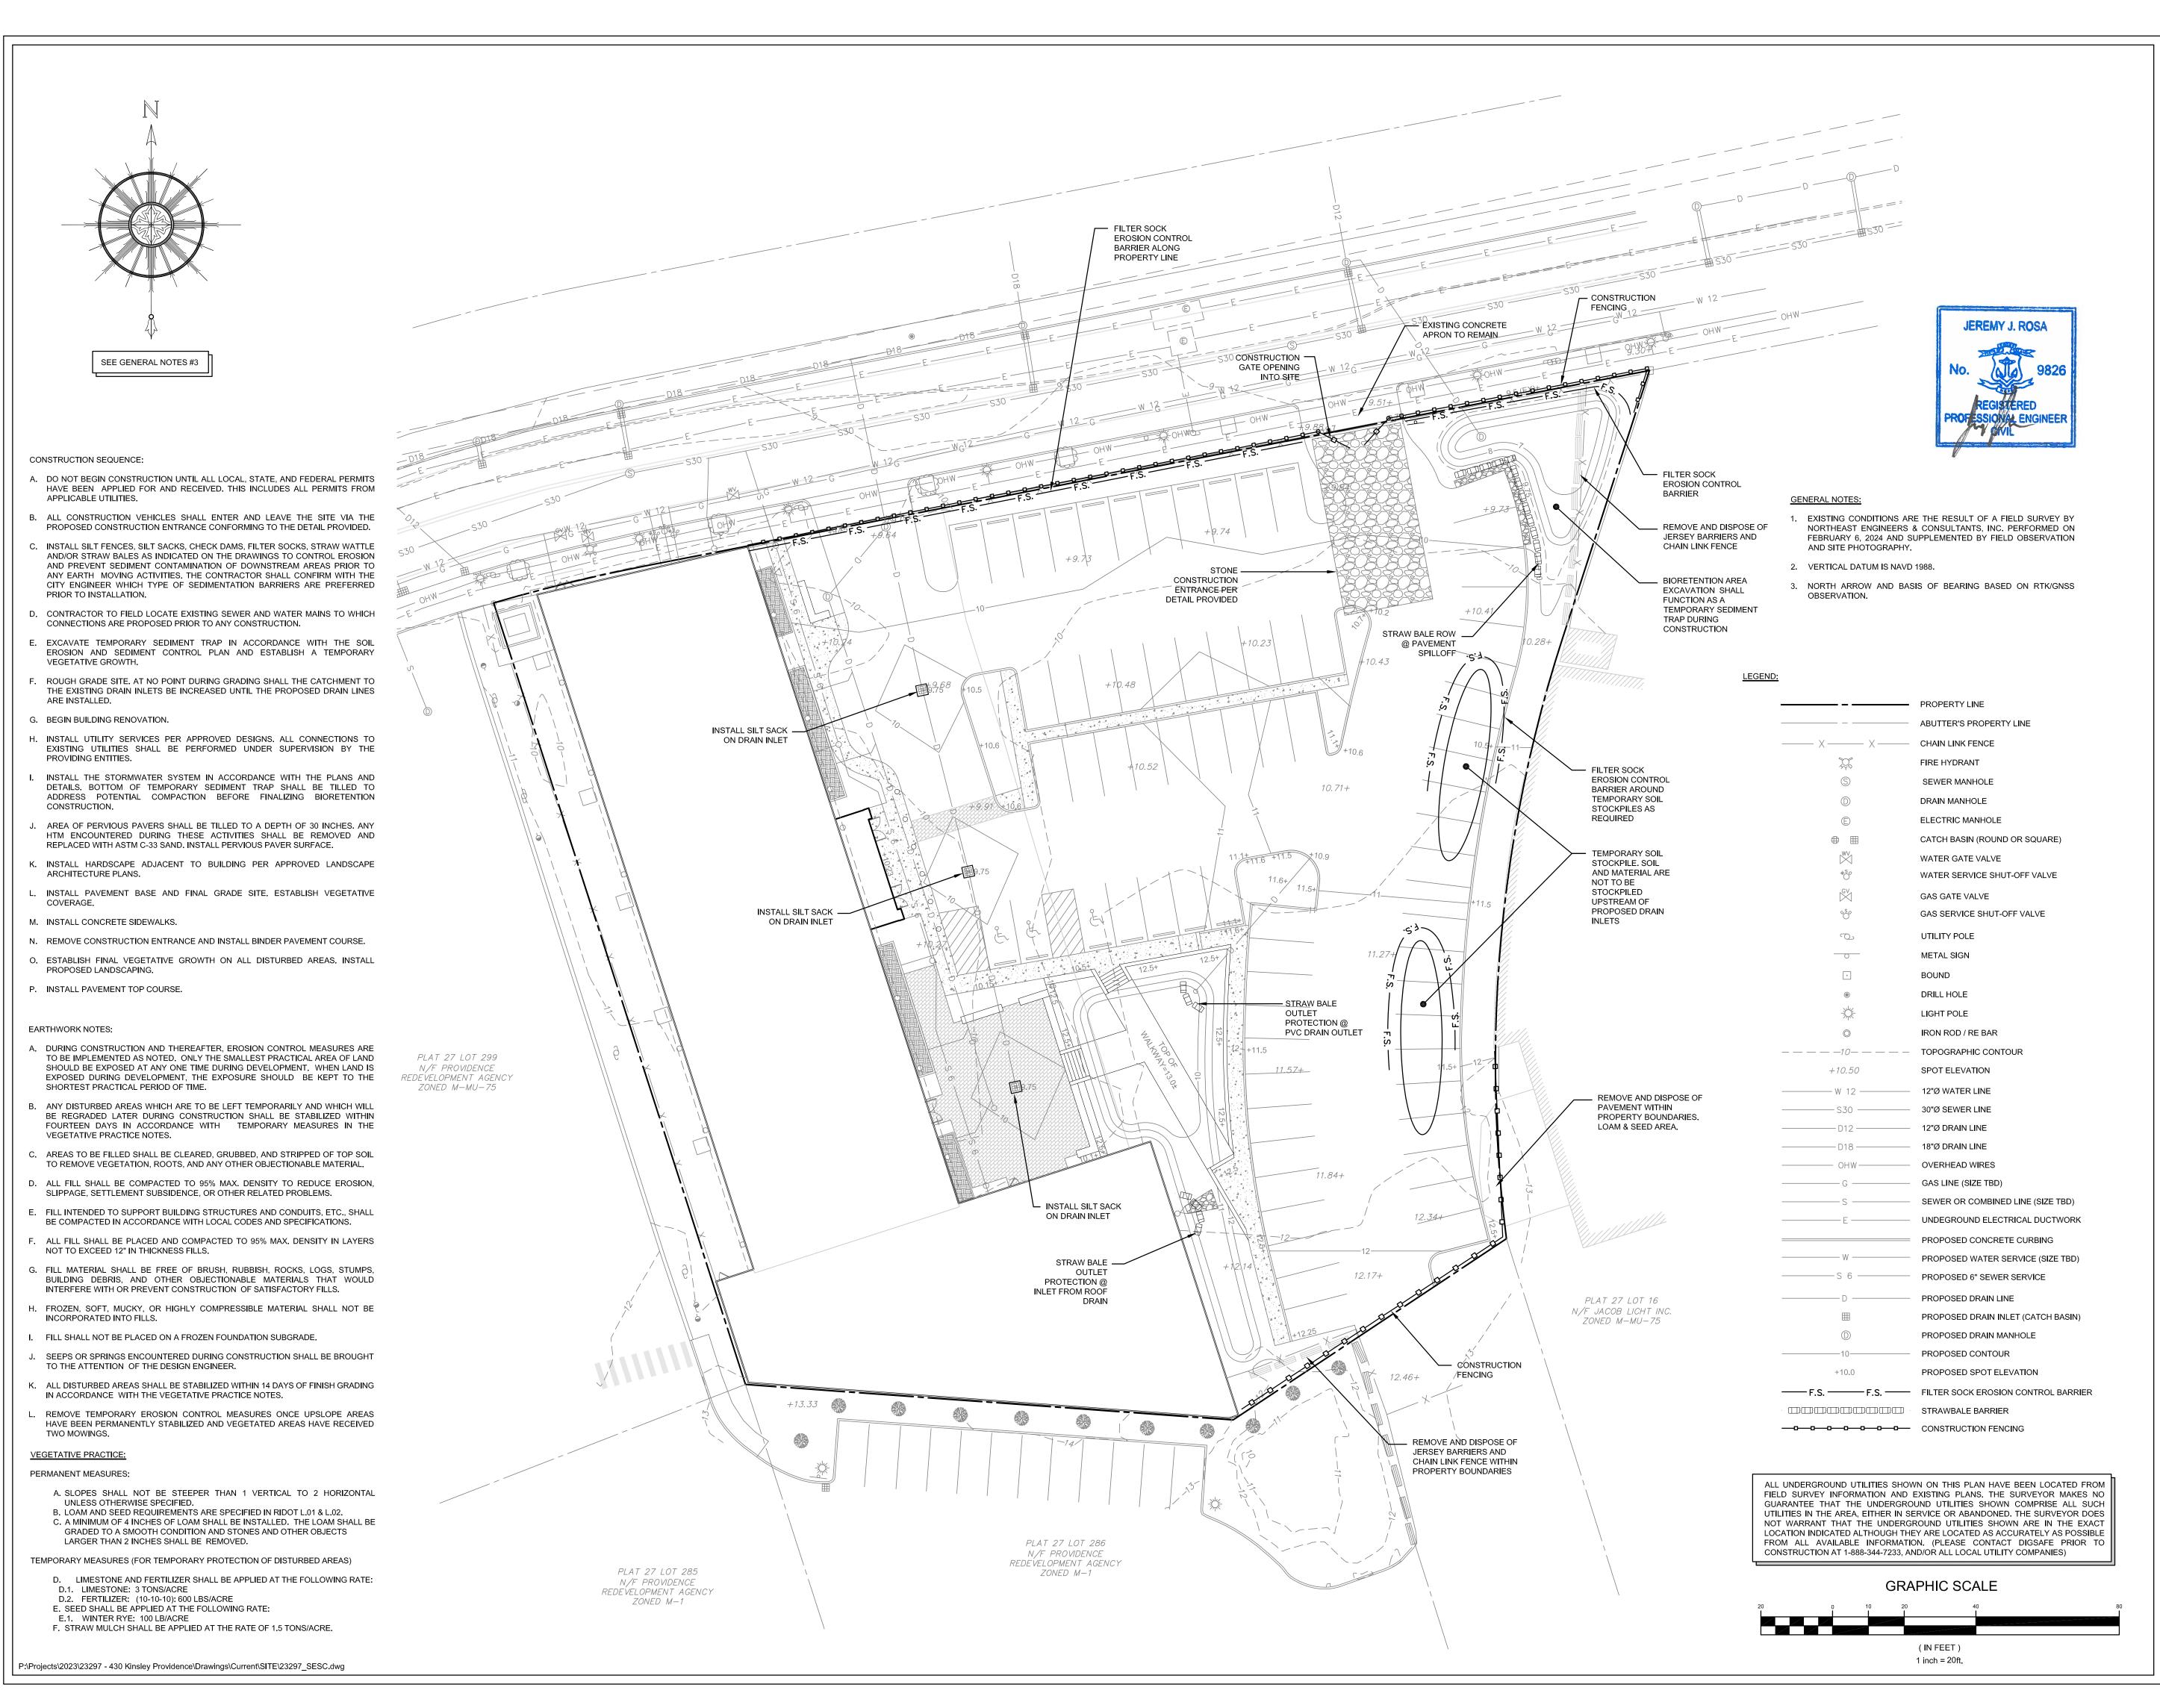
DATE: 28AUG24
SCALE: 1"=20'
DRAWN BY: JJR

PROJECT NUMBER:

7461

DRAWING NUMBER:

C-03



GENERAL NOTES:

1: DO NOT SCALE DRAWNGS. Notify Architect if additional dimensioning is required.

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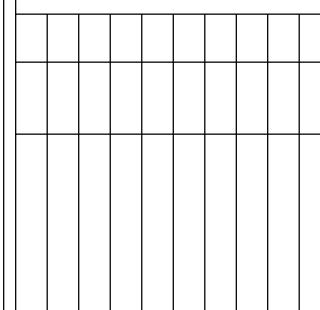
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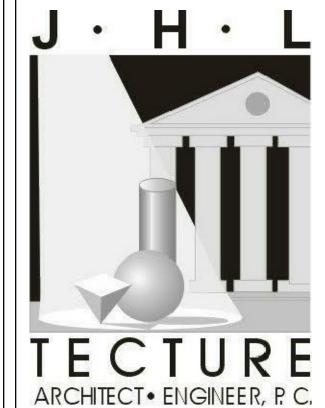
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GENERAL PLANNING

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GENERAL PLANNING DRAWINGS FOR:

GRACE
HARBOR
CHURCH

430 KINSLEY AVENUE PROVIDENCE, RI, 02909

SOIL EROSION AND SEDIMENT CONTROL PLAN

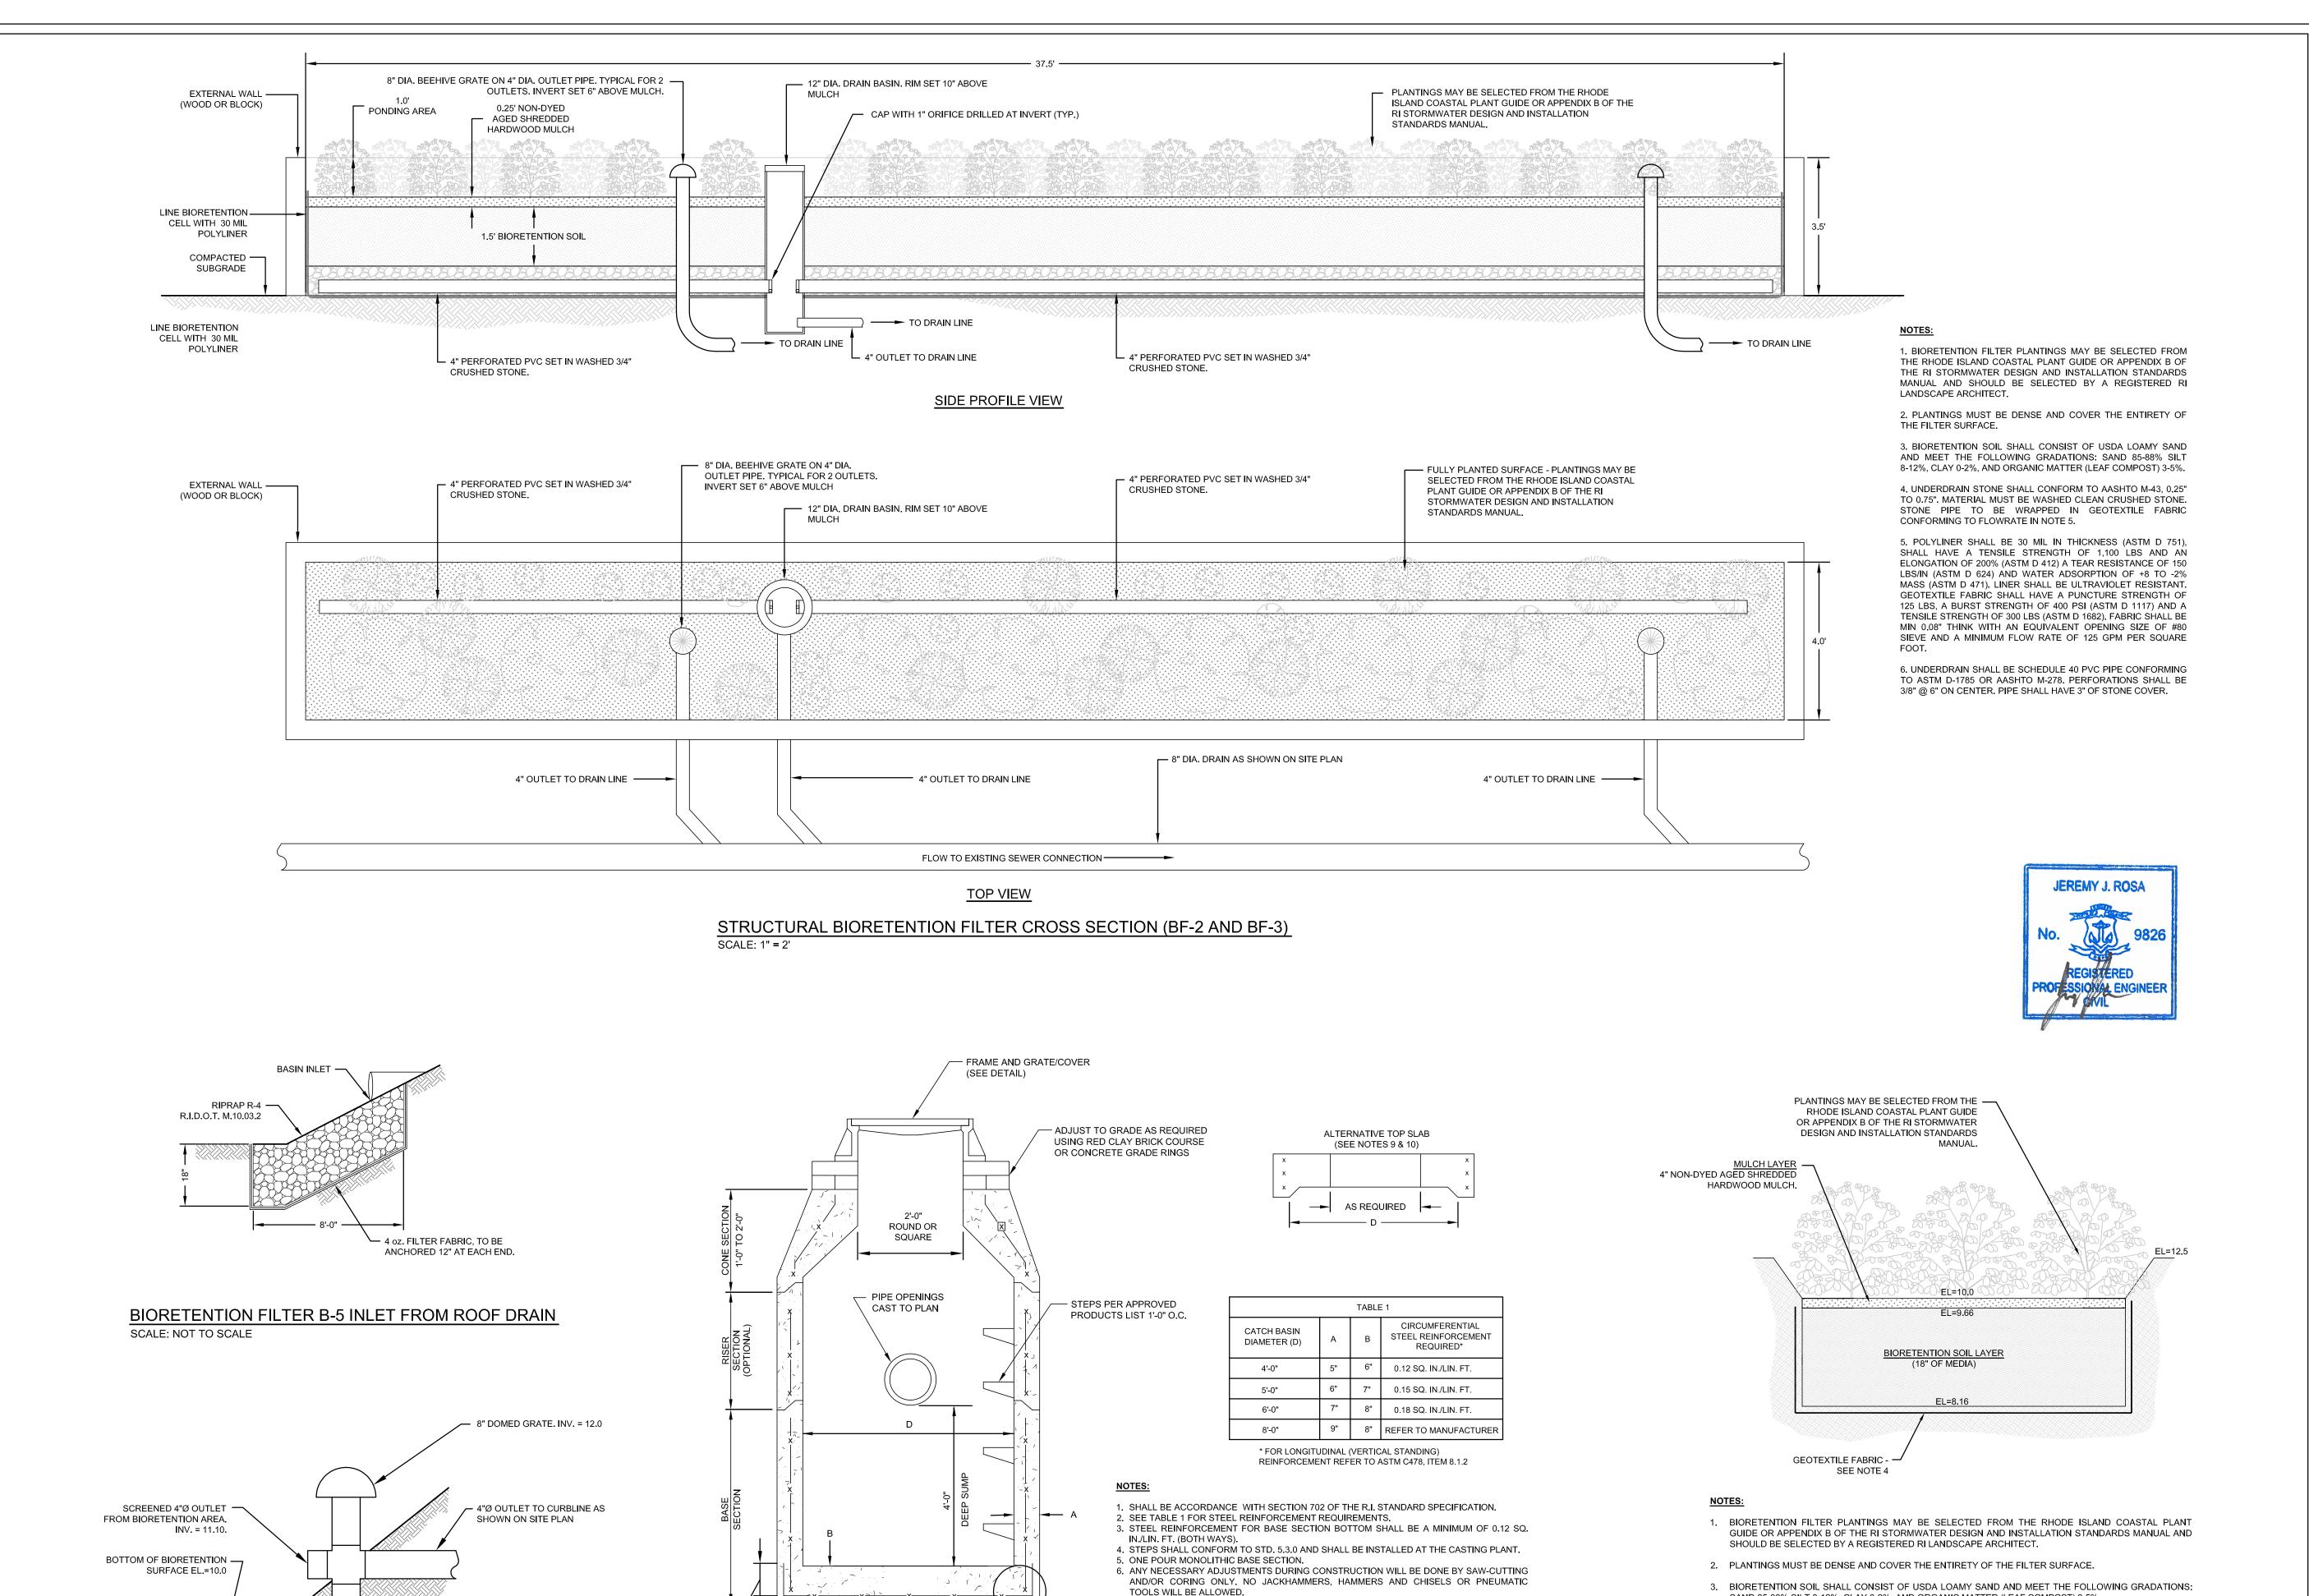
CONTROL PLAN

DATE: 02AUG24
SCALE: 1"=20'
DRAWN BY: JJR

PROJECT NUMBER:

7461

C-0



SCALE: NOT TO SCALE

(SEE NOTE 3) —

8" MIN.

OVERLAP -

(TYPICAL)

3/4" STONE BASE

PRECAST ROUND CATCH BASIN & DRAIN MANHOLE (RIDOT 4.4.0)

4'-0" CATCH BASIN ONLY.

BECAUSE OF STRUCTURE DEPTH.

11. REFER TO STD. 5.2.0 FOR MAXIMUM PIPE SIZES.

7. CORBEL MADE OF RED CLAY BRICK WILL BE PERMITTED FOR THE "CONE SECTION" OF THE

9. ALTERNATIVE TOP SLAB IS STEEL REINFORCED TO MEET OR EXCEED H-25 LOADING (SEE

10. ALTERNATIVE TOP SLAB IS ONLY FOR USE WHEN REDUCING SECTION DOES NOT FIT

8. THE CENTERLINE OF THE OPENING MUST BE WITHIN 2'-0" FROM THE STEPS.

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GRACE **HARBOR CHURCH**

430 KINSLEY AVENUE PROVIDENCE, RI, 02909

SITE DETAILS 1

DATE: 02AUG24 DRAWING NUMBER: SCALE: AS SHOWN DRAWN BY: JJR PROJECT NUMBER:

SAND 85-88% SILT 8-12%, CLAY 0-2%, AND ORGANIC MATTER (LEAF COMPOST) 3-5%.

SQUARE FOOT.

SCALE: NOT TO SCALE

4. GEOTEXTILE FABRIC SHALL HAVE A PUNCTURE STRENGTH OF 125 LBS, A BURST STRENGTH OF 400 PSI

BIORETENTION FILTER BF-5 CROSS SECTION

(ASTM D 1117) AND A TENSILE STRENGTH OF 300 LBS (ASTM D 1682). FABRIC SHALL BE MIN 0.08" THINK

WITH AN EQUIVALENT OPENING SIZE OF #80 SIEVE AND A MINIMUM FLOW RATE OF 125 GPM PER

P:\Projects\2023\23297 - 430 Kinsley Providence\Drawings\Current\SITE\23297_DET.dwg

BOTTOM OF 4" RISER -

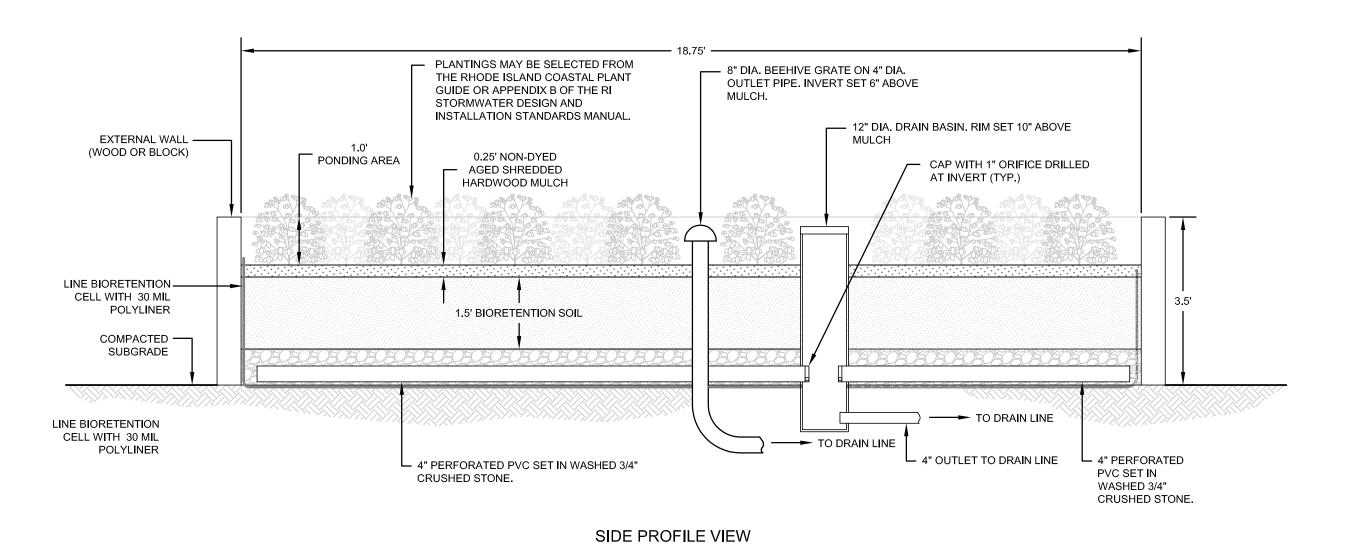
EMBEDDED IN CRUSHED

STONE OR CONCRETE

BOTTOM EL = 8.0

SCALE: NOT TO SCALE

BIORETENTION FILTER B-5 OUTLET PIPE RISER



- PLANTINGS MAY BE SELECTED FROM 8" DIA. BEEHIVE GRATE ON 4" THE RHODE ISLAND COASTAL PLANT DIA. OUTLET PIPE. INVERT GUIDE OR APPENDIX B OF THE RI SET 6" ABOVE MULCH. STORMWATER DESIGN AND INSTALLATION STANDARDS MANUAL. 12" DIA. DRAIN BASIN. ---EXTERNAL WALL ----RIM SET 10" ABOVE (WOOD OR BLOCK) MULCH 0.25' NON-DYED PONDING AREA AGED SHREDDED CAP WITH 1" ORIFICE DRILLED -HARDWOOD MULCH AT INVERT (TYP.) LINE BIORETENTION -CELL WITH 30 MIL POLYLINER 1.5' BIORETENTION SOIL COMPACTED -SUBGRADE LINE BIORETENTION CELL WITH 30 MIL - 4" PVC OUTLET TO POLYLINER PAVEMENT OR SPLASH - 4" PERFORATED └ SOLID 4" PVC 4" PERFORATED PVC SET IN WASHED 3/4" BLOCK PVC SET IN OUTLET TO CRUSHED STONE. WASHED 3/4" PAVEMENT OR CRUSHED STONE. SPLASH BLOCK

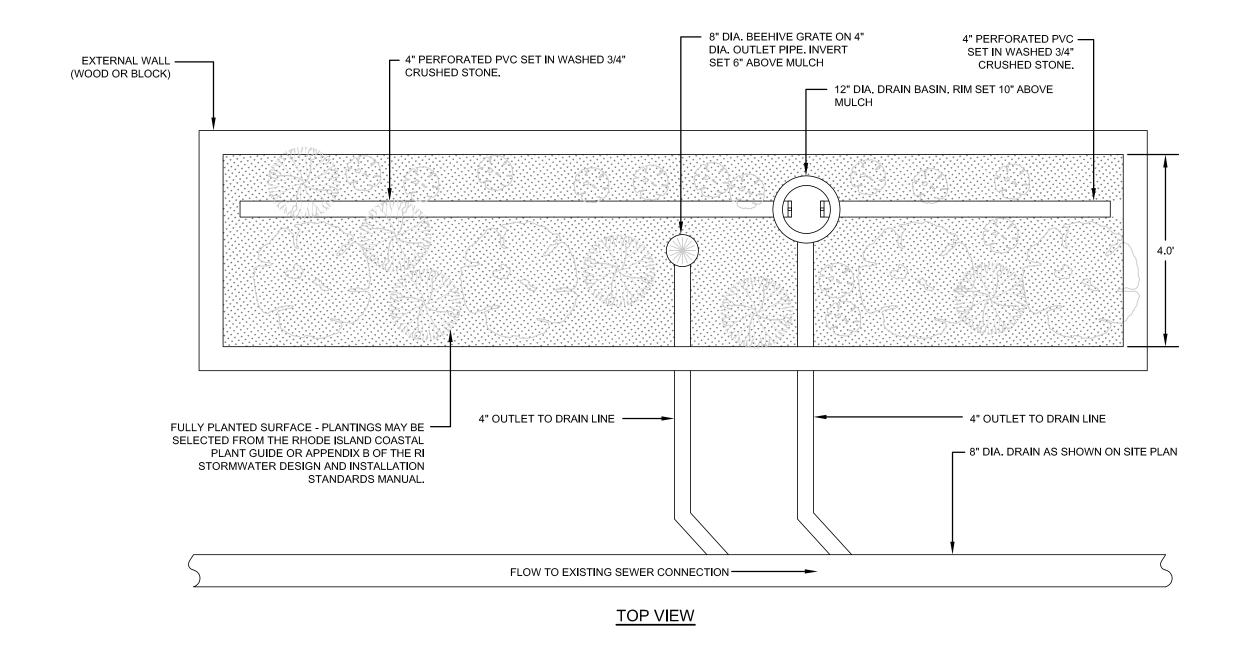
SIDE PROFILE VIEW

— 4" PERFORATED PVC SET IN WASHED 3/4"


CRUSHED STONE.

EXTERNAL WALL ———

(WOOD OR BLOCK)



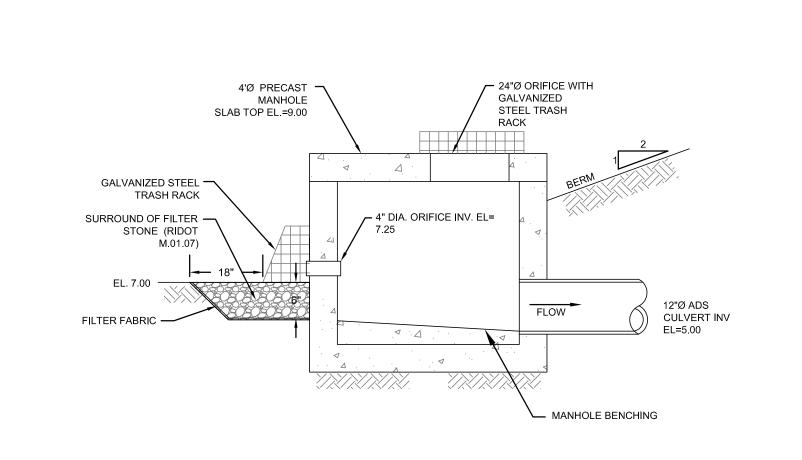STRUCTURAL BIORETENTION FILTER CROSS SECTION (BF-4) SCALE: NOT TO SCALE SCALE: NOT TO SCALE



BIORETENTION BF-6 STONE EDGE INLET TRENCH SCALE: NOT TO SCALE

3-INCHES 3/4" CRUSHED-

PAVEMENT-

SECTION

SURROUND

3/4" CRUSHED -

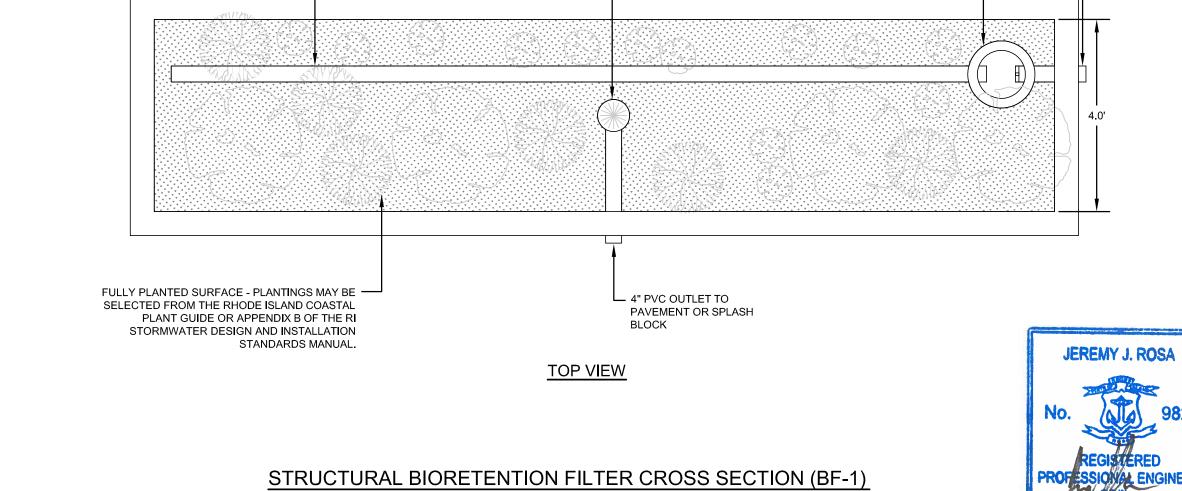
STONE OVER STONE

ENCLOSURE

1. LEVEL SPREADER TO BE PROTECTED FROM SILTATION DURING CONSTRUCTION AND UNTIL ADJACENT VEGETATION IS FULLY

ESTABLISHED. (ENGINEER TO DO FINAL INSPECTION).


BIORETENTION BF-6 OUTLET STRUCTURE DETAIL SCALE: NOT TO SCALE



— 8" DIA. BEEHIVE GRATE ON 4" DIA. OUTLET PIPE. INVERT SET

12" DIA. DRAIN BASIN. RIM SET 10" ABOVE

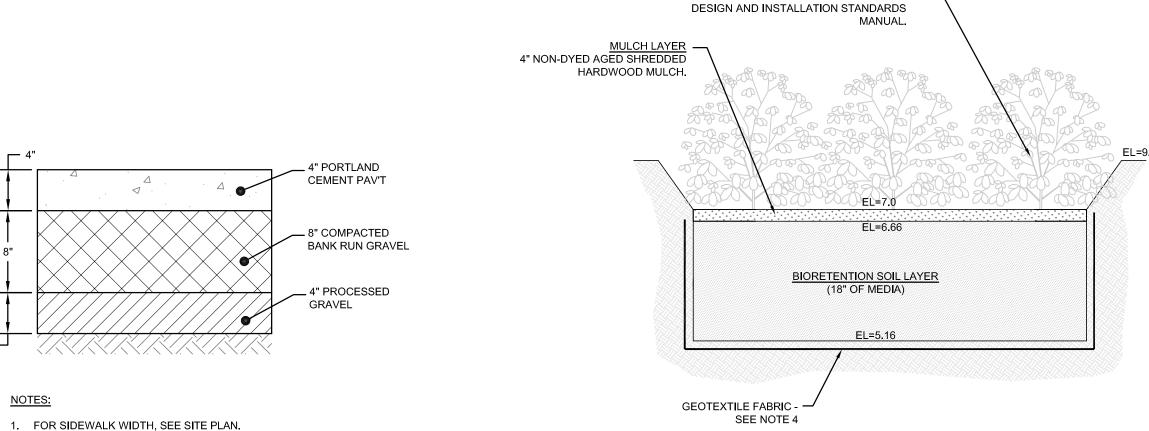6" ABOVE MULCH.



2. LANDSCAPE ARCHITECT MAY SPECIFY ALTERNATE.

TYPICAL CONCRETE WALKWAY

NOTES:

SCALE: NOT TO SCALE

- 1. BIORETENTION FILTER PLANTINGS MAY BE SELECTED FROM THE RHODE ISLAND COASTAL PLANT GUIDE OR APPENDIX B OF THE RI STORMWATER DESIGN AND INSTALLATION STANDARDS MANUAL AND SHOULD BE SELECTED BY A REGISTERED RI LANDSCAPE ARCHITECT.
- 2. PLANTINGS MUST BE DENSE AND COVER THE ENTIRETY OF THE FILTER SURFACE.

PLANTINGS MAY BE SELECTED FROM THE -RHODE ISLAND COASTAL PLANT GUIDE

OR APPENDIX B OF THE RI STORMWATER

- 3. BIORETENTION SOIL SHALL CONSIST OF USDA LOAMY SAND AND MEET THE FOLLOWING GRADATIONS: SAND 85-88% SILT 8-12%, CLAY 0-2%, AND ORGANIC MATTER (LEAF COMPOST) 3-5%.
- 4. GEOTEXTILE FABRIC SHALL HAVE A PUNCTURE STRENGTH OF 125 LBS, A BURST STRENGTH OF 400 PSI (ASTM D 1117) AND A TENSILE STRENGTH OF 300 LBS (ASTM D 1682). FABRIC SHALL BE MIN 0.08" THINK WITH AN EQUIVALENT OPENING SIZE OF #80 SIEVE AND A MINIMUM FLOW RATE OF 125 GPM PER

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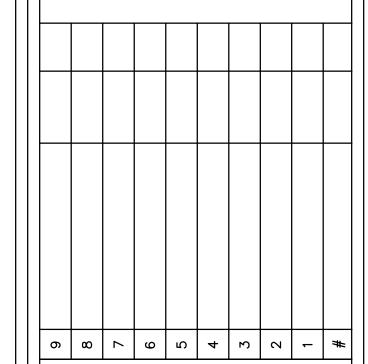
SOLID 4" PVC


OUTLET TO

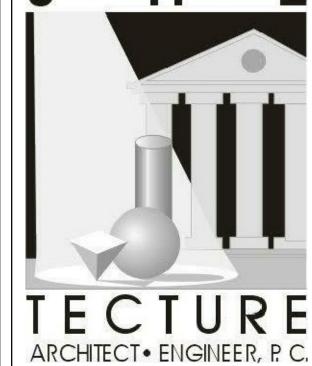PAVEMENT OR SPLASH BLOCK

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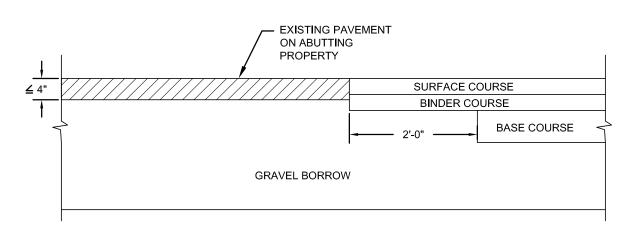
430 KINSLEY AVENUE PROVIDENCE, RI, 02909

SITE DETAILS 2


DRAWING NUMBER: DATE: 02AUG24 SCALE: AS SHOWN DRAWN BY: JJR

PROJECT NUMBER:

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EXISTING PAVEMENT DEPTH LESS THAN 4"




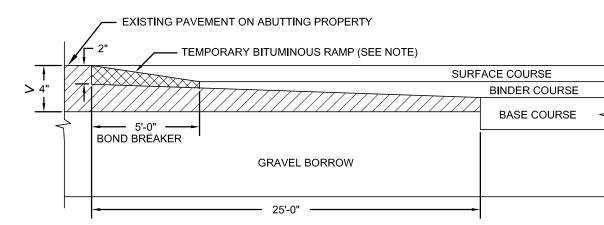
EXISTING PAVEMENT DEPTH GREATER THAN 4"

NOTE:

A BOND BREAKER (TAPERED OR EQUIVALENT) WILL BE PLACED 5'-0" FROM THE JOINT AND COVERED WITH THE BINDER COURSE AS THE TEMPORARY RAMP. PRIOR TO THE SURFACE COURSE, THE BINDER COURSE AND BOND BREAKER WILL BE REMOVED.

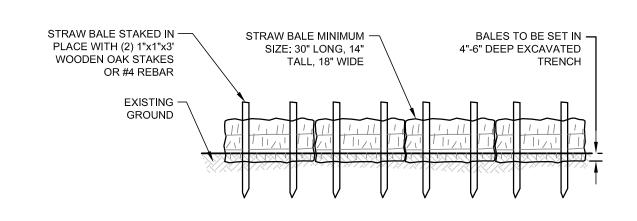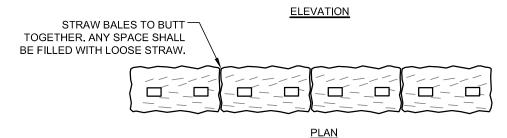TYPICAL CUT AND MATCH PAVEMENT DETAIL SCALE: NOT TO SCALE







NOTES:

- 1. BALE WEIGHT SHALL NOT BE LESS THAN 50 LBS AND SHALL BE BOUND WITH NO LESS THAN TWO STRINGS OR WIRES CONTAINING A MINIMUM OF FIVE (5) CUBIC FEET OF MATERIAL. MINIMUM DIMENSIONS SHOWN IN DETAIL..
- 2. STRAW BALES SHALL BE CERTIFIED AS BEING NOXIOUS WEED-FREE BALES. TO BE "CERTIFIED" MEANS THAT THE PRODUCT IS FREE OF ANY NOXIOUS WEEDS.
- 3. STAKES SHALL BE DRIVEN THROUGH STAKES AT A SLIGHT UPSTREAM ANGLE TO PREVENT BALE FROM OVERTURNING.
- 4. LOOSE STRAW SHALL BE WEDGED BETWEEN BALES AFTER INSTALLATION.
- 5. MATERIAL EXCAVATED FROM TRENCH SHALL BE BACKFILLED, COMPACTED, AND STABILIZED.

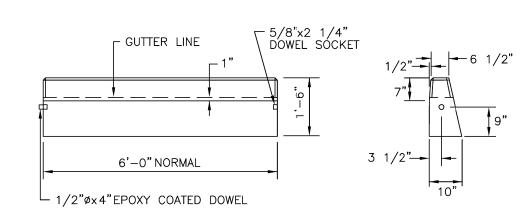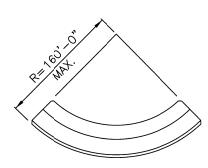BALED STRAW EROSION CONTROL BARRIER






CIRCULAR CURB

NOTES:


1. SHALL BE IN ACCORDANCE WITH SECTION 906 OF THE R.I. STANDARD SPECIFICATIONS. . MINIMUM LENGTH OF STRAIGHT OR CIRCULAR FILLER PIECES TO BE 3'-0". MINIMUM LENGTH OF STRAIGHT OR CIRCULAR FILLER FIECES TO BE 3 = 0.
 EXPOSED SURFACES TO HAVE A SPONGE FLOAT FINISH.
 CIRCULAR CURB IS REQUIRED ON CURVES WITH RADII OF 160'-0" OR LESS. STRAIGHT CURB TO BE USED ON CURVES OF MORE THAN 160'-0" RADIUS. 5. EXPOSED EDGES TO HAVE A 3/4" CHAMFER.

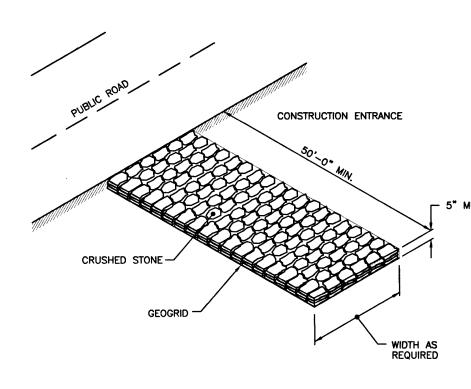PRECAST CONCRETE CURB (RIDOT STD 7.1.0)




NOTE:
SHALL BE IN ACCORDANCE WITH SECTION 211 OF THE R.I. STANDARD SPECIFICATIONS.

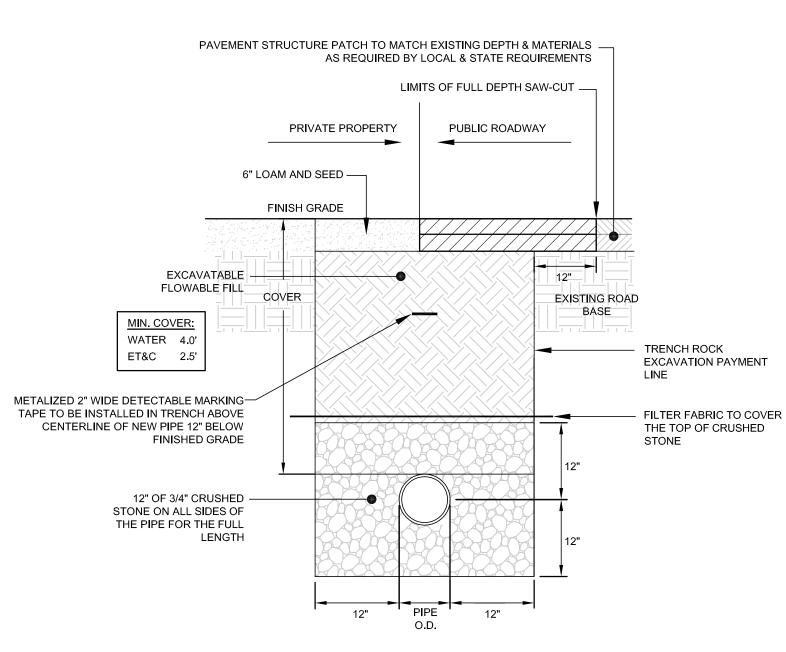STONE CONSTRUCTION ACCESS (RIDOT 9.9.0) SCALE: NOT TO SCALE




UTILITY (NON-SEWER) TRENCH SECTION

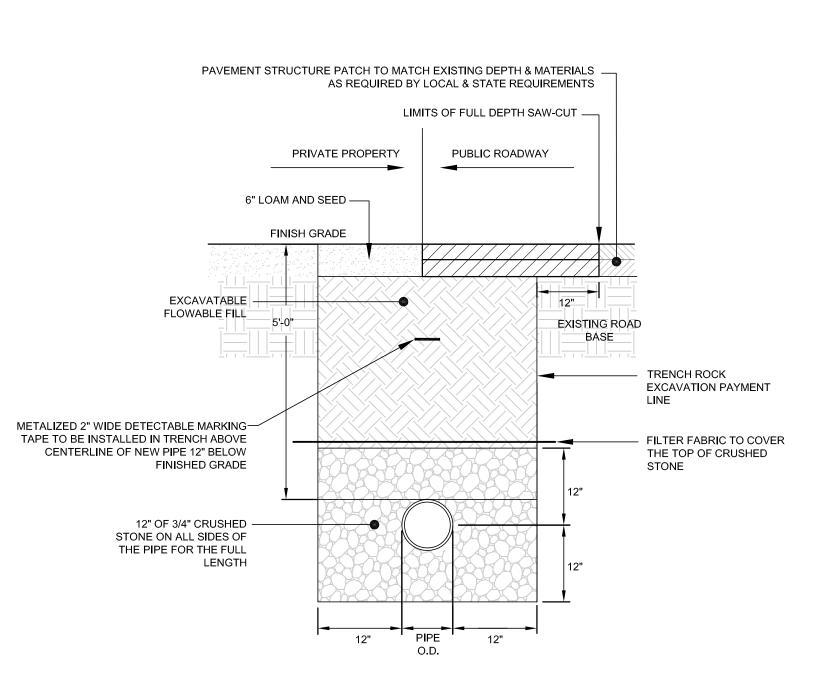


SEWER SERVICE TRENCH SECTION

SCALE: NOT TO SCALE

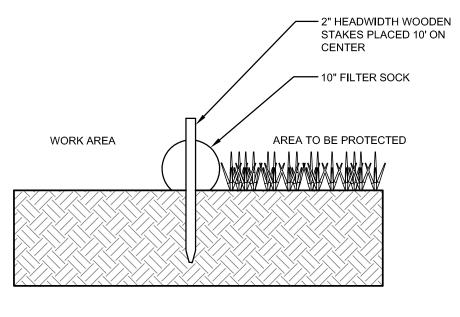NBC ACCEPTED PIPE




SECTION VIEW

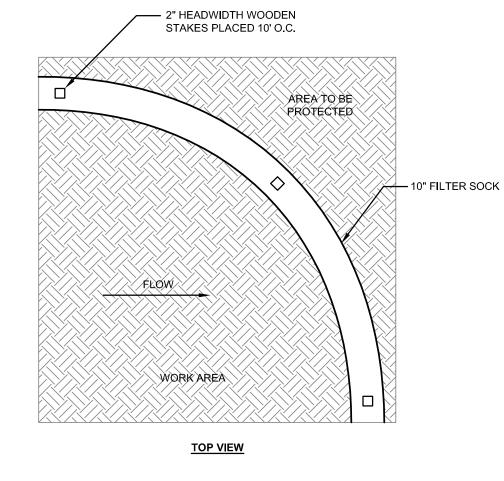


10" FILTER SOCK DETAIL SCALE: NOT TO SCALE

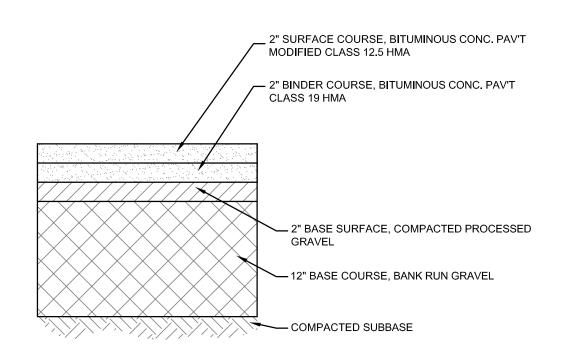PUBLIC ROADWAY



TYPICAL BITUMINOUS PAVEMENT SECTION

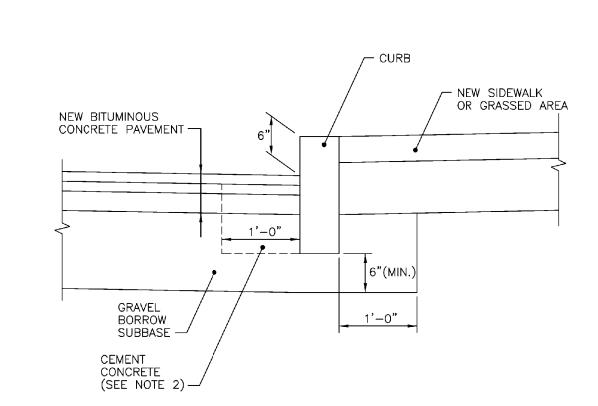SCALE: NOT TO SCALE



NOTES:

1. SHALL BE IN ACCORDANCE WITH SECTION 906 OF THE R.I. STANDARD SPECIFICATIONS. . CEMENT CONCRETE SHALL BE USED ONLY WHEN THE CURB IS SET AFTER THE BASE AND/OR BINDER COURSES ARE IN PLACE, OTHERWISE THE CEMENT CONCRETE WILL BE ELIMINATED AND THE GRAVEL BROUGHT UP TO BOTTOM OF THE BASE COURSE.

CURB SETTING DETAIL (RIDOT STD 7.6.0)
SCALE: NOT TO SCALE

PAVERS WITH 1/2" MIN MORTARLESS GAPS (15% OF TOTAL SURFACE AREA) FILLED -WITH ASTM No. 8 WASHED AGGREGATE. PAVER COLOR, SIZE AND PATTERN TO BE SELECTED BY OWNER. - 1.5" ASTM No. 8 WASHED AGGREGATE — 4" No. 57 WASHED STONE 6" No. 2 WASHED STONE WITH FILTER FABRIC SURROUND

NOTE: PAVER VOID MATERIAL SHALL BE COMPACTED WITH A MINIMUM 5,000 LB. PLATE COMPACTOR.

TYPICAL PERVIOUS PAVER PATIO SECTION SCALE: NOT TO SCALE



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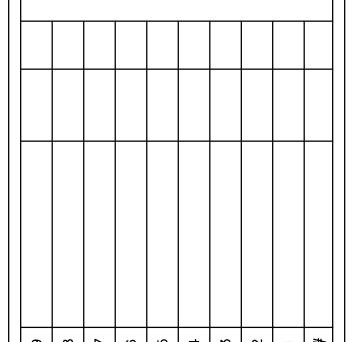
other governing bodies. 6: All work to be performed and inspected as required by the local governing code enforcement office.


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190 High Street
● Bristol RI 02809

ISSUED FOR:

INTERNAL REVIEW GENERAL PLANNING DRAWINGS FOR:

THIS SET IS FOR SCHEMATIC DESIGN DOCUMENTATION AND SHOULD NOT BE USED FOR CONSTRUCTION PURPOSES

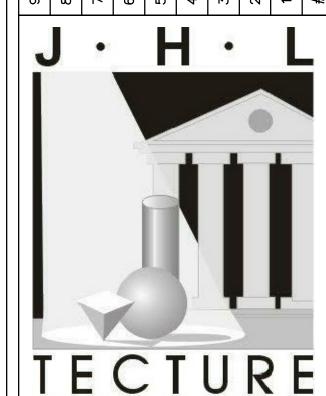GENERAL PLANNING DRAWINGS FOR:

GRACE **HARBOR CHURCH**

430 KINSLEY AVENUE

PROVIDENCE, RI, 02909

SITE DETAILS 3

DRAWING NUMBER: DATE: 28AUG24 SCALE: AS SHOWN DRAWN BY: JJR PROJECT NUMBER:

P:\Projects\2023\23297 - 430 Kinsley Providence\Drawings\Current\SITE\23297_DET.dwg

SCALE: NOT TO SCALE

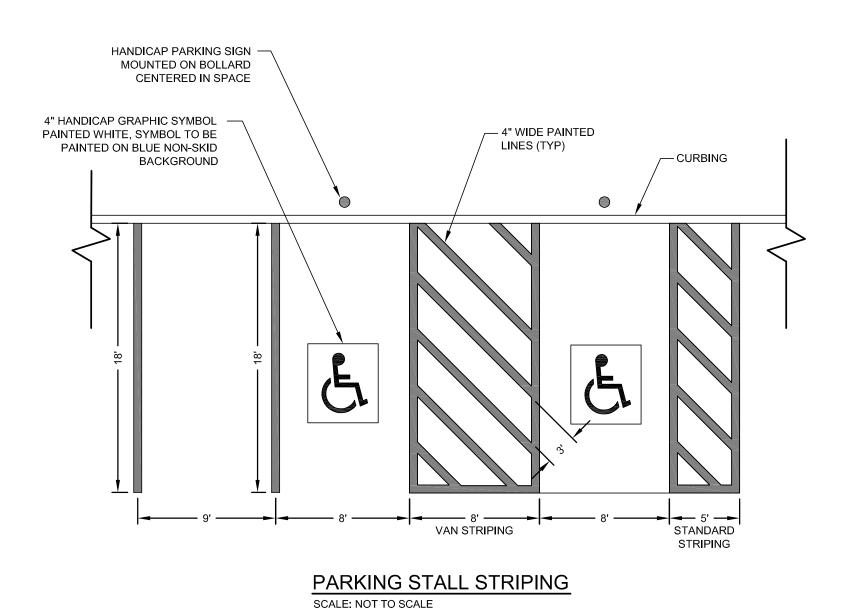
- REMOVABLE PVC THREADED PLUG EAST JORDAN CLEAN-OUT (#00157311 AND ———— 00157324) RIM AND COVER (OR APPROVED - REMOVABLE RUBBER FROM EQUAL) FLUSH IMPERVIOUS OR RAISED IN CLEANOUT CAP LANDSCAPE AREAS CAST IRON OR TRAFFIC TYPE METER BOX OR APPROVED RIM AND COVER SET IN EQUAL MINIMUM 6" CEMENT CONCRETE COLLAR FLOWABLE FILL TO BE USED IN -ALL EXCAVATED AREAS WITHIN THE PUBLIC RIGHT OF WAY 6" VERTICAL PIPE SDR35 **─ ←** FILTER FABRIC TEE WYE -FERNCO — COUPLER - 6" SDR35 SEWER SERVICE **⊸** FLOW EXISTING — - 12" OF 3/4" CRUSHED STONE BELOW AND SEWER STUB ABOVE PIPE **ENCAPSULATED IN 1** CU FT OF 5000 PSI CONCRETE - FILTER FABRIC

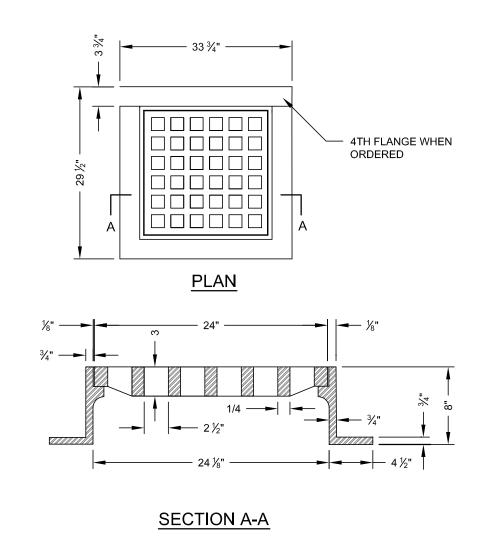
PRIVATE PROPERTY

PRIVATE LATERAL SERVICE


NOT UNDER NBC PURVIEW

SEWER SERVICE CLEANOUT DETAIL






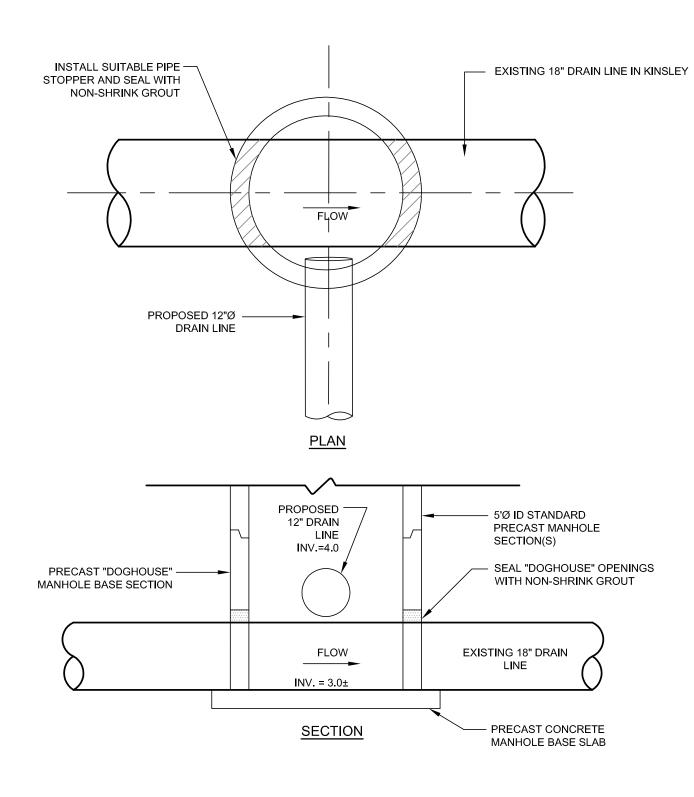SQUARE FRAME AND GRATE (RIDOT 6.3.0) SCALE: NOT TO SCALE




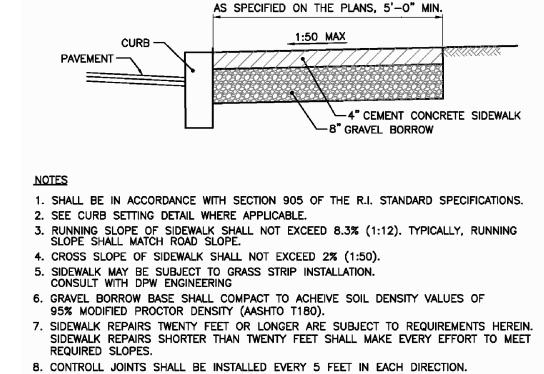DOGHOUSE DRAIN MANHOLE FOR CONNECTION TO MUNICIPAL DRAIN SCALE: NOT TO SCALE




9. EXPANSION JOINTS SHALL BE INSTALLED EVERY 20 FEET IN EACH DIRECTION AT FOUNDATIONS AND WALLS AND IN A SQUARE PATTERN AROUND MANHOLE COVERS, HYDRANTS, SIGN POSTS AND UTILITY POLES. THE EXPANSION JOINT SHALL BE THE FULL DEPTH OF THE SIDEWALK AND FILLED WITH AN APPROVED TYPE OF PREMOLDED EXPANSION JOINT FILLER.

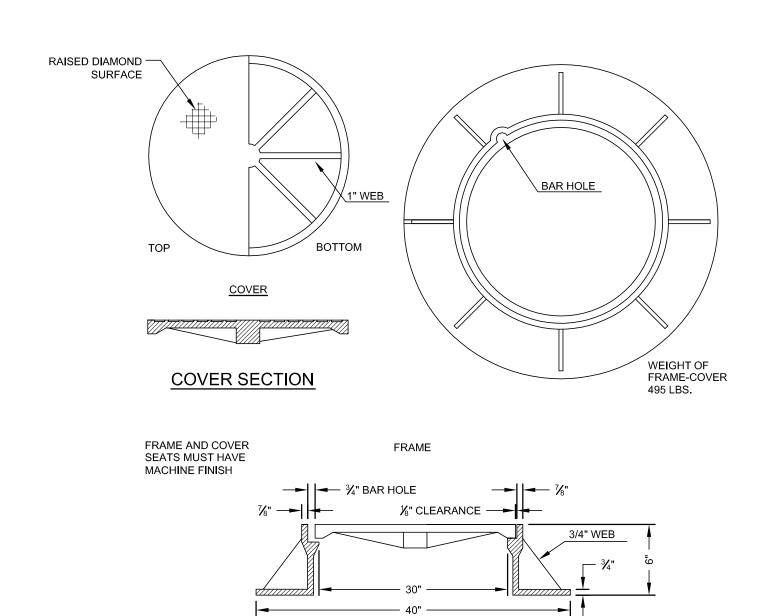CEMENT CONCRETE SIDEWALK (PROV 43.1.0 P) SCALE: NOT TO SCALE



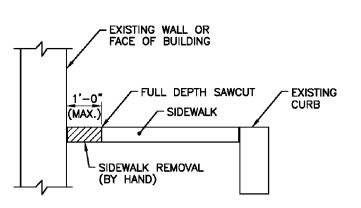ROUND FRAME AND COVER SCALE: NOT TO SCALE



NOTES:

1. IN AREAS WHERE SIDEWALKS ARE TO BE REMOVED IN FRONT OF EXISTING WALLS OR BUILDINGS, THE CONTRACTOR SHALL SAWCUT ONE(1) FOOT (MAXIMUM) IN FRONT OF THE WALL/BUILDING AND REMOVE THE SIDEWALK STRUCTURE BY HAND. 2. IN THE EVENT THAT THE EXISTING SIDEWALK IS A STRUCTURAL ELEMENT OF THE WALL/BUILDING, THE EXISTING SIDEWALK IN FRONT OF THESE STRUCTURES WILL REMAIN IN-PLACE AND A NEW SIDEWALK CONSTRUCTED TO MATCH THE EXISTING SECTION. 3. ANY DAMAGE TO THE WALL OR BUILDING BY THE CONTRACTOR SHALL BE REPAIRED BY THE CONTRACTOR AT NO ADDITIONAL COST TO THE CITY.

CONCRETE SIDEWALK REMOVAL (PROV 43.1.1 P) SCALE: NOT TO SCALE



GENERAL NOTES: 1: DO NOT SCALE DRAWINGS. Notify Architect if additional dimensioning is

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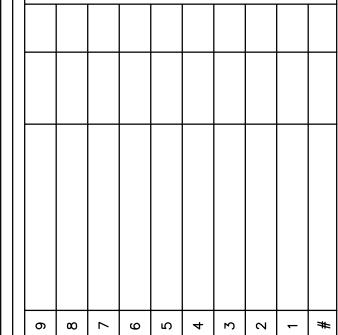
indiccated, graphically, as annotated or as

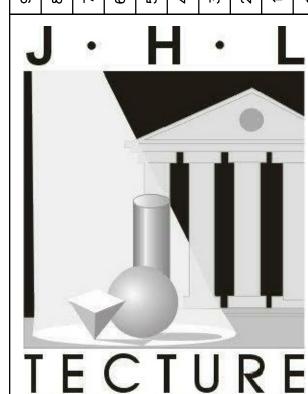
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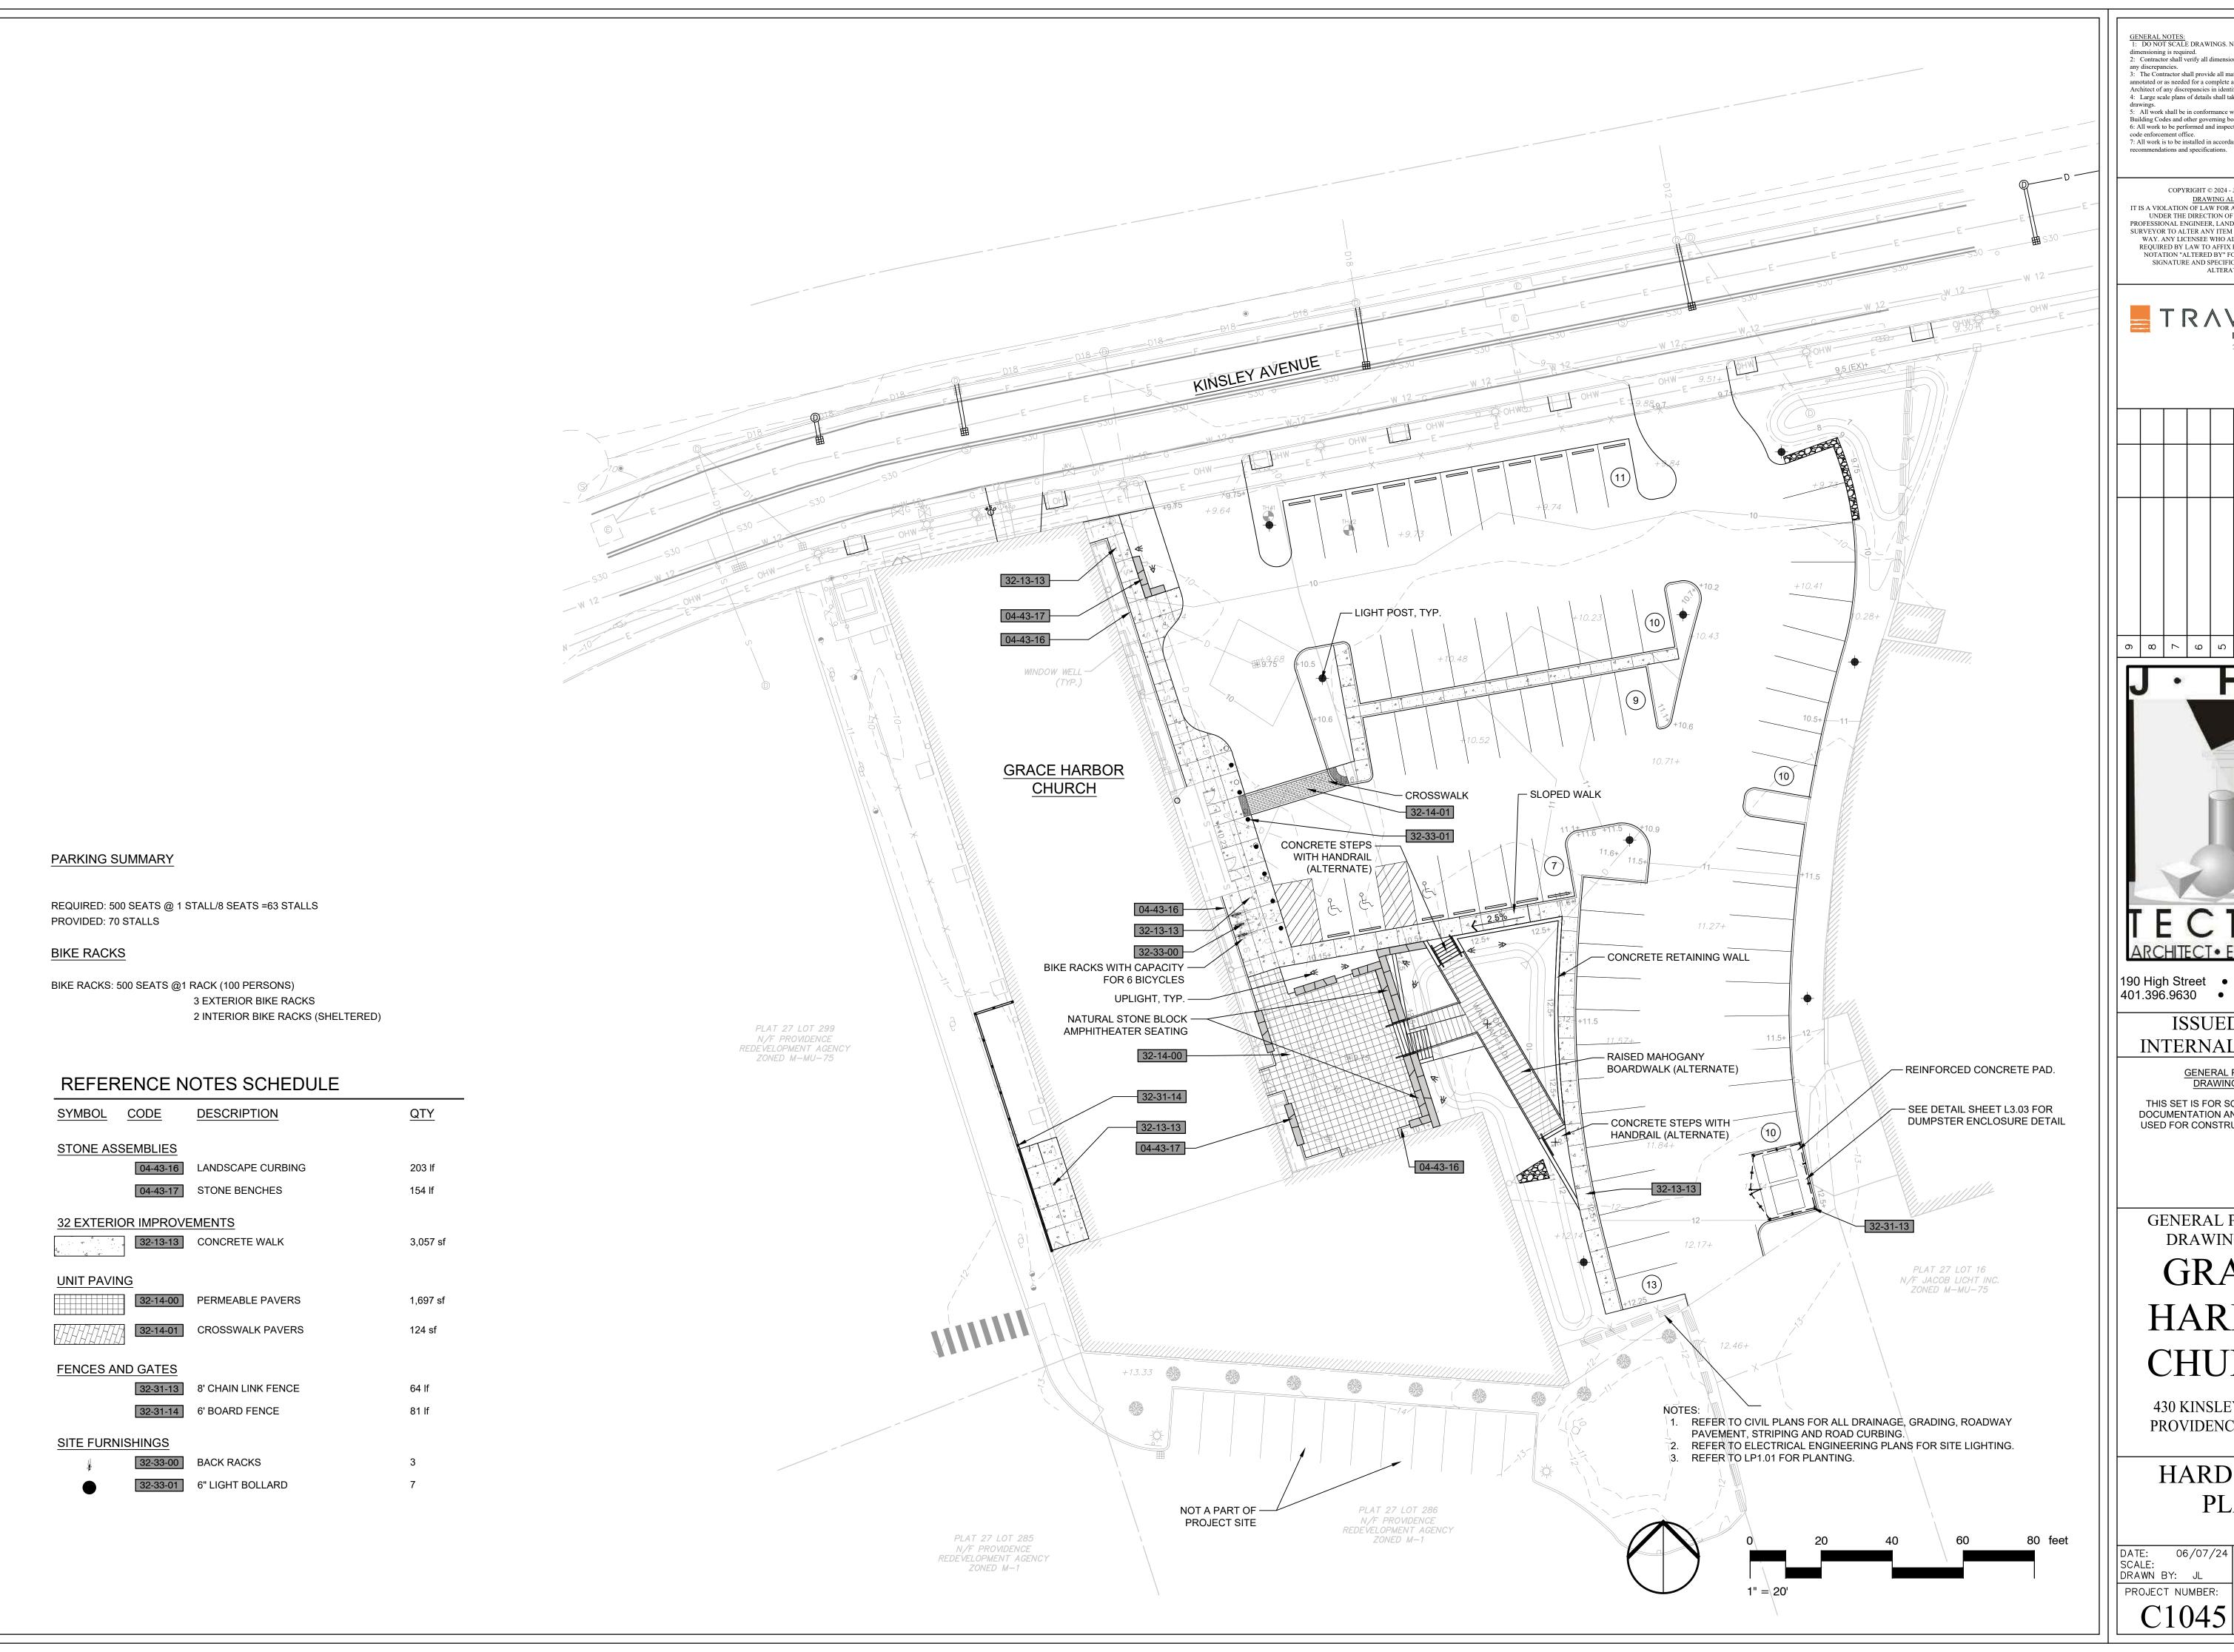
GENERAL PLANNING DRAWINGS FOR:

GRACE **HARBOR CHURCH**

430 KINSLEY AVENUE PROVIDENCE, RI, 02909

SITE DETAILS 4

DRAWING NUMBER: DATE: 12AUG24 SCALE: AS SHOWN DRAWN BY: JJR PROJECT NUMBER:



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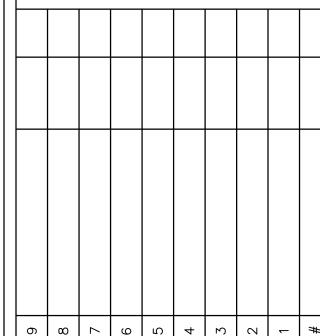
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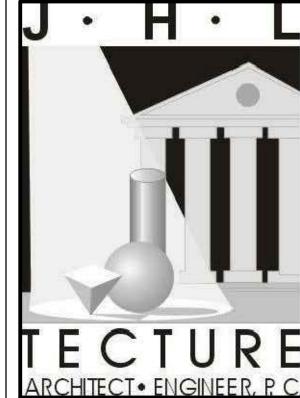
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GRACE HARBOR **CHURCH**


430 KINSLEY AVENUE PROVIDENCE, RI, 02909


HARDSCAPE PLAN

06/07/24 DRAWING NUMBER:

PROJECT NUMBER:

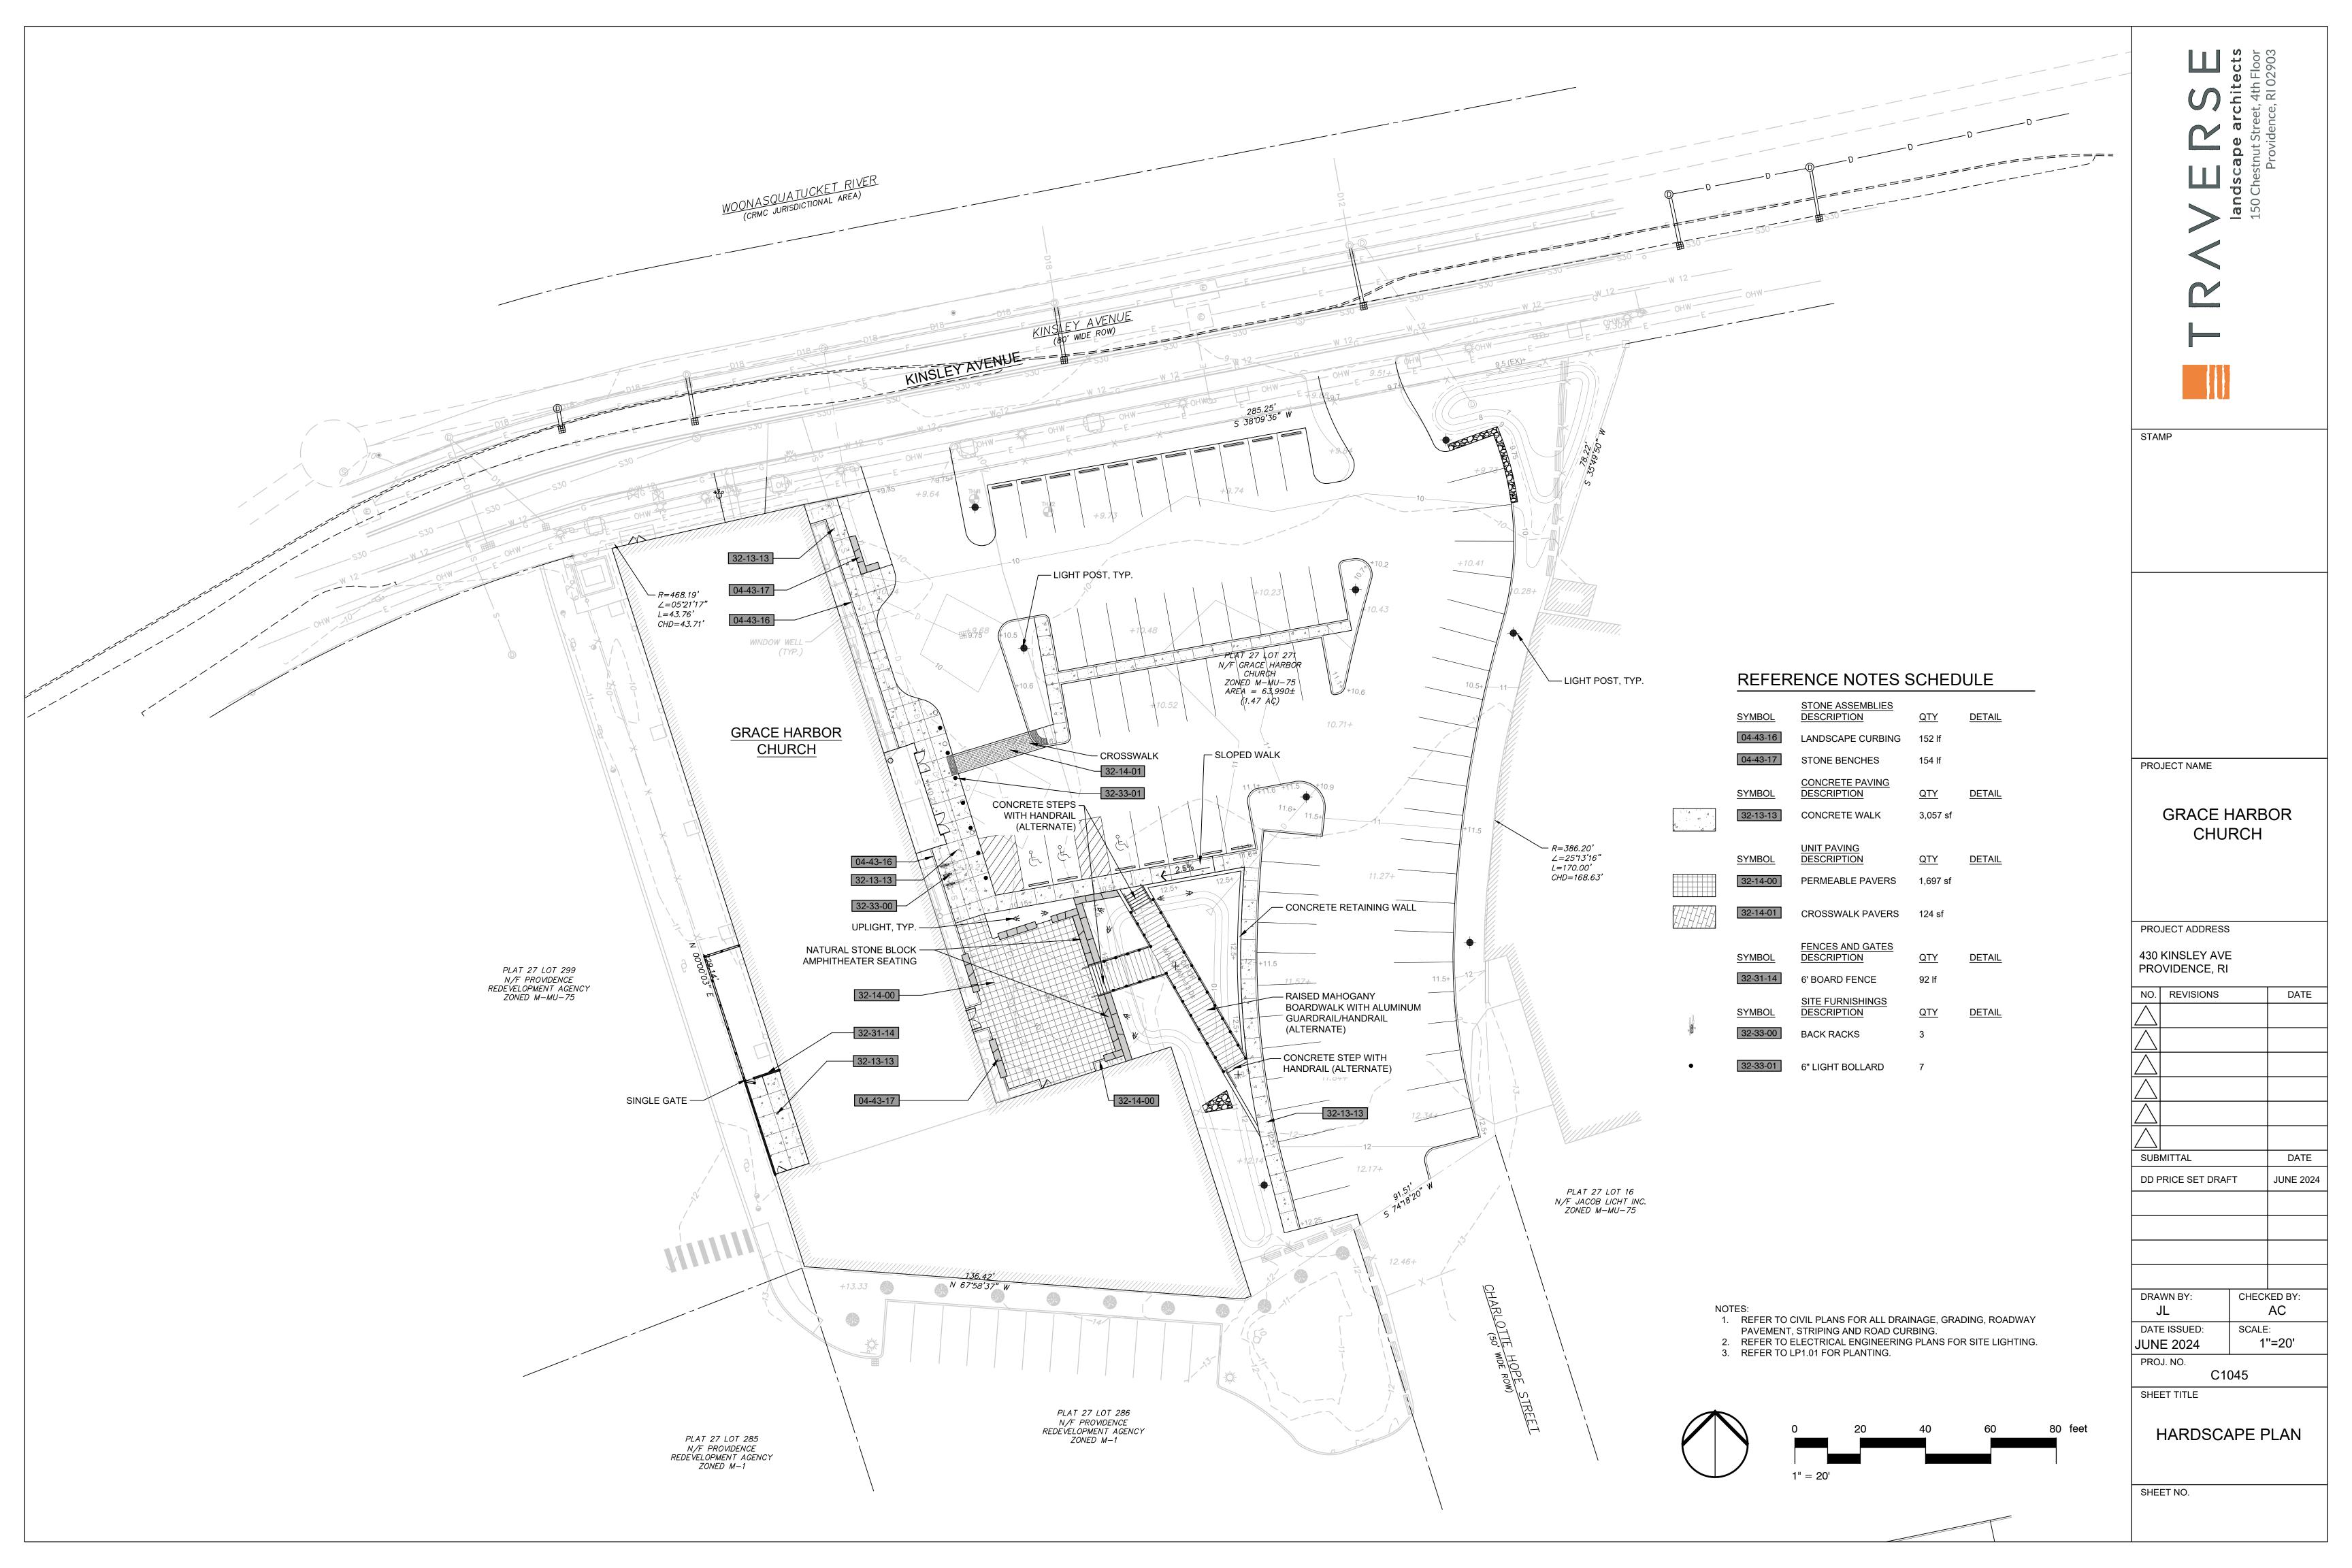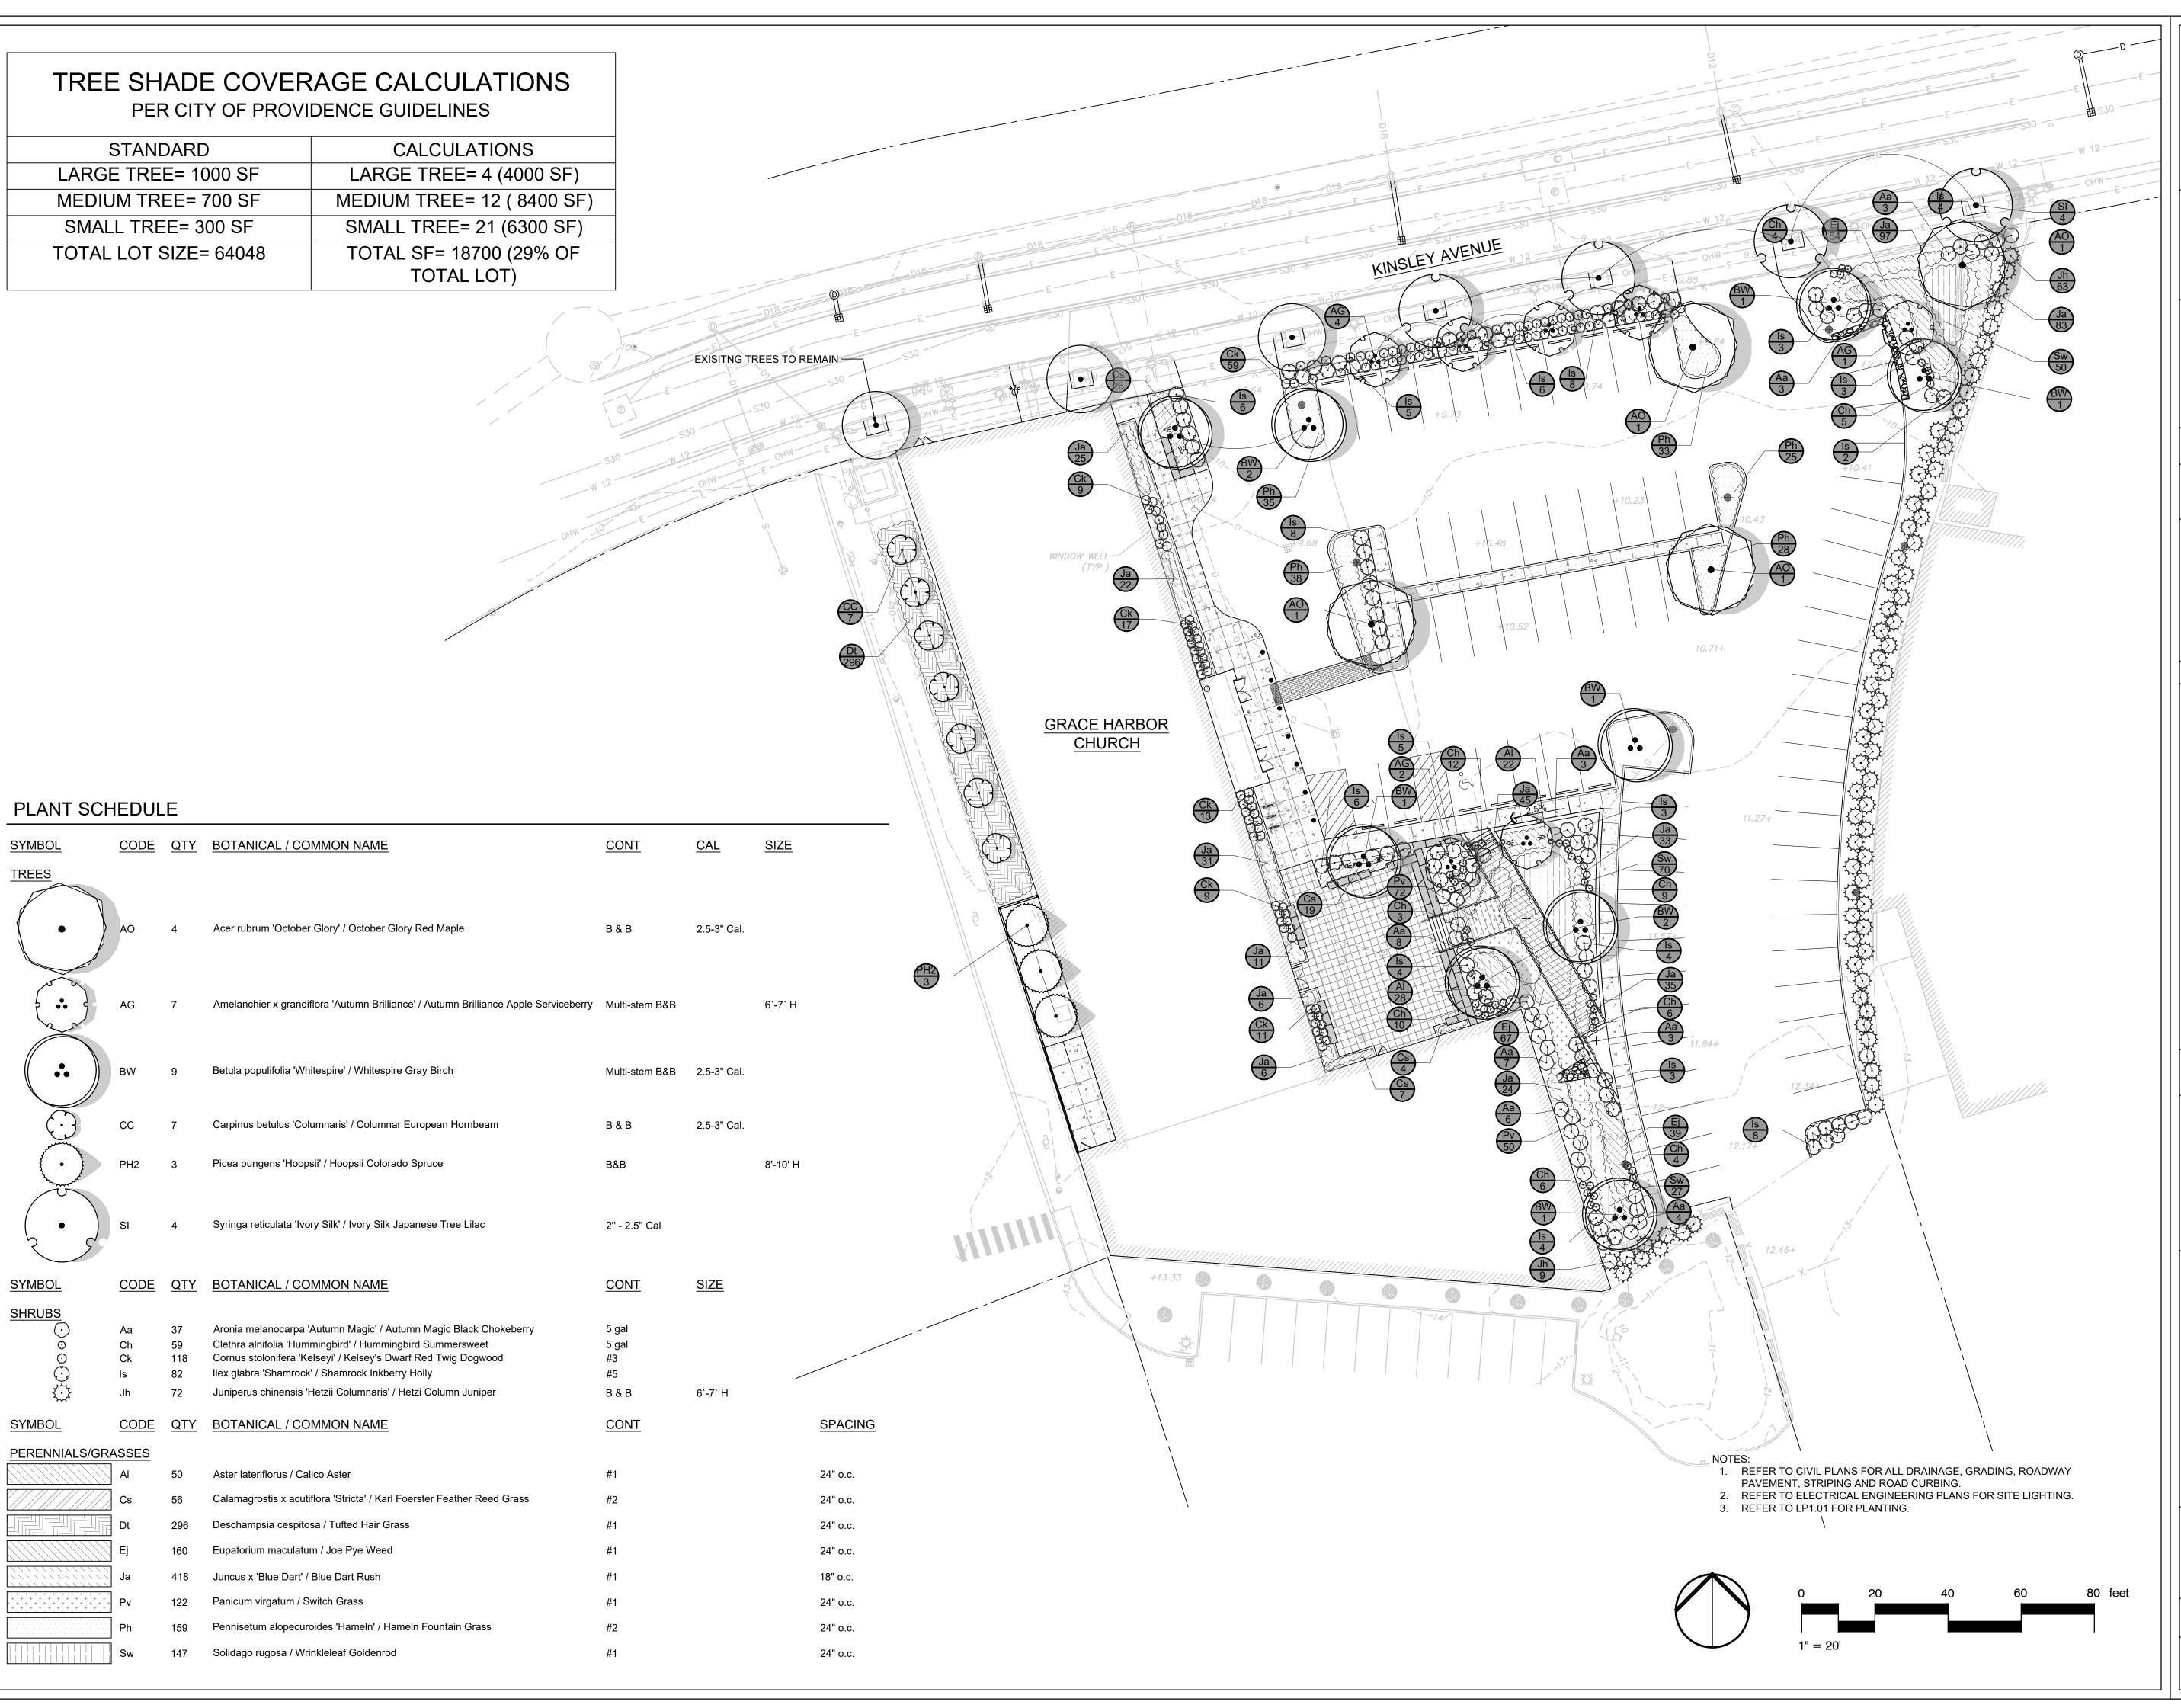C1045





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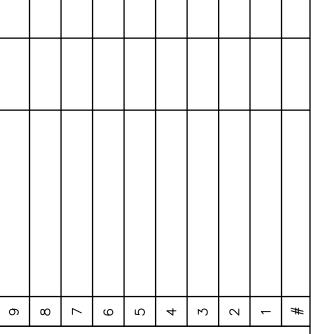
recommendations and specifications.


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430 KINSLEY AVENUE PROVIDENCE, RI, 02909

> PLANTING PLAN

DATE: 06/07/24 DRAWING NUMBER: SCALE: DRAWN BY: JL TP1 01

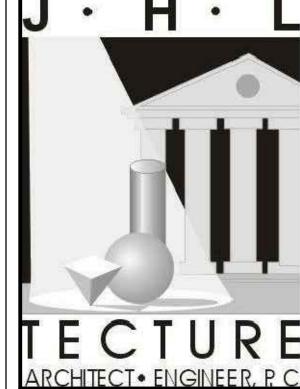PROJECT NUMBER: LP1.01

C1045